COMPONENTS OF CONTRACT PLANS SET ROADWAY PLANS SIGNING AND PAVEMENT MARKING PLANS SIGNAL PLANS

INDEX OF ROADWAY PLANS

SHEET NO.	SHEET DESCRIPTION
1	KEY SHEET
2	SIGNATURE SHEET
3	SUMMARY OF PAY ITEMS
4	TYPICAL SECTIONS
5	GENERAL NOTES
6	CURVE DATA TABLE & BENCHMARK TABLE
7	PROJECT LAYOUT
8-10	ROADWAY PLANS
11	DRAINAGE DETAILS
12-13	SPECIAL DETAILS
14	INTERSECTION DETAILS
15	EROSION CONTROL PLAN
16-17	STORMWATER POLLUTION PREVENTION PLAN
18-19	TRAFFIC CONTROL PLAN
20-22	UTILITY ADJUSTMENT SHEETS
SQ1 - SQ8	SUMMARY OF QUANTITIES SHEETS

TO CLEARWATER

CITY OF TAMPA MOBILITY DEPARTMENT


CONTRACT PLANS

FINANCIAL PROJECT ID 439476-3-58-01 FINANCIAL PROJECT ID 439476-3-58-02 (FEDERAL FUNDS)

E/W GREEN SPINE CYCLE TRACK -PH. 3B FROM 7TH AVE. TO 13TH AVE.

25

TO NORTH TAMPA

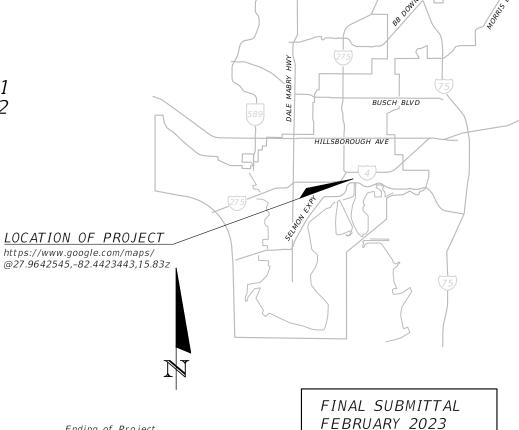

THIS PROJECT TO BE LET TO CONTRACT

WITH FINANCIAL PROJECT ID(S):

439476-4-58-01

Ending of Project Ending of Phase 3B STA. 234+39.71

ENGINEER OF RECORD:

FATHY ABDALLA, P.E. P.E. NO.: 63914

KISINGER CAMPO & ASSOCIATES CORP. 201 N FRANKLIN STREET, SUITE 400

TAMPA, FL, 33602 (813) 871-5331

CONTRACT NO.: 21-C-00022 VENDOR NO.: 59-1677145

CITY OF TAMPA PROJECT MANAGER:

NINA S. MABILLEAU E.I.

CONSTRUCTION	FISCAL	SHEET		
CONTRACT NO.	YEAR	NO.		
21-C-00022	23			

GOVERNING DESIGN STANDARD: FLORIDA DEPARTMENT OF TRANSPORTATION, FY2023-24 DESIGN STANDARDS EBOOK (DSEB) AND APPLICABLE DESIGN STANDARDS REVISIONS (DSRS) AT THE FOLLOWING WEBSITE: https://www.fdot.gov/design/standardplans


GOVERNING STANDARD SPECIFICATIONS: CITY OF TAMPA AND FLORIDA DEPARTMENT OF TRANSPORTATION, FY2023-24 DIVISION II AT THE FOLLOWING WEBSITE: http://www.fdot.gov/programmanagement/Implemented/SpecBooks

Beginning of Phase 3B STA. 211+05.70

TO LAKELAND

TO BRANDON

End Phase 3A

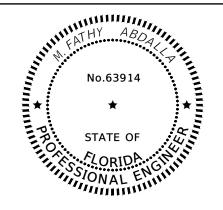

THIS ITEM HAS BEEN DIGITALLY SIGNED AND SEALED BY

M. Fathy 2023.08.04 Abdalla 11:19:36 -04'00'

ON THE DATE ADJACENT TO THE SEAL


PRINTED COPIES OF THIS DOCUMENT ARE NOT CONSIDERED SIGNED AND SEALED AND THE SIGNATURE MUST BE VERIFIED ON ANY ELECTRONIC COPIES.

KISINGER CAMPO & ASSOCIATES CORP. 201 N FRANKLIN ST, SUITE 400, TAMPA, FL 33602 FLORIDA CERTIFICATE OF AUTHORIZATION NO. 02317 FATHY ABDALLA, P.E. NO. 63914

THE ABOVE NAMED PROFESSIONAL ENGINEER SHALL BE RESPONSIBLE FOR THE FOLLOWING SHEETS IN ACCORDANCE WITH RULE 61G15-23.004, F.A.C.

PLAN INDEX

SHEET NO.	SHEET DESCRIPTION
1	KEY SHEET
2	SIGNATURE SHEET
3	SUMMARY OF PAY ITEMS
4	TYPICAL SECTIONS
5	GENERAL NOTES
6	CURVE DATA TABLE & BENCHMARK TABLE
7	PROJECT LAYOUT
8-10	ROADWAY PLANS
12-13	SPECIAL DETAILS
14	INTERSECTION DETAILS
18-19	TRAFFIC CONTROL PLAN
20-22	UTILITY ADJUSTMENT SHEETS
SQ1 -SQ8	SUMMARY OF QUANTITIES SHEETS

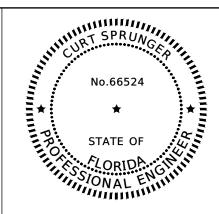

THIS ITEM HAS BEEN DIGITALLY SIGNED AND SEALED BY

Curtis Sprunger Curtis Sprunger din-Curtis Sprunger Chi-Curtis Sprunger din-Curtis Sprunger din-Curtis Sprunger din-Curtis Sprunger din-Curtis Curtis Sprunger din-Curtis Curtis Curtis

ON THE DATE ADJACENT TO THE SEAL

PRINTED COPIES OF THIS DOCUMENT ARE NOT CONSIDERED SIGNED AND SEALED AND THE SIGNATURE MUST BE VERIFIED ON ANY ELECTRONIC COPIES.

KISINGER CAMPO & ASSOCIATES CORP. 201 N FRANKLIN ST, SUITE 400, TAMPA, FL 33602 FLORIDA CERTIFICATE OF AUTHORIZATION NO. 02317 CURT SPRUNGER, P.E. NO. 66524

THE ABOVE NAMED PROFESSIONAL ENGINEER SHALL BE RESPONSIBLE FOR THE FOLLOWING SHEETS IN ACCORDANCE WITH RULE 61G15-23.004, F.A.C.

PLAN INDEX

SHEET NO.	SHEET DESCRIPTION
2	SIGNATURE SHEET
11	DRAINAGE DETAILS
15	EROSION CONTROL PLAN
16-17	STORMWATER POLLUTION PREVENTION PLAN

R E V I S I O N S									
DATE	DESCRIPTION	DATE	DESCRIPTION						

KISINGER CAMPO & ASSOCIATES CORP. 201 N FRANKLIN ST, SUITE 400, TAMPA, FL 33602 ENGINEER OF RECORD: FATHY ABDALLA, P.E. NO: 63914 CITY OF TAMPA
MOBILITY DEPARTMENT

ROAD NO. COUNTY PROJECT DESIGN NO.

HILLSBOROUGH 21-C-00022

SIGNATURE SHEET

SHEET NO.

Christian Tabares 8/2/2023 2:43:17 PM

PHASE 3B - NUCCIO PKWY FROM 7TH AVE TO 13TH AVE

	FLORIDA DEPARTMENT OF TRAN	SPORT AT I OI	V		
	SUMMARY OF PAY ITE	MS			
LEAD PROJECT:	439476-1-58-01 DISTRICT: D7	COUNTY/	SECTION:		
PROJECT:	43947615801 COUNTY: HILLSBOROUGH	COUNTY:	HILLSBOROUGH		
PAY ITEM NO.	ITEM DESCRIPTION	UNIT		QUANT ITY	
PAT TIEM NO.	ITEM DESCRIPTION	UNII	439476 - 3 - 58 - 01	439476 - 3 - 58 - 02	Total
101 1	MOBILIZATION	LS	1		1
102 1	MAINTENANCE OF TRAFFIC	LS	1		1
104 18	INLET PROTECTION SYSTEM	EA	10		10
425 5	MANHOLE, ADJUST	EA	4		4
435 100 2	INLET SPECIAL DRAINAGE GRATE	LF	144		144
110 1 1	CLEARING AND GRUBBING	LS	1		1
110 4 10	REMOVAL OF EXISTING CONCRETE	SY	39		39
327 70 6	MILLING EXISTING ASPHALT PAVEMENT, 1 1/2" AVG DEPTH	SY	6,604		6,604
337 7 83	ASPHALT CONCRETE FRICTION COURSE, TRAFFIC C, FC-12.5, PG 76-22	TN	555		555
520 1 10	CONCRETE CURB & GUTTER, TYPE F	LF	258		258
520 2 4	CONCRETE CURB, TYPE D	LF	199		199
520 70	CONCRETE TRAFFIC SEPARATOR, SP- VAR WIDTH	SY	568		568
522 1	CONCRETE SIDEWALK AND DRIVEWAYS, 4"	SY	27		27
522 2	CONCRETE SIDEWALK AND DRIVEWAYS, 6"	SY	42		42
527 2	DETECTABLE WARNINGS	SF	49		49
570 1 2	PERFORMANCE TURF(SOD)	SY	5		5
9910	ADJUST VALVE BOX (HEIGHT)	EA	2		2
DAY ITEM NO	ITEM DECOMENTAGE			QUANTITY	
PAY ITEM NO.	ITEM DESCRIPTION	UNIT	439476 - 3 - 58 - 01	439476 - 3 - 58 - 02	Total
0523 1 3	PATTERNED PAVEMENT, INCLUDING GREEN BIKE LANE	SY	150		150
0630 2 11	CONDUIT, FURNISH & INSTALL, OPEN TRENCH	LF	10		10
0630 2 12	CONDUIT, FURNISH & INSTALL, DIRECTIONAL BORE	LF	250		250
0632 7 2	SIGNAL CABLE- REPAIR/REPLACE/OTHER, FURNISH & INSTALL	LF	95		95

	FLORIDA DEPARTMENT OF TRANSPORTA	AT I ON					
	SUMMARY OF PAY ITEMS	_					
LEAD PROJECT:	439476-1-58-01 DISTRICT: D7	COUNTY/SECTION:					
PROJECT:	43947615801 COUNTY: HILLSBOROUGH	COUNTY:	H I L L SBOROUGH				
PAY ITEM NO.	ITEM DESCRIPTION	UNIT		QUANTITY			
TAT TIEM NO.	THEM DESCRIPTION	ONTT	439476 - 3 - 58 - 01	439476-3-58-02	Total		
0635 2 11	PULL & SPLICE BOX, F&I, 13" x 24" COVER SIZE	EA	2				
0646 1 11	ALUMINUM SIGNALS POLE, PEDESTAL	EA	2				
0650 1 14	VEHICULAR TRAFFIC SIGNAL, FURNISH & INSTALL ALUMINUM, 3 SECTION, 1 WAY	AS	4				
0670 5400	TRAFFIC CONTROLLER ASSEMBLY, MODIFY	AS	1				
0700 1 11	SINGLE POST SIGN, F&I GROUND MOUNT, UP TO 12 SF	AS	5				
0700 1 18	SINGLE POST SIGN, F&I GROUND MOUNT, IN-STREET FLEXIBLE POST SIGN	AS	8				
0700 1 50	SINGLE POST SIGN, RELOCATE	AS	1				
0700 1 60	SINGLE POST SIGN, REMOVE	AS	1				
0705 11 3	DELINEATOR, FLEXIBLE HIGH VISABILITY MEDIAN	EA	11		1		
0710 90	PAINTED PAVEMENT MARKINGS, FINAL SURFACE	LS	1				
0711 11123	THERMOPLASTIC, STANDARD, WHITE, SOLID, 12" FOR CROSSWALK AND ROUNDABOUT	LF	480		48		
0711 11124	THERMOPLASTIC, STANDARD, WHITE, SOLID, 18" FOR DIAGONALS AND CHEVRONS	LF	63		6.		
0711 11125	THERMOPLASTIC, STANDARD, WHITE, SOLID, 24" FOR STOP LINE AND CROSSWALK	LF	101		10		
0711 11141	THERMOPLASTIC, STANDARD, WHITE, 2-4 DOTTED GUIDELINE/ 6-10 GAP EXTENSION, 6"	GM	0.252		0.25.		
0711 11160	THERMOPLASTIC, STANDARD, WHITE, MESSAGE OR SYMBOL	EA	2				
0711 11170	THERMOPLASTIC, STANDARD, WHITE, ARROW	EA	23		2.		
0711 11224	THERMOPLASTIC, STANDARD, YELLOW, SOLID, 18" FOR DIAGONAL OR CHEVRON	LF	32		3.		
0711 14125	THERMOPLASTIC, PREFORMED, WHITE, SOLID, 24" FOR CROSSWALK	LF	340		34		
0711 14160	THERMOPLASTIC, PREFORMED, WHITE, MESSAGE	EA	18		1		
0711 16101	THERMOPLASTIC, STANDARD-OTHER SURFACES, WHITE, SOLID, 6"	GM	0.394		0.39		
0711 16102	THERMOPLASTIC, STANDARD-OTHER SURFACES, WHITE, SOLID, 8"	GM	0.032		0.03		
0711 16201	THERMOPLASTIC, STANDARD-OTHER SURFACES, YELLOW, SOLID, 6"	GM	0.469		0.46		
0711 16231	THERMOPLASTIC, STANDARD-OTHER SURFACES, YELLOW, SKIP, 6"	GM	0.303		0.30		

	R E V I S I O N S								
DATE	DESCRIPTION	DATE	DESCRIPTION						

CITY OF TAMPA
MOBILITY DEPARTMENT


ROAD NO. COUNTY PROJECT DESIGN NO.

HILLSBOROUGH 21-C-00022

SUMMARY OF PAY ITEMS - (1)

SHEET NO.

Christian Tabares 8/2/2023 2:43:18 PM

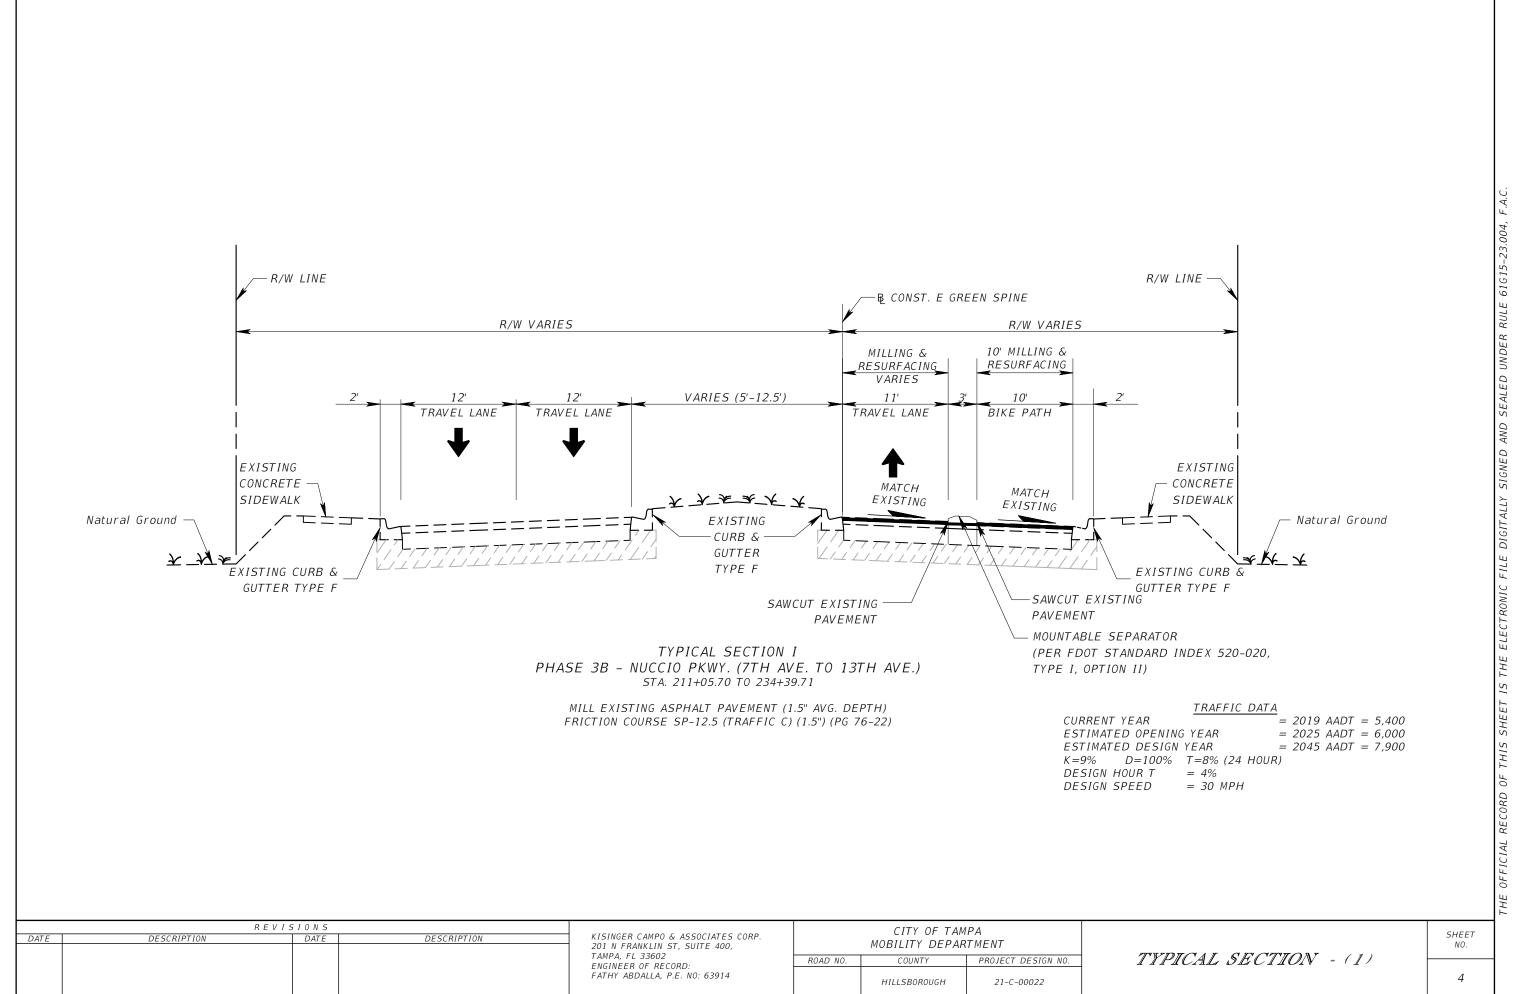

Christian Tabares

8/2/2023 2:43:24 PM

G:\2201706 Green Spine Cycle Track-COT\Civil\AutoCAD-Current\TYPSRD01.dwg

GENERAL NOTES

- BENCHMARK ELEVATIONS SHOWN ON THE PLANS ARE NORTH AMERICAN VERTICAL DATUM OF 1988 (NAVD 88).
- 2. EXISTING DRAINAGE STRUCTURES WITHIN CONSTRUCTION LIMITS SHOULD REMAIN UNLESS OTHERWISE NOTED.
- 3. IF ANY PUBLIC LAND CORNER WITHIN THE LIMITS OF CONSTRUCTION IS IN DANGER OF BEING DESTROYED AND HAS NOT BEEN PROPERLY REFERENCED, IMMEDIATELY NOTIFY THE ENGINEER IN CONJUNCTION WITH THE CITY SURVEYOR, CLARENCE "LUCKY" WADE (813) 635-3430.
- 4. PROPOSED CONCRETE SIDEWALK TO BE 4" CONCRETE. SIDEWALK CROSSING DRIVEWAYS TO BE 6" CONCRETE.
- 5. AREAS DISTURBED OUTSIDE THE PAVEMENT SHALL BE RESTORED TO THEIR ORIGINAL NEW CONDITION. GRASSED AREAS DISTURBED SHALL BE RESTORED WITH PERFORMANCE SOD.
- 6. MAINTAIN ONE COMPLETE SET OF CONTRACT DOCUMENTS AT THE SITE, THESE DOCUMENTS SHALL INCLUDE BUT NOT BE LIMITED TO CONTRACT DOCUMENTS AND SPECIFICATIONS, AND ANY TECHNICAL OR REFERENCE DOCUMENTS THAT MAY BE RELATIVE. AS THE WORK PROGRESSES RECORD ON ONE SET OF REPRODUCIBLE DRAWINGS ALL CHANGES AND DEVIATIONS FROM THE ORIGINAL PLANS. RECORD THE EXACT LOCATION OF ALL CHANGES IN VERTICAL AND HORIZONTAL ALIGNMENT BY OFFSETS AND TIES TO PERMANENT IMPROVEMENTS SUCH AS STRUCTURES AND CURBS. ALL DEVIATIONS FROM THESE PLANS SHALL BE APPROVED BY THE ENGINEER.
- 7. ALL WORK AND MATERIALS WHICH DO NOT CONFORM TO THE CITY'S SPECIFICATIONS ARE SUBJECT TO REMOVAL AND REPLACEMENT WITH APPROVED MATERIALS FOR NO ADDITIONAL PAYMENT.
- 8. ANY WORK PERFORMED WITHOUT THE KNOWLEDGE OF THE CITY IS SUBJECT TO RE-EXCAVATION, REMOVAL AND REPLACEMENT OF SAME TO BE DONE FOR NO ADDITIONAL PAYMENT.
- 9. PROVIDE SUFFICIENT PERSONNEL AND EQUIPMENT ON THE JOB AT ALL TIMES DURING CONSTRUCTION TO SATISFY THE SPECIFICATIONS AND COMPLETE WORK.
- 10. VERIFY ALL QUANTITIES SHOWN ON THE PLANS. IF ANY DISCREPANCIES IN QUANTITIES ARE FOUND, NOTIFY THE PROJECT ENGINEER AND THE CITY.
- 11. ALL REGULATORY AND PERMITTING AGENCIES' REQUIREMENTS SHALL BE COMPLIED WITH.
- 12. APPROPRIATE TURBIDITY CONTROL DEVICES (E.G. SILT FENCES, SYNTHETIC BALES) WILL BE UTILIZED DURING ALL PHASES OF INSTALLATION AND GRADING. CONTRACTOR IS RESPONSIBLE FOR SUBMITTING THE NOTICE OF INTENT AND NOTICE OF TERMINATION TO THE EPA IN COMPLIANCE WITH THE CITY NPDES PERMIT. CONTRACTOR IS RESPONSIBLE FOR DEVELOPING AND MAINTAINING AN EFFECTIVE STORM WATER POLLUTION PREVENTION PLAN.
- 13. LOCATIONS, ELEVATIONS, AND DIMENSIONS OF EXISTING UTILITIES, STRUCTURES AND OTHER FEATURES ARE SHOWN ACCORDING TO THE BEST INFORMATION AVAILABLE AT THE TIME OF PREPARATION OF THESE PLANS, BUT DO NOT PURPORT TO BE ABSOLUTELY CORRECT. PRIOR TO CONSTRUCTION, THE CONTRACTOR SHOULD VERIFY AND SHOULD BE FULLY RESPONSIBLE FOR ANY AND ALL DAMAGES WHICH MIGHT BE OCCASIONED BY HIS FAILURE TO EXACTLY LOCATE AND PRESERVE ANY AND ALL EXISTING UTILITIES, STRUCTURES, AND OTHER FEATURES AFFECTING HIS WORK. ANYTHING NOT SHOWN ON THESE DRAWINGS SHOULD BE BROUGHT TO THE ATTENTION OF THE ENGINEER AND SHOULD NOT CONSTITUTE AN EXTRA, UNLESS APPROVED BY THE ENGINEER.
- 14. CONTACT THE ENGINEER AND CITY IMMEDIATELY CONCERNING ANY CONFLICTS WITH THE CITY'S UTILITIES/STRUCTURES ARISING DURING CONSTRUCTION OF ANY FACILITIES SHOWN ON THESE DRAWINGS.
- 15. VERIFY ALL UTILITIES AND PROVIDE AT LEAST 48 HOURS NOTICE TO THE INDIVIDUAL UTILITY AGENCY OWNERS AND CITY PRIOR TO CONSTRUCTION.
- 16. REPLACE ALL PAVEMENT, CURBS, DRIVEWAYS, SIDEWALKS, FENCES, ETC., WITH THE SAME TYPE OF MATERIAL THAT WAS REMOVED DURING CONSTRUCTION OR AS DIRECTED BY THE ENGINEER. THE CONTRACTOR SHOULD RESTORE ALL AREAS AFFECTED BY THE CONSTRUCTION TO ITS ORIGINAL CONDITION, OR BETTER.
- 17. THE INFORMATION PROVIDED IN THESE PLANS IS SOLELY TO ASSIST THE CONTRACTOR IN ASSESSING THE NATURE AND EXTENT OF THE CONDITIONS WHICH MAY BE ENCOUNTERED DURING THE COURSE OF WORK. ALL CONTRACTORS ARE DIRECTED, PRIOR TO BIDDING, TO CONDUCT WHATEVER INVESTIGATIONS THEY MAY DEEM NECESSARY TO ARRIVE AT THEIR OWN CONCLUSION REGARDING THE ACTUAL CONDITIONS THAT WILL BE ENCOUNTERED, AND UPON WHICH THEIR BIDS WILL BE BASED.
- 18. ALL FRAMES, COVERS, VALVE BOXES, METER BOXES, FIRE HYDRANTS AND MANHOLES SHALL BE ADJUSTED TO FINISHED GRADE UPON COMPLETION OF PAVING OR RELATED CONSTRUCTION. ALL VALVE PADS SHALL BE POURED IN PLACE. NO PRE-FORMED VALVE PADS ALLOWED.
- 19. EXISTING UTILITIES NOT BEING RELOCATED, ARE TO REMAIN IN SERVICE.

Christian Tahares

- 20. CONTRACTOR SHOULD MAINTAIN ALL VEHICLE DETECTION THROUGHOUT THE ENTIRETY OF THE PROJECT AND UNTIL THE REPLACED DETECTION DEVICES HAVE PASSED INSPECTION
- 21. CONTRACTOR SHOULD COORDINATE WITH THE ADJACENT RRFB PROJECT BY CITY OF TAMPA FOR IMPLEMENTING A MIDBLOCK CROSSING BY THE ADJACENT PROJECT AT APPROX. STA. 224+50.

8/2/2023 2:43:31 PM

22. THIS PROJECT IS TO BE CONSTRUCTED COMPLETELY WITHIN TRANSPORTATION RIGHT-OF-WAY.

CONSTRUCTION NOTES

- 1. DO NOT EXCAVATE ANY AREAS THAT CANNOT BE SAFELY REOPENED TO TRAFFIC WITHIN THE SAME WORK PERIOD.
- 2. USE APPROPRIATE MEASURES TO PREVENT EROSION AND TRANSPORT OF SEDIMENT MATERIAL TO INLETS, SURFACE DRAINS, LAKES, AND WETLANDS. THE CONTRACTOR SHOULD USE INLET PROTECTION SYSTEMS AND SEDIMENT BARRIERS OR OTHER APPROPRIATE MEASURES TO PREVENT ADVERSE IMPACTS TO EXISTING SURFACE WATER QUALITY.
- 3. CHECK ALL EROSION AND SILTATION CONTROL DEVICES AFTER EACH RAINFALL AND REPAIR OR REPLACE THEM AS NEEDED..
- 4. CHECK ALL FUGITIVE DUST GENERATED BY CONSTRUCTION ACTIVITIES IN THE PROJECT BY WATERING OR OTHER METHODS AS REQUIRED.
- ALL UNSUITABLE MATERIAL ENCOUNTERED DURING CONSTRUCTION, AS DETERMINED BY THE CITY CONSTRUCTION INSPECTOR, SHALL BE REMOVED AND REPLACED WITH CLEAN FILL.
- 6. HISTORIC GRANITE CURBS WILL REMAIN IN PLACE THROUGHOUT THE PROJECT AND IN LOCATIONS WHERE CURB WORK IS ANTICIPATED, GRANITE CURBS WILL BE RE-INSTALLED
- 7. THIS PROJECT IS TO BE CONSTRUCTED COMPLETELY WITHIN TRANSPORTATION RIGHT-OF-WAY.

STORMWATER NOTES

- 1. PROPOSED SIDEWALK SHALL NOT IMPEDE HISTORICAL DRAINAGE FLOW PATTERNS.
- 2. SIGNED AND SEALED AS-BUILT DRAWINGS WITH SURVEYED ELEVATION DATA SHALL BE SUBMITTED TO THE CITY OF TAMPA STORMWATER ENGINEERING SECTION (ATTENTION BARBARA GRAVE).
- 3. ALL PROPOSED PIPE TO BE RCP CLASS II.

	CN0331NO DI TITE ADJACENI I NOJECI A	ATTAC	M. 31A. 224+30					
	REVIS	10NS				CITY OF TAM	РΔ	
DATE	DESCRIPTION	DATE	DESCRIPTION	KISINGER CAMPO & ASSOCIATES CORP. 201 N FRANKLIN ST, SUITE 400, MOBILITY DEPA				
							7 7 7 2 7 7 7	
				TAMPA, FL 33602 ENGINEER OF RECORD:	ROAD NO.	COUNTY	PROJECT DESIGN NO.	
				FATHY ABDALLA, P.E. NO: 63914		HILLSBOROUGH	21-C-00022	

GENERAL NOTES - (1)

SHEET

	CURVE DATA TABLE														
NUMBER	PC STA.	PI STA.	PT STA.	Т	D	Δ	DIRECTION	L	R	PC NORTH.	PC EAST.	PI NORTH.	PI EAST.	PT NORTH.	PT EAST.
C9	207+86.17	208+22.34	208+58.37	36.17	012° 03' 44"	008° 42′ 33″	RT	72.202	475.000	1318249.3720	511954.3413	1318285.5417	511954.6148	1318321.2529	511960.3620
C10	208+86.89	209+16.71	209+46.38	29.81	016° 22' 13"	009° 44′ 17″	LT	59.486	350.000	1318349.4144	511964.8942	1318378.8503	511969.6315	1318408.6633	511969.3216
C11	219+33.31	221+04.08	222+20.25	170.77	027° 13′ 08″	078° 06′ 03″	RT	286.936	210.500	1319395.5828	511971.4403	1319566.3475	511972.1596	1319600.8538	512139.4032
C12	230+99.19	232+60.90	233+71.16	161.71	028° 38′ 52″	077° 54′ 53″	LT	271.974	200.000	1319778.4594	513000.2132	1319811.1359	513158.5879	1319972.8420	513159.7941

<u>BENCHMARKS</u>

<u>Benchmark</u> <u>Name</u>	<u>St a.</u>	<u>Off set</u>	<u>Side</u>	<u>East</u>	<u>North</u>	Elev.	<u>Description</u>			
BM 509	207+73.49	34.11	Rt.	511 988.352	1 318 236.436	21.73	Nail & Disc "City of Tampa TS&S Survey Control"			
BM510	211+04.51	47.98	Lt.	511 919.966	1 318 566.986	23.69	Nail & Disc "City of Tampa TS&S Survey Control"			
BM511	213+00.09	34.74	Rt.	512 003.516	1 318 762.216	25.33	Nail & Disc stamped "City of Tampa Trans. Div. Survey Control"			
BM512	215+97.17	47.94	Lt.	511 922.086	1 319 059.648	28.30	Nail & Disc "City of Tampa TS&S Survey Control"			
BM513	219+07.09	49.30	Lt.	511 922.027	1 319 369.571	33.79	Nail & Disc "City of Tampa TS&S Survey Control"			
BM514	221+07.36	46.64	Lt.	512 008.601	1 319 584.629	40.93	Nail & Disc "City of Tampa TS&S Survey Control"			
BM515	225+27.66	30.21	Rt.	512 446.581	1 319 633.383	38.65	Nail & Disc "City of Tampa TS&S Survey Control"			
BM516	229+89.72	29.87	Rt.	512 899.034	1 319 727.081	32.37	Nail & Disc "City of Tampa TS&S Survey Control"			
BM517	232+58.60	37.60	Rt.	513 159.798	1 319 846.062	32.89	Nail & Disc "City of Tampa TS&S Survey Control"			
BM518	234+65.11	25.10	Rt.	513 203.568	1 320 048.336	34.82	Nail & Disc "City of Tampa TS&S Survey Control"			
BM519	228+96.62	227.09	Lt.	512 745.832	1 320 008.898	35.10	Nail & Disc "City of Tampa TS&S Survey Control"			

	R E V I S I O N S									
DATE	DESCRIPTION	DATE	DESCRIPTION							


KISINGER CAMPO & ASSOCIATES CORP. 201 N FRANKLIN ST, SUITE 400, TAMPA, FL 33602 ENGINEER OF RECORD: FATHY ABDALLA, P.E. NO: 63914 CITY OF TAMPA
MOBILITY DEPARTMENT


ROAD NO. COUNTY PROJECT DESIGN NO.

HILLSBOROUGH 21-C-00022

CURVE DATA TABLE & BENCHMARKS TABLE SHEET NO.

Christian Tabares 8/2/2023 2:43:42 PM

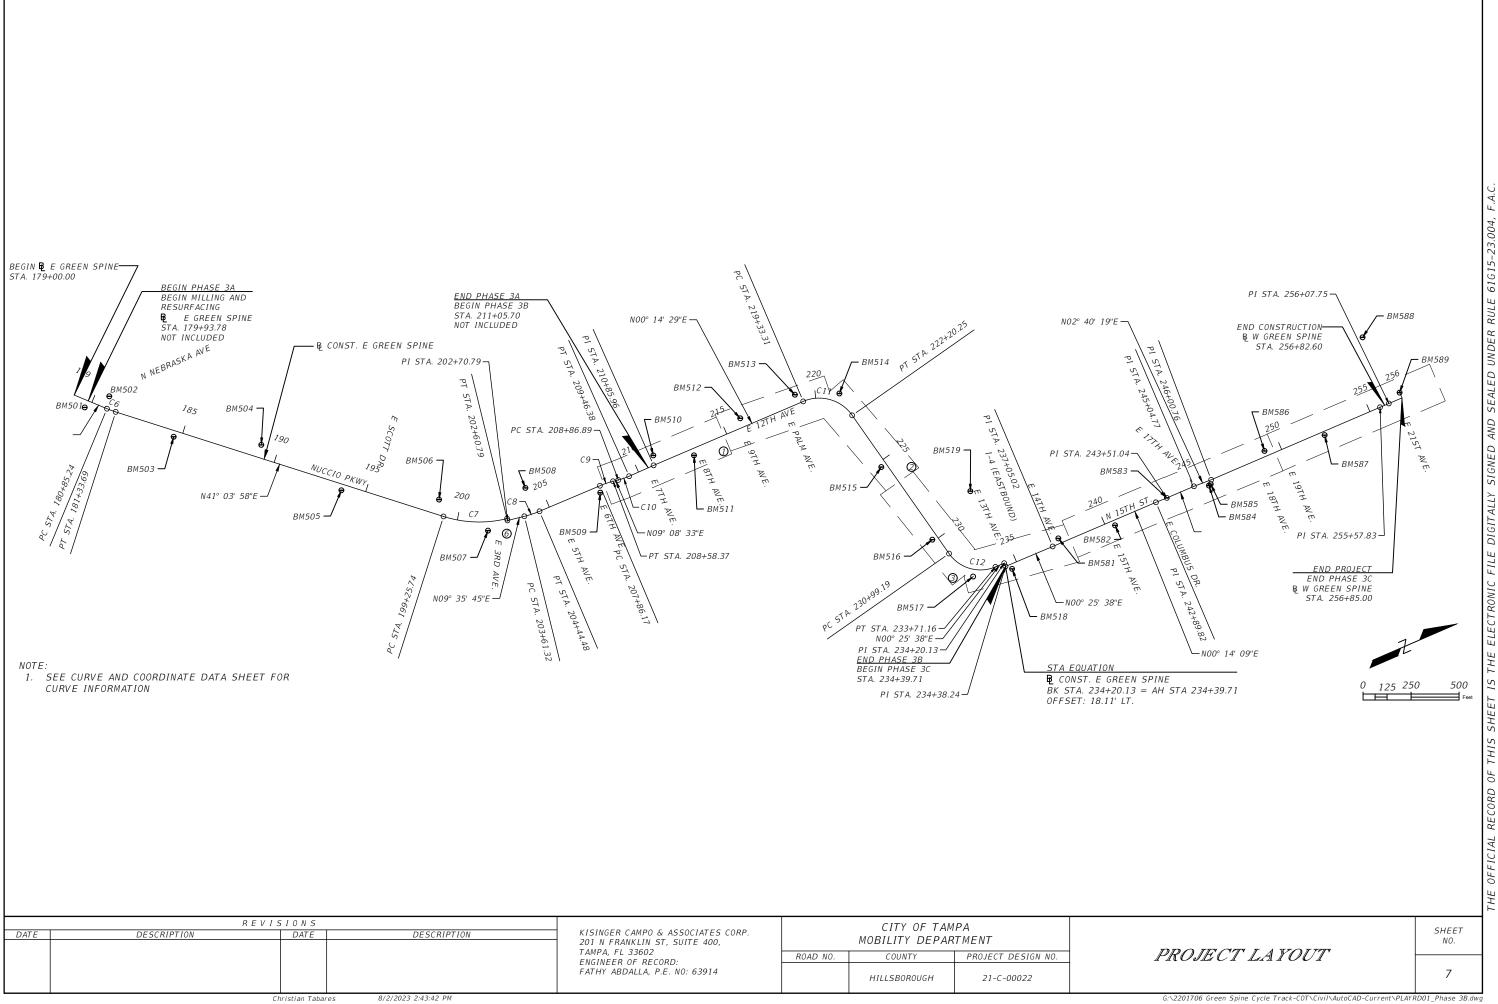

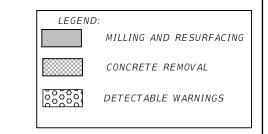




SEALED UNDER

SIGNED ,


DIGITALLY

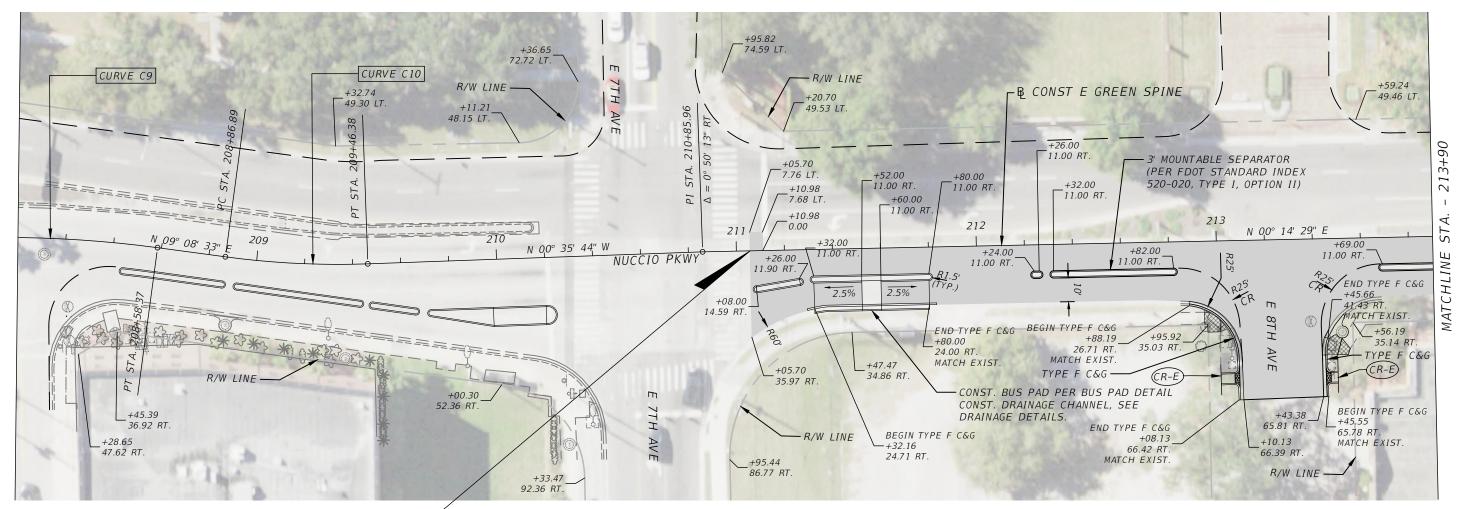



END PHASE 3A MATCH FPID 439475-2-58-01 BEGIN PHASE 3B BEGIN MILLING AND RESURFACING ₿ CONST. E GREEN SPINE STA. 211+05.70


- 1. THE EXISTING INFORMATION SHOWN IN THESE PLANS WAS NOT FIELD SURVEYED. THIS INCLUDES THE EXISTING PAVEMENT EDGES, CURB AND GUTTER, ETC. CONTRACTOR NEEDS TO FIELD VERIFY ALL EXISTING MEASUREMENTS AND QUANTITIES IN THESE PLANS, WITH NO ADDITIONAL COST TO THE CITY.
- 2. SEE SHEET # FOR ADDITIONAL CURVE DATA
- 3. PER APL, RED COLORED, ASTM C-936 PAVERS WITH TRUNCATED DOMES PER SECTION 527 DETECTABLE WARNINGS, INSTALLED STAGGERED RUNNING BOND, LONG SIDE PARALLEL WITH CURB.


REVISIONS				CITY OF TAMPA				
DATE	DESCRIPTION DATE	DESCRIPTION	KISINGER CAMPO & ASSOCIATES CORP. 201 N FRANKLIN ST, SUITE 400,	MOBILITY DEPARTMENT				SHEET NO.
			TAMPA, FL 33602 ENGINEER OF RECORD:	ROAD NO.	COUNTY	PROJECT DESIGN NO.	ROADWAY PLANS - (1)	
			FATHY ABDALLA, P.E. NO: 63914		HILLSB0R0UGH	21-C-00022		8
	Christian Tabares 8/2/2023 2:44:06 PM G:\2201706 Green Spine Cycle Track-COT\Civil\AutoCAD-Current\dsgnrd01 Phase3B.dwg							

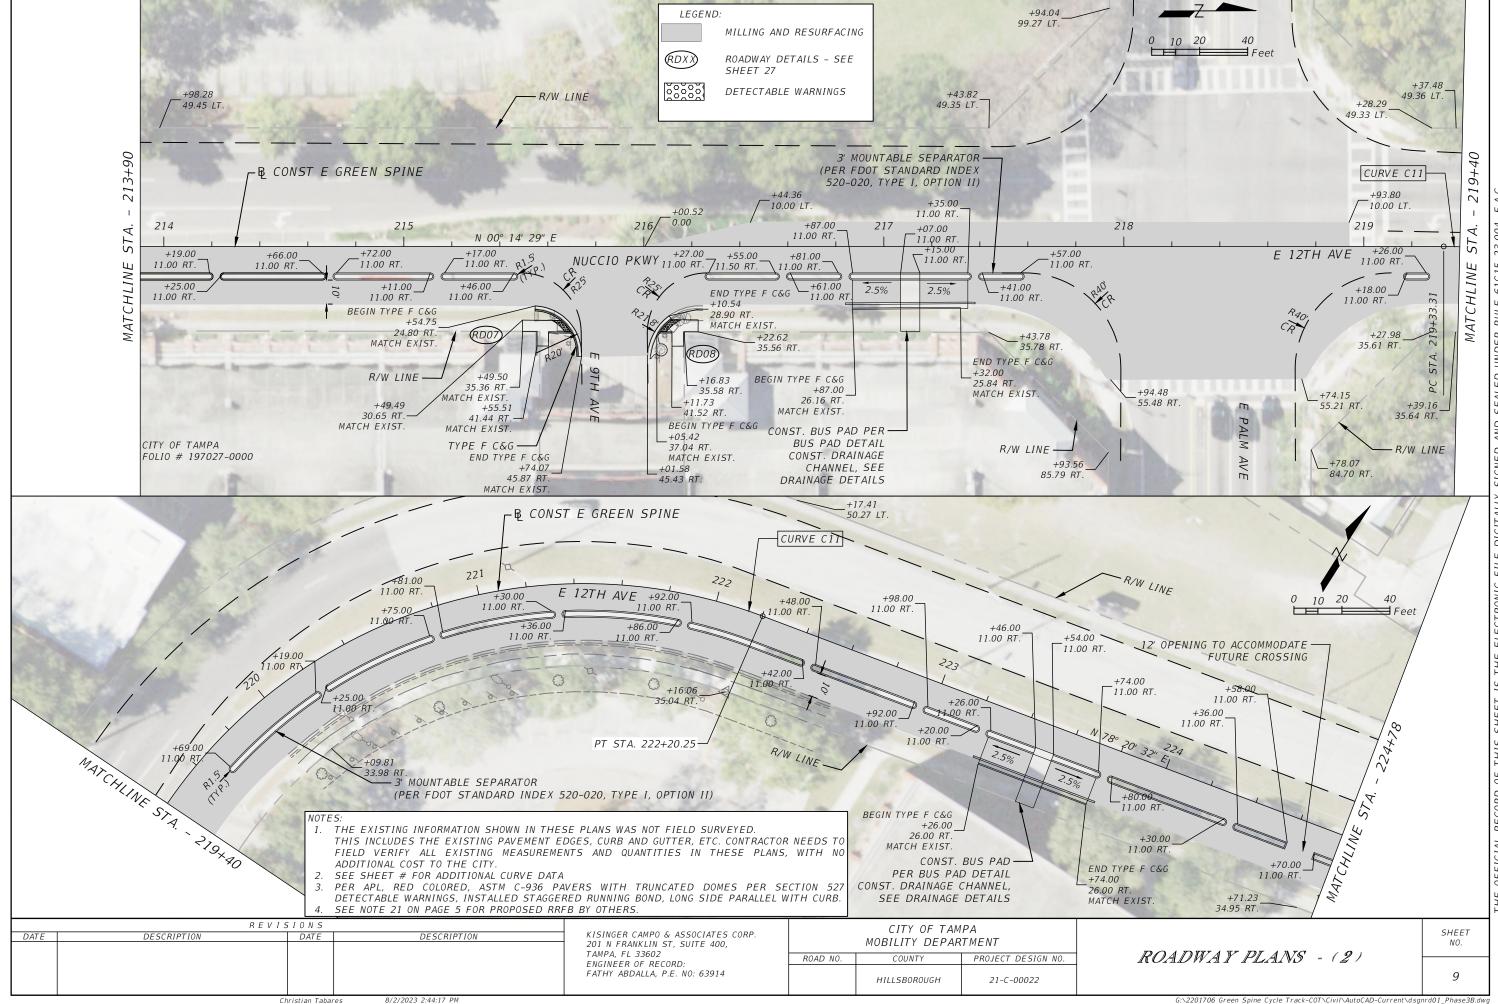


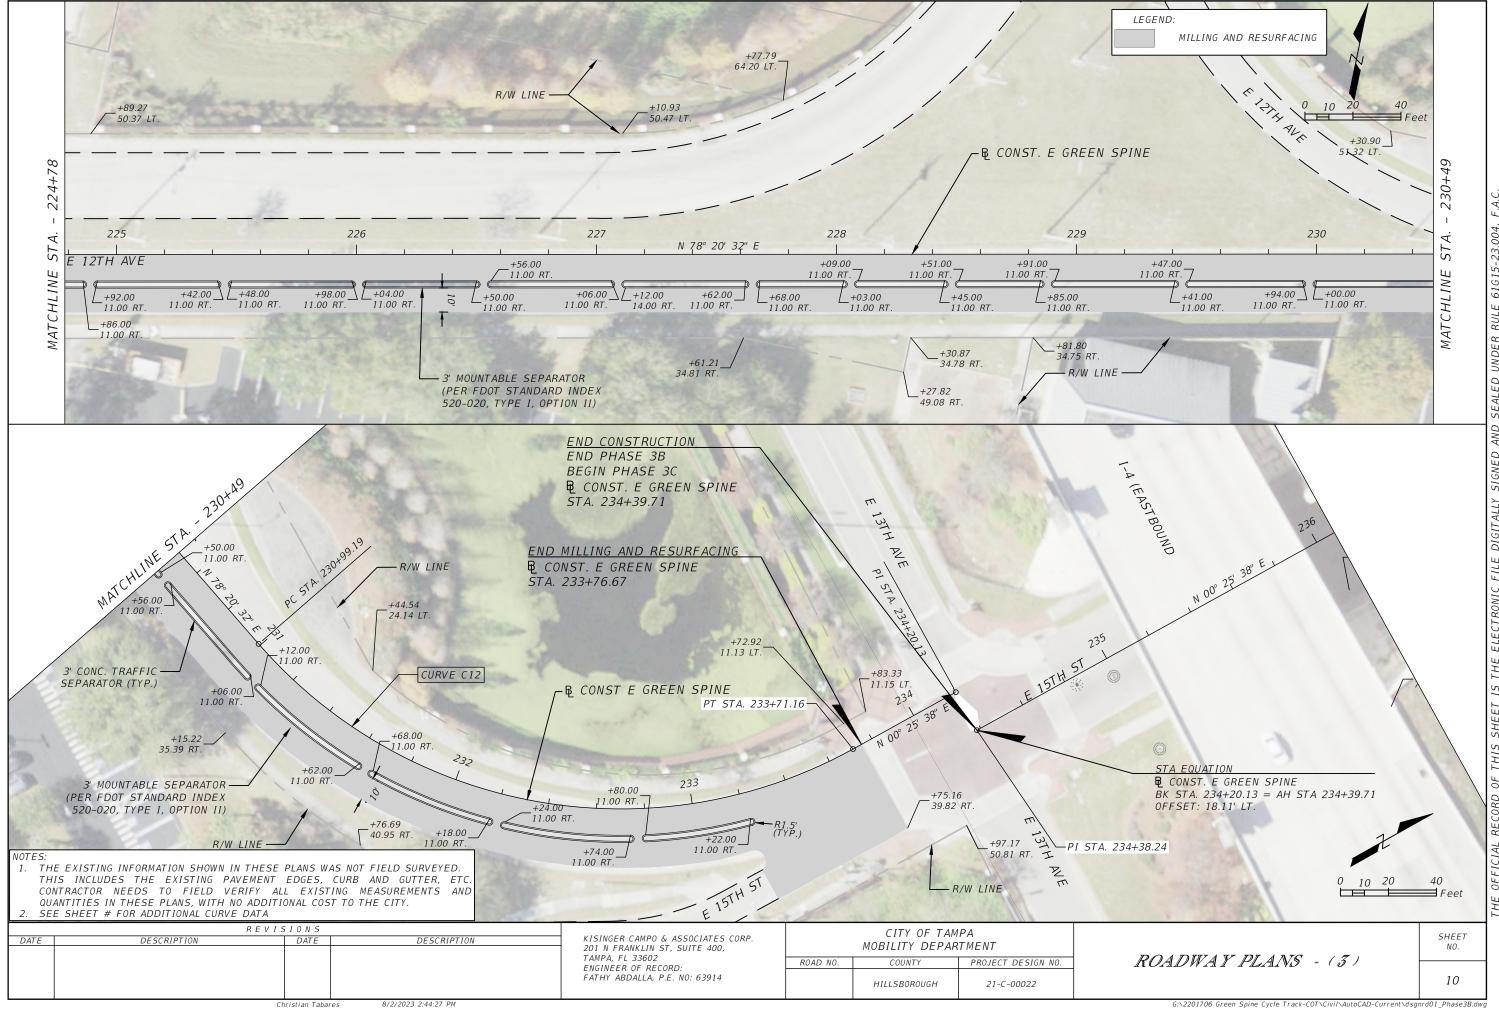


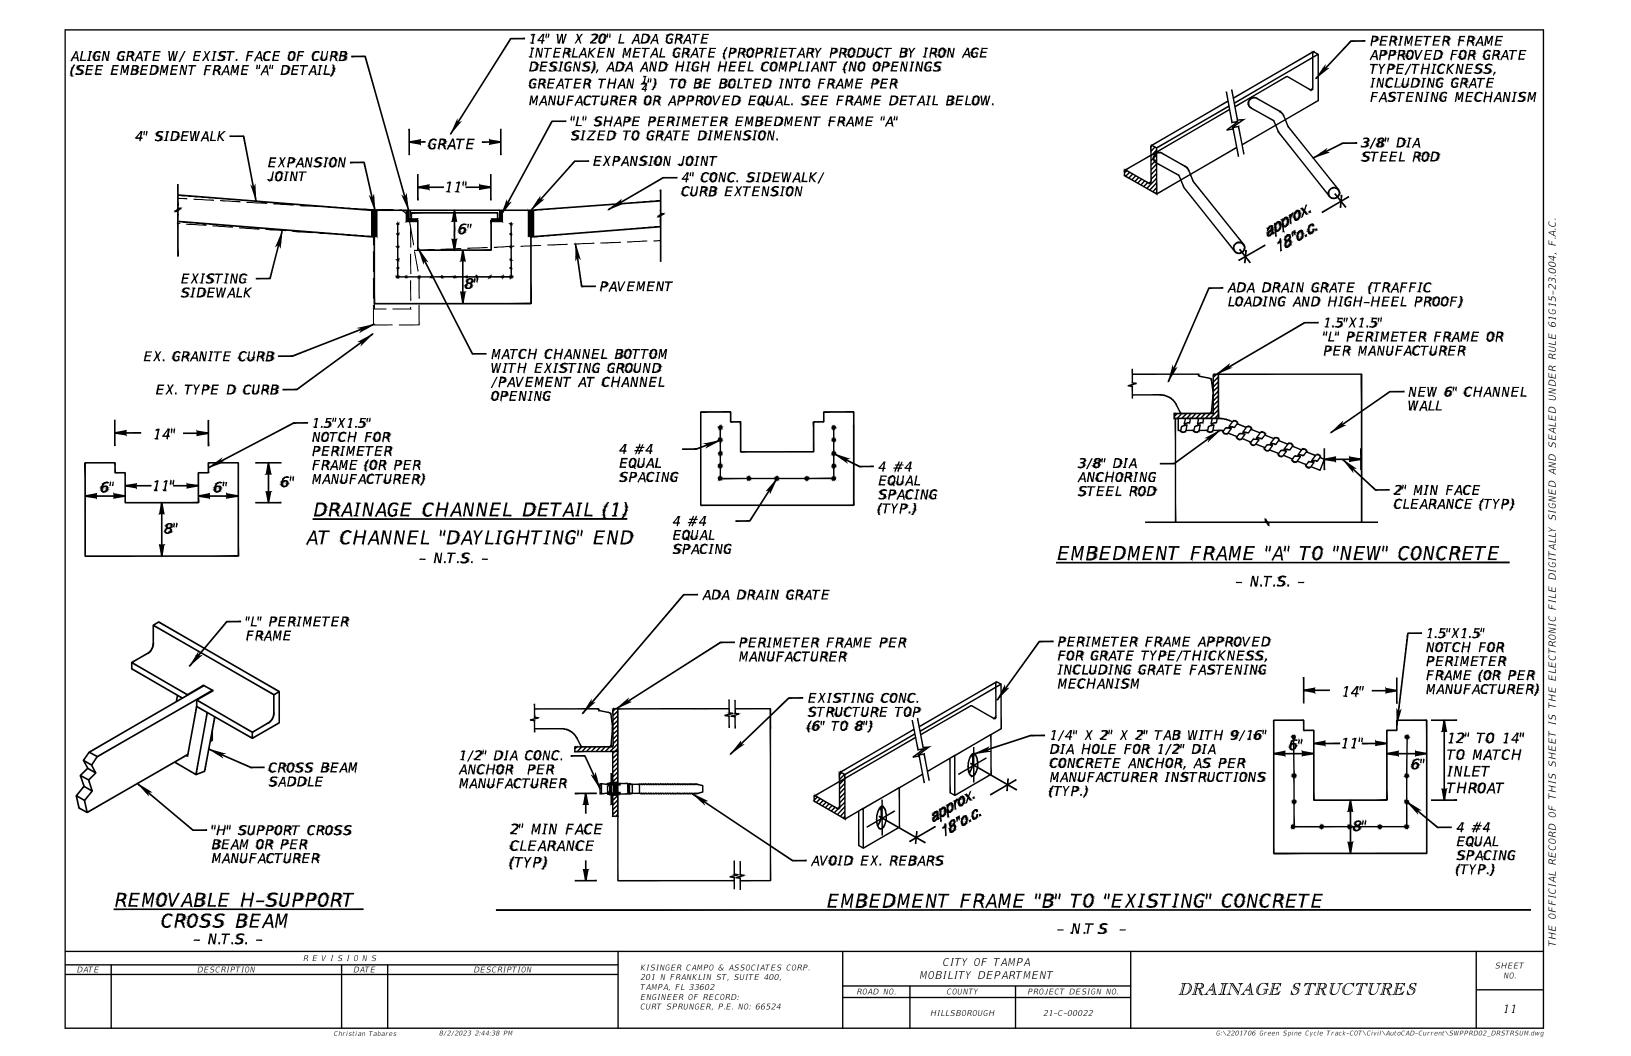

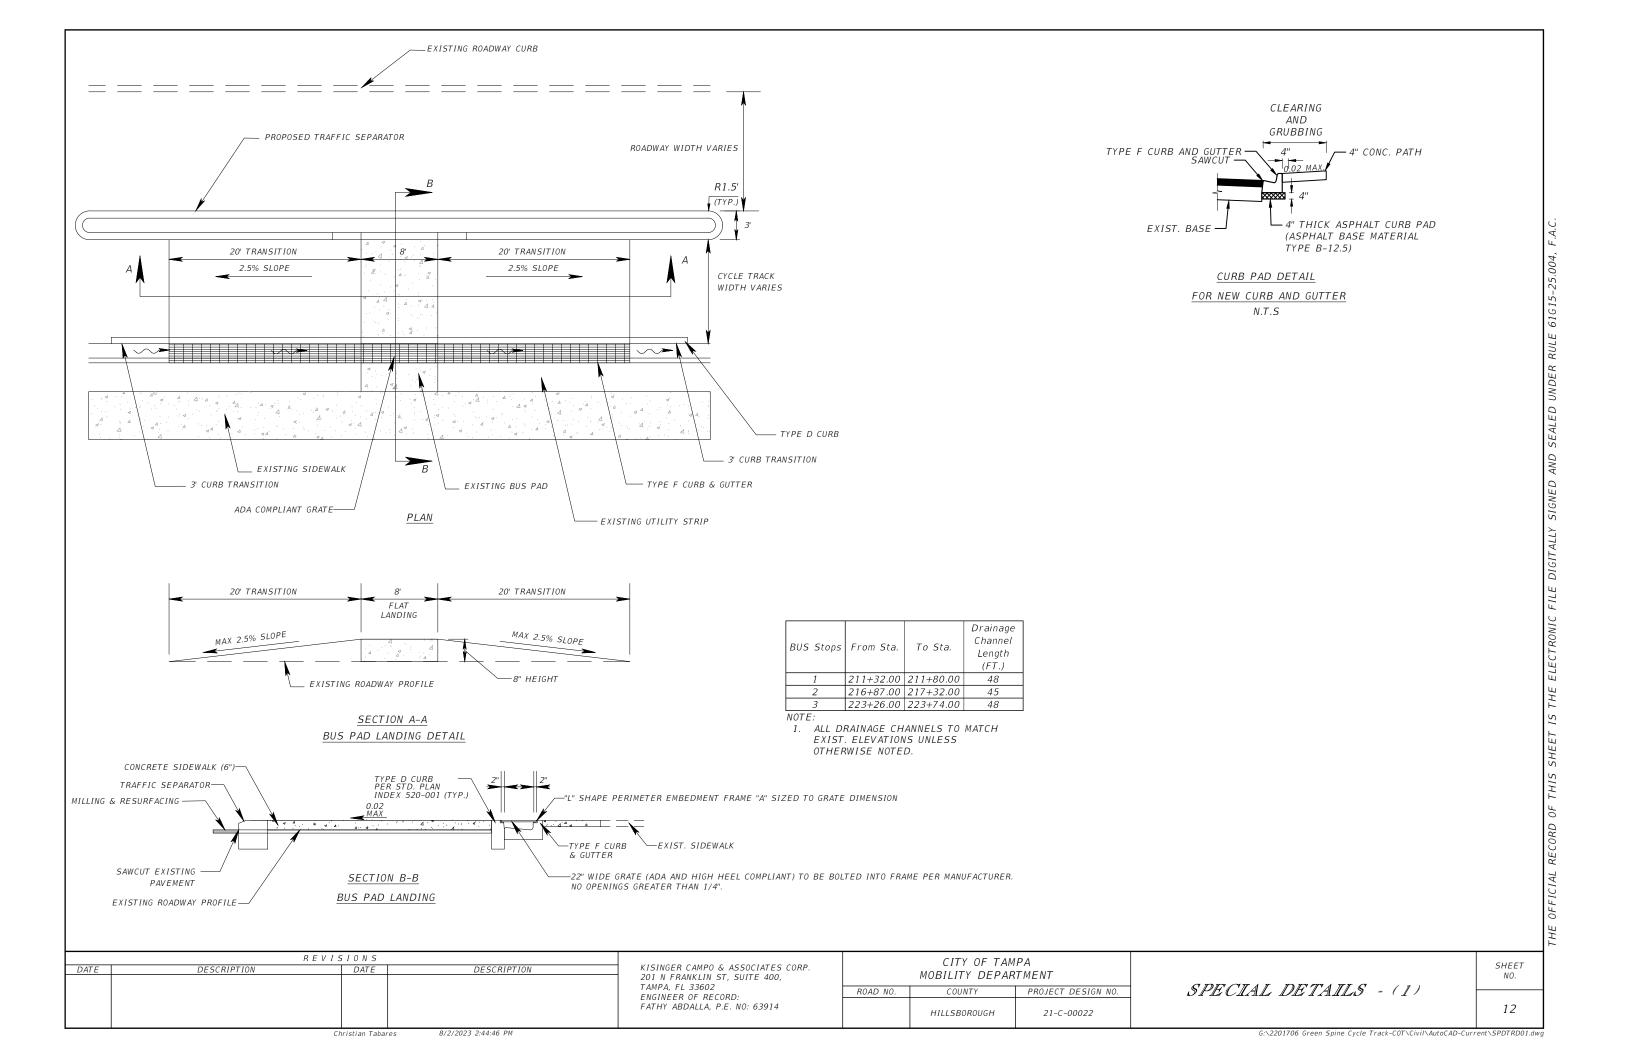

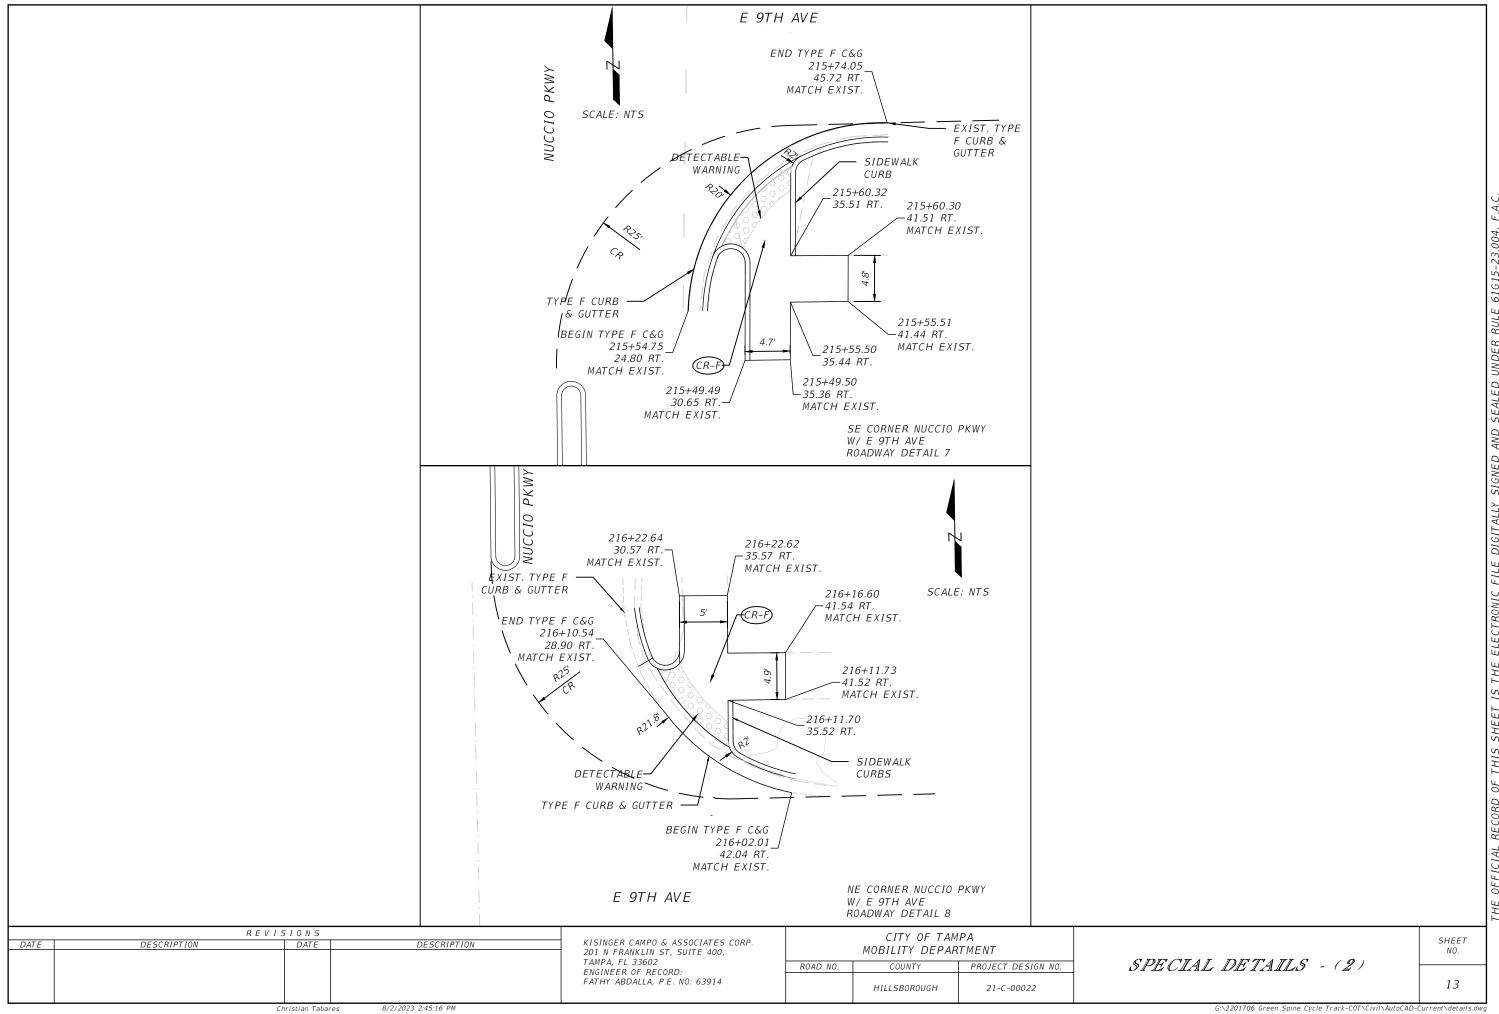

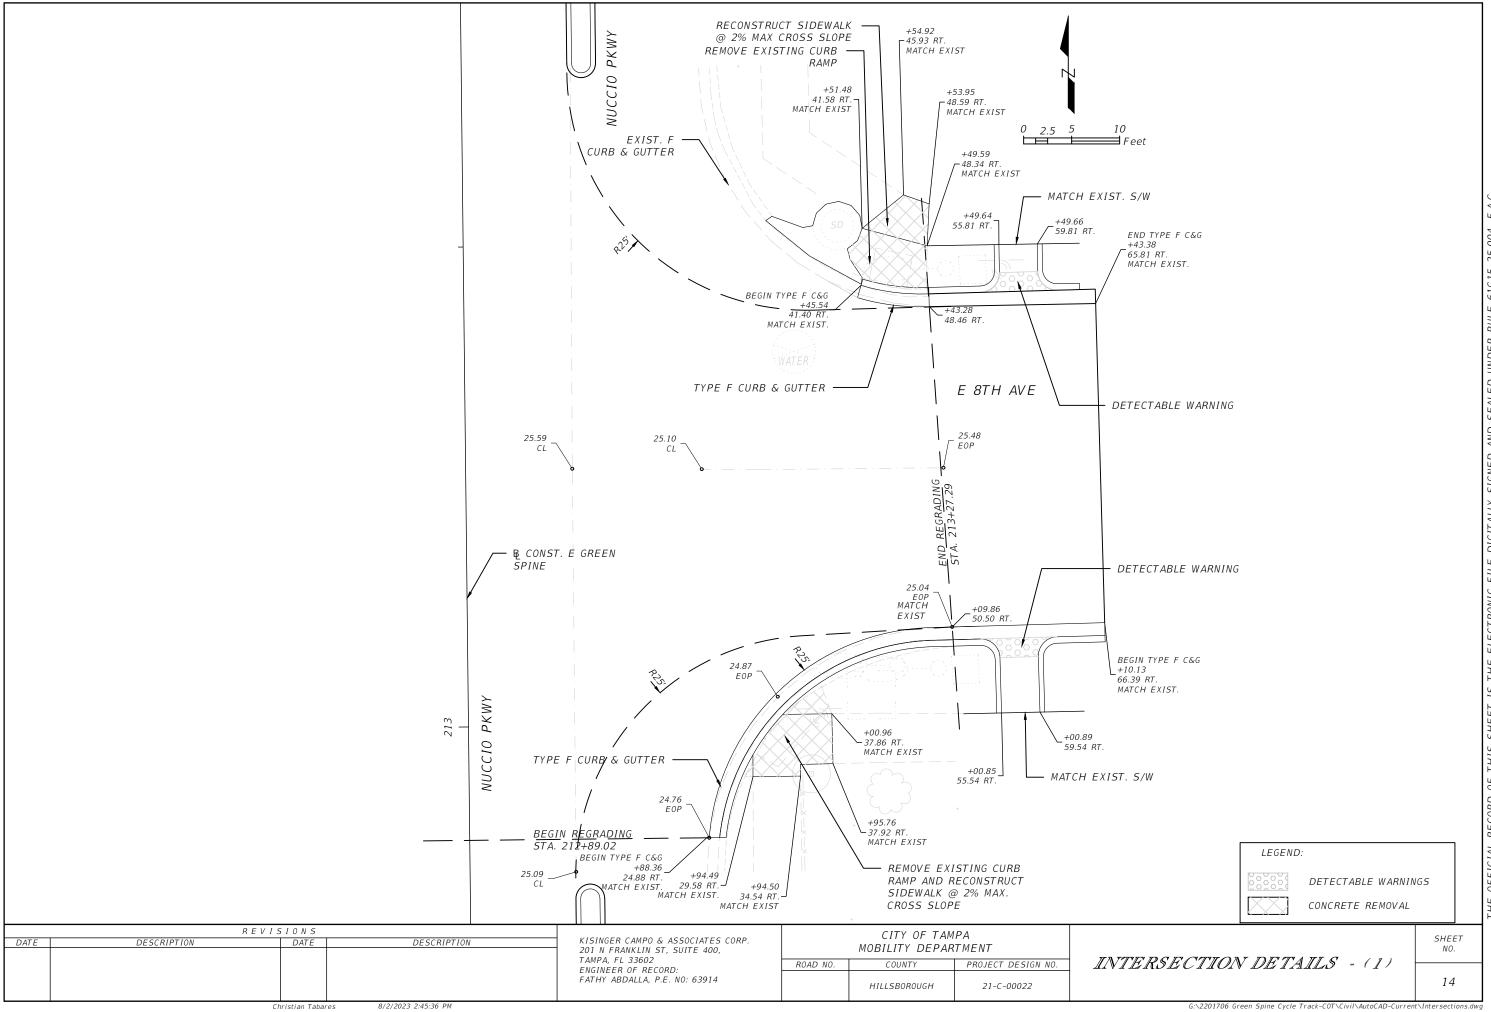

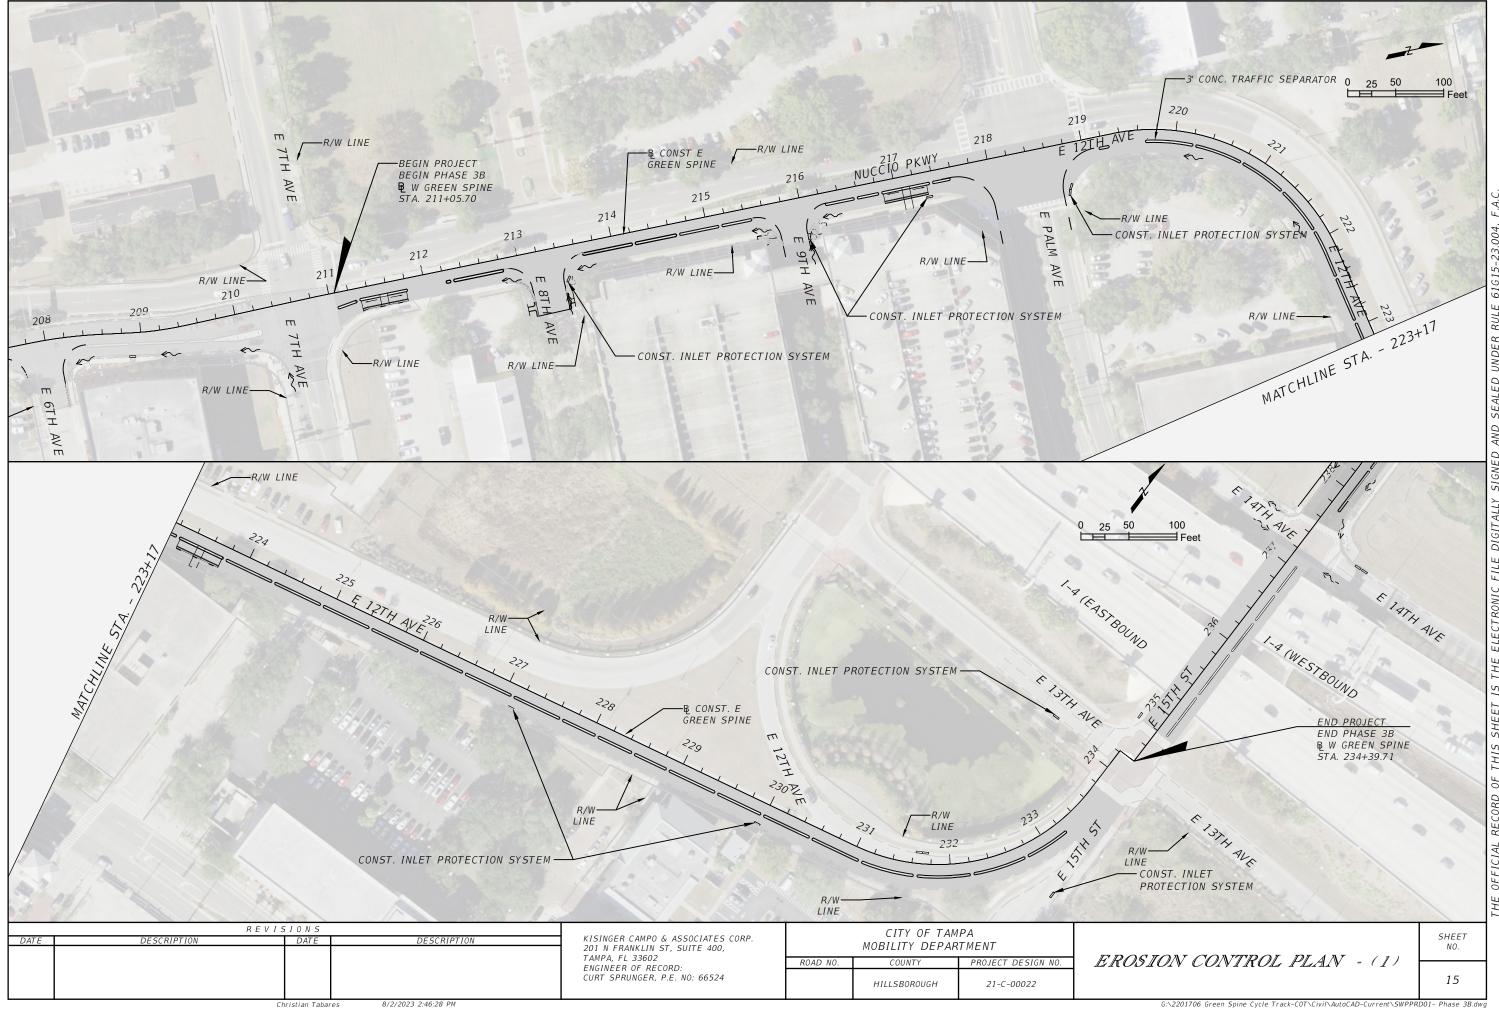

CONSTRUCTION ACTIVITY

ACTIVITIES ON THIS PROJECT INCLUDE BUT ARE NOT LIMITED TO CONSTRUCTION OF A BI-DIRECTIONAL CYCLE TRACK ALONG NUCCIO PKWY, INTERSECTION GRADING FROM E 7TH AVENUE TO E 13TH AVENUE.

PROJECT LIMITS

THE PROJECT LIMITS ARE ALONG THE SOUTH SIDE OF NUCCIO PKWYT FROM E 7TH AVENUE TO E 13TH AVENUE.

PROJECT DESCRIPTION

THE CITY WILL CONSTRUCT A NEW BI-DIRECTIONAL CYCLE TRACK WITHIN THE PROJECT LIMITS. EXISTING ROADWAYS WILL BE SHARED WITH THE PROPOSED CYCLE TRACK. THE CYCLE TRACK WILL BE 8 TO 12 FEET WIDE SEPARATED FROM THE ROADWAY BY A TRAFFIC SEPARATOR.

MAJOR SOIL DISTURBING ACTIVITIES

CONSTRUCTION OF THE CYCLE TRACK, INTERSECTION GRADING AND STORMSEWER

TOTAL PROJECT LENGTH: 0.4 MILES

F. SOIL DATA

MAJOR SOIL GROUPS IN THE PROJECT LIMITS INCLUDE:

- 77.5% URBAN LAND, 0 TO 2 PERCENT SLOPES (56)
- 11.1% MYAKKA-URBAN LAND COMPLEX (32)
- 4.9% IMMOKALEE-URBAN LAND COMPLEX (22)
- 3.4% WATER (99)
- 3.1% TAVARES-URBAN LAND COMPLEX, 0 TO 5 PERCENT SLOPES (55)

DRAINAGE AREA: 4.2 AC

RECEIVING WATERS

EXISTING STORMSEWER SYSTEMS (HILLSBOROUGH RIVER AND TAMPA BAY)

WETLANDS AREAS NO WETLAND IMPACTS

CONTROLS

ALL CONTROLS SHALL BE CONSISTENT WITH PERFORMANCE STANDARDS FOR EROSION AND SEDIMENT CONTROL AND STORM-WATER TREATMENT SET FORTH IN RULE 62-40.432, F.A.C., THE APPLICABLE STORM-WATER OR ENVIRONMENTAL RESOURCE PERMITTING REQUIREMENTS OF THE DEPARTMENT OR A WATER MANAGEMENT DISTRICT AND THE GUIDELINES CONTAINED IN THE FLORIDA DEVELOPMENT MANUAL: A GUIDE TO SOUND LAND AND WATER MANAGEMENT (DEP. 1988) AND ANY SUBSEQUENT AMENDMENTS.

SEQUENCE OF MAJOR ACTIVITIES

- INSTALL INLET PROTECTION AS SHOWN ON THE EROSION AND SEDIMENT (E&S) PLAN AND CONSTRUCTION DRAWING.
- INSTALL SILT FENCE.
- STABILIZE, MAINTAIN, AND REPLACE E&S AS DIRECTED BY THE ENGINEER.
- PERFORM WEEKLY INSPECTION OF E&S AND AFTER EVERY 3" RAINFALL.
- REMOVE ALL SEDIMENTS THAT HAVE MIGRATED OFF SITE AS DIRECTED BY THE ENGINEER. WHEN CONSTRUCTION ACTIVITY IS COMPLETE AND THE SITE IS STABILIZED, REMOVE
- FROSION PROTECTION DEVICES.

EROSION AND SEDIMENT CONTROL CONSTRUCTION ACTIVITIES

THE CONTRACTOR IS REQUIRED TO REVIEW THE SITE SPECIFIC EROSION CONTROL PLAN. THE CONTRACTOR MAY ALSO BE REQUIRED TO MODIFY THE PLAN OR MATERIALS TO ADAPT TO SEASONAL VARIATIONS OR SITE CONDITIONS. CONTRACTOR WILL COMPLY WITH E & S PLAN. ANY MODIFICATIONS TO THIS PLAN MUST BE SIGNED BY A PROFESSIONAL ENGINEER REPRESENTING THE CONTRACTOR. THE EROSION CONTROL DEVICES, DETAILS, AND NOTES APPLICABLE TO THESE ACTIVITIES ARE SPECIFIED IN THE PLANS. THE PROJECT ENGINEER IS RESPONSIBLE FOR DETERMINING IF ADDITIONAL CONTROLS ARE THE PROJECT ENGINEER MAY REQUIRE ADDITIONAL CONTROLS TO MEET STANDARDS AND REGULATIONS.

PERFORM DAILY INSPECTION OF EROSION AND SEDIMENT CONTROLS AFTER EVERY 1/2" RAINFALL

REMOVE ALL SEDIMENTS THAT HAVE MIGRATED OFF SITE AS DIRECTED BY THE ENGINEER

C: STABILIZATION PRACTICES

DURING CONSTRUCTION THE CONTRACTOR WILL PROVIDE STABILIZATION FOR AREAS WHICH HAVE BEEN CLEARED AND NOT REWORKED WITHIN FOURTEEN (14) CALENDAR DAYS. THE CONTRACTOR MAY UTILIZE TEMPORARY SEEDING OR TEMPORARY SODDING IN ACCORDANCE WITH SECTION 570 OF THE "FDOT STANDARD SPECIFICATIONS FOR ROAD AND BRIDGE CONSTRUCTION".

X	TEMPORARY SODDING
	TEMPORARY GRASSING
	PERMANENT SODDING OR SEEDING
	PRESERVATION OF NATURAL RESOURCES
	BUFFER ZONES

D:

STRUCTURAL	<u>PRACTICES</u>
	SYNTHETIC BALES (LF)
	ARTIFICIAL COVERINGS/ ROLLED EROSION CONTROL PRODUCTS (SY)
X	INLET PROTECTION SYSTEM (EA)
	LITTER REMOVAL AND DISPOSAL (AC)
	MOWING (AC)
	SLOPE DRAINS (TEMPORARY)/ RUNOFF CONTROL STRUCTURES (LF)
	SOIL TRACKING PREVENTION DEVICE (EA)
	SEDIMENT BASINS/CONTAINMENT SYSTEMS (EA)
	SEDIMENT BASIN/ CONTAINMENT SYSTEM CLEANOUT (EA)
	FLOATING TURBIDITY BARRIER (LF)
X	STAKED SILT FENCE (LF)
	CHEMICAL TREATMENT - POWDERED (SY)
	CHEMICAL TREATMENT (FLOC LOGS, DRUMS OF PRODUCT) (EA)

DESCRIPTION OF STORM WATER MANAGEMENT

WHERE NO PROPOSED STORMWATER SYSTEMS EXIST STORMWATER WILL DISCHARGE INTO EXISTING SYSTEMS AND SWALES. PROPOSED STORMSEWER SHALL BE CONSTRUCTED DURING THE INITIAL PHASE AND BE USED DURING CONSTRUCTION. THE OUTFALL STRUCTURES ARE TO BE PROTECTED WHEN TEMPORARY SEDIMENT BASINS, CONTAINMENT SYSTEMS OR PERMANENT STORMWATER MANAGEMENT FACILTIES ARE USED FOR EROSION AND SEDIMENT CONTROL TO PREVENT DOWNSTREAM SEDIMENTATION.

SANITARY WASTE

FDOT STANDARD SPEC. FOR ROAD AND BRIDGE CONSTRUCTION" SECTION 7 - 6 "SANITARY PROVISIONS." THE CONTRACTOR SHALL PROVIDE AND MAINTAIN, IN A NEAT AND SANITARY CONDITION, SUCH ACCOMMODATION FOR THE USE OF HIS EMPLOYEES AS ARE NECESSARY TO COMPLY WITH THE REQUIREMENTS AND REGULATIONS OF THE STATE AND LOCAL BOARDS OF HEALTH. COMMIT NO PUBLIC NUISANCE."

G: **HAZARDOUS WASTE**

THE CONTRACTOR WILL IMMEDIATELY NOTIFY THE CITY IN WRITING IF ANY HAZARDOUS WASTE MATERIAL IS ENCOUNTERED DURING SITE INVESTIGATION OR CONSTRUCTION.

THE CONTRACTOR WILL ALSO BE RESPONSIBLE FOR NOTIFYING THE FLORIDA DEPARTMENT OF ENVIRONMENTAL PROTECTION (FDEP) WITHIN 24 HOURS OF THE

ALL HAZARDOUS WASTE MATERIALS, IF ENCOUNTERED, WILL BE DISPOSED OF IN THE MANNER SPECIFIED BY LOCAL, STATE, AND FEDERAL REGULATIONS, THE CONTRACTOR WILL BE RESPONSIBLE FOR SEEING THAT THESE PRACTICES ARE FOLLOWED

IN CASE OF DISPOSING ANY HAZARDOUS WASTE MATERIAL FOLLOWING LOCAL, STATE, AND FEDERAL REGULATIONS. A COPY OF DISPOSAL MANIFEST HAS TO BE PROVIDED TO THE CITY IN TIMELY EASHION

PERMITTEE CERTIFICATION

I CERTIFY LINDER PENALTY OF LAW THAT THIS DOCUMENT AND ALL ATTACHMENTS WERE PREPARED UNDER MY DIRECTION OR SUPERVISION IN ACCORDANCE WITH A SYSTEM DESIGNED TO ASSURE THAT QUALIFIED PERSONNEL PROPERLY GATHERED AND EVALUATED THE INFORMATION SUBMITTED. BASED ON MY INQUIRY OF THE PERSON OR PERSONS WHO MANAGE THE SYSTEM, OR THOSE PERSONS DIRECTLY RESPONSIBLE FOR GATHERING THE INFORMATION, THE INFORMATION SUBMITTED IS, TO THE BEST OF MY KNOWLEDGE AND BELIEF, TRUE, ACCURATE, AND COMPLETE. I AM AWARE THAT THERE ARE SIGNIFICANT PENALTIES FOR SUBMITTING FALSE INFORMATION, INCLUDING POSSIBILITY OF FINE AND IMPRISONMENT FOR KNOWING VIOLATIONS.

NINA MABILLEAU					D	ATE
CITY OF TAMPA	TRANSPORTATION	AND	STORMWATER	SERVICES		

CONTRACTOR CERTIFICATION

I CERTIFY UNDER PENALTY OF LAW THAT I UNDERSTAND, AND SHALL COMPLY WITH , THE TERMS AND CONDITIONS OF THE STATE OF FLORIDA GENERIC PERMIT FOR STORMWATER DISCHARGE FROM LARGE AND SMALL CONSTRUCTION ACTIVITIES AND THIS STORMWATER POLLUTION PREVENTION

GENERAL CONTRACTOR NAME & TITLE	DATE
GENERAL CONTRACTOR NAME & ITTLE	DAIL

COMPANY NAME

COMPANY STREET ADDRESS

CITY, STATE, ZIP CODE

A. WATER QUALITY MONITORING (MIXING ZONES)

THE WATER THAT WILL BE SAMPLED FOR STATE WATER QUALITY STANDARDS FOR CONSTRUCTION ACTIVITIES PROHIBIT A TURBIDITY INCREASE OF GREATER THAN 29 NTU'S ABOVE AMBIENT CONDITIONS AT THE COMPLIANCE LOCATION OF THE MIXING ZONES. TO MAINTAIN THIS STANDARD, TURBIDITY MONITORING SHALL OCCUR DURING ALL IN-WATER CONSTRUCTION ACTIVITIES AT EACH COMPLIANCE AND BACKGROUND STATION. THE FOLLOWING PROCEDURE SHALL BE USED:

FREQUENCY: TWICE A DAY, AT LEAST 4 HOURS APART DURING FREQUENCY OF ACTUAL

LOCATIONS: ALL STATIONS SHALL BE SAMPLED AT 2 FEET ABOVE LOCATIONS THE BOTTOM, AT MID-DEPTH, AND AT THE SURFACE, OR AS DIRECTED BY PERMITTING AGENCIES. IF WATER IS LESS THAN THREE FEET DEEP, ONLY MID-DEPTH SAMPLES ARE REQUIRED

BACKGROUND: 500 FEET UP-CURRENT FROM THE CONSTRUCTION BACKGROUND ACTIVITY AND OUTSIDE OF ANY TURBIDITY PLUME FROM THE CONSTRUCTION ACTIVITY.

COMPLIANCE: 300 FEET DOWN CURRENT FROM THE CONSTRUCTION COMPLIANCE ACTIVITY WITHIN ANY VISIBLE TURBIDITY PLUME, OR AS DIRECTED BY PERMITTING AGENCIES.

METHOD: ALL SAMPLES SHALL BE COLLECTED WITH A KEMMERER. VAN DORN METHOD. OR SIMILAR SAMPLER WHICH IS DESIGNED TO COLLECT IN SITU WATER SAMPLES.

REPORTING: ALL MONITORING DATA SHALL BE SUBMITTED WITHIN ONE REPORTING WEEK OF ANALYSIS WITH DOCUMENTS CONTAINING THE FOLLOWING INFORMATION:

REVISIONS DESCRIPTION

KISINGER CAMPO & ASSOCIATES CORP. 201 N FRANKLIN ST, SUITE 400, TAMPA, FL 33602 ENGINEER OF RECORD. CURT SPRUNGER, P.E. NO: 66524

CITY OF TAMPA MOBILITY DEPARTMENT ROAD NO COUNTY

HILLSBOROUGH

PROJECT DESIGN NO. 21-C-00022

STORMWATER POLLUTION PREVENTION PLAN (1)

SHEET

16

Christian Tabares 8/2/2023 2:46:39 PM

- PERMIT NUMBER
- 2. DATES OF SAMPLING AND ANALYSIS
- 3. LOCATION OF SAMPLE (I.E., STATION AND WATER COLUMN LOCATION)
- 4. A STATEMENT DESCRIBING THE METHODS USED IN COLLECTION, HANDLING,
- 5. STORAGE, AND ANALYSIS OF THE SAMPLES
- 6. A MAP INDICATING THE SAMPLING LOCATIONS
- STATEMENT, BY THE INDIVIDUAL RESPONSIBLE FOR IMPLEMENTATION OF THE SAMPLING PROGRAM, CONCERNING THE AUTHENTICITY, PRECISION, LIMITS OF DETECTION AND ACCURACY OF DATA.

MONITORING REPORTS SHALL INCLUDE INFORMATION ON THE GENERAL ANTECEDENT WEATHER CONDITIONS.

IF MONITORING REVEALS VIOLATIONS OF THE STATE WATER QUALITY STANDARD FOR TURBIDITY, CONSTRUCTION ACTIVITIES SHALL CEASE IMMEDIATELY AND NOT RESUME UNTIL CORRECTIVE MEASURES HAVE BEEN TAKEN AND TURBIDITY HAS RETURNED TO ACCEPTABLE LEVELS. ANY SUCH OCCURRENCE SHALL ALSO BE IMMEDIATELY REPORTED TO THE REGULATORY AGENCIES. IN THE EVENT THAT STATE WATER QUALITY STANDARDS ARE NOT ATTAINED, THE CONTRACTOR SHALL IMPLEMENT A CONTINGENCY PLAN WHICH COMPLIES WITH THE PROJECT SWFWMD/FDEP ERP AND CITY OF TAMPA NPDES REQUIREMENTS AT NO ADDITIONAL COST TO THE COUNTY. ANY FINES SHALL BE RESPONSIBILITY OF THE CONTRACTORS.

K. APPROVED STATE, LOCAL PLANS, OR STORM WATER PERMITS

SWFWMD PERMIT EXEMPTION, FILE NUMBER 785609.

III. MAINTENANCE

A. ALL OF THE CONTROLS SHALL BE MAINTAINED AT ALL TIMES.

THE CONTRACTOR SHALL BE RESPONSIBLE FOR DAILY INSPECTION AND MAINTENANCE OF ALL PERMANENT AND TEMPORARY EROSION CONTROL DEVICES THROUGHOUT ALL CONSTRUCTION PHASES OF THE PROJECT.

B. INSPECTION

THE CITY INSPECTOR SHALL BE RESPONSIBLE FOR COMPLETING THE D.E.I. NPDES / SWPPP CONSTRUCTION INSPECTION REPORT AFTER ANY ½" RAINFALL OR WEEKLY, IF NO RAIN EVENT OCCURRED. IT IS THE CONTRACTOR'S RESPONSIBILITY TO MAINTAIN RAIN GAUGES ON THE PROJECT SITE AND RECORD WEEKLY RAIN FALL. THE CITY INSPECTOR SHALL ALSO COMPLETE THE CITY OF TAMPA D.E.I. NPDES COMPLIANCE CHECKLIST FOR CONSTRUCTION SITES.

C. NON-STORM WATER DISCHARGES

IT IS EXPECTED THAT THE FOLLOWING NON-STORM WATER DISCHARGES MAY OCCUR FROM THE SITE DURING THE CONSTRUCTION PERIOD:

- PAVEMENT WASH WATERS (WHERE NO SPILL OR LEAKS OF VEHICLE AND HAZARDOUS MATERIALS HAVE OCCURRED)
- UNCONTAMINATED GROUNDWATER FROM DE-WATERING ACTIVITIES

ALL NON-STORM WATER DISCHARGES WILL BE DIRECTED TO THE SEDIMENT BASIN PRIOR TO DISCHARGE OR AS DIRECTED BY THE ENGINEER. IF CONTAMINATED SOIL OR GROUNDWATER IS ENCOUNTERED, DEATERING SHOULD CEASE IMMEDIATELY AND THE ENGINEER WILL BE CONTACTED.

D. MATERIAL MANAGEMENT PRACTICES

THE FOLLOWING ARE THE MATERIAL HANDLING PRACTICES THAT WILL BE USED TO REDUCE THE RISK OF SPILLS OR OTHER ACCIDENTAL EXPOSURE OF MATERIALS AND SUBSTANCES TO STORM WATER RUNOFF:

1. THE FOLLOWING GOOD HOUSEKEEPING PRACTICES SHALL BE FOLLOWED ON—SITE DURING THE CONSTRUCTION PROJECT.

- STORE ONLY ENOUGH PRODUCT REQUIRED TO DO THE JOB ON SITE.
- ALL MATERIALS STORED ON SITE SHALL BE STORED IN A NEAT, ORDERLY MANNER IN THEIR ORIGINAL MANUFACTURER'S LABELED CONTAINERS UNDER A ROOF OR OTHER CONTAINED ENCLOSURE.
- SUBSTANCES SHALL NOT BE MIXED WITH ONE ANOTHER UNLESS RECOMMENDED BY THE MANUFACTURER.
- WHENEVER POSSIBLE, ALL OF A PRODUCT SHALL BE USED BEFORE DISPOSING OF THE CONTAINER. MANUFACTURERS' RECOMMENDATIONS FOR PROPER USE AND DISPOSAL SHALL BE FOLLOWED.
- THE SITE SUPERINTENDENT SHALL INSPECT DAILY TO ENSURE PROPER USE AND DISPOSAL OF MATERIALS ON—SITE.

2. THESE PRACTICES ARE USED TO REDUCE THE RISKS ASSOCIATED WITH HAZARDOUS MATERIALS.

- PRODUCTS WILL BE KEPT IN ORIGINAL CONTAINERS UNLESS THEY ARE NOT RE—SEALABLE.
- SECONDARY CONTAINMENT SHALL BE PROVIDED FOR ALL OPENED CONTAINERS. ORIGINAL LABELS AND MATERIAL SAFETY DATA SHALL BE KEPT ON—SITE ON THE CONSTRUCTION OFFICE TRAILER.
- IF SURPLUS PRODUCT MUST BE DISPOSED OF, MANUFACTURERS OR LOCAL STATE RECOMMENDED METHODS OF PROPER DISPOSAL SHALL BE FOLLOWED.
- THE CONTRACTOR MUST IDENTIFY A DESIGNATED FUEL TANK STORAGE AREA, AWAY FROM DRAINAGE STRUCTURES, PONDS, BASINS, AND WETLANDS, WITH SECONDARY CONTAINMENT (SPILL COLLECTION).

3. <u>CONCRETE TRUCKS</u>

- CONTRACTOR SHALL DESIGNATE AN AREA AWAY FROM DRAINAGE STRUCTURES, PONDS, BASINS, AND WETLANDS FOR DISCHARGE OF SURPLUS CONCRETE OR DRUM WASH WATER AND SHALL INSTALL A CONTAINMENT BERM AROUND THIS AREA TO PREVENT RUNOFF TO THE REMAINDER OF THE SITE.
- HARD DEBRIS SHALL BE DISPOSED OF BY CONTRACTOR UPON COMPLETION OF THE PROJECT.
- DISPOSAL OF CONCRETE SLURRY DIRECTLY INTO PUBLIC DRAINAGE SYSTEMS IS A VIOLATION OF THE "ILLICIT DISCHARGE" PROVISION.

4. SPILL CONTROL PRACTICES

IN ADDITION TO THE GOOD HOUSEKEEPING AND MATERIALS MANAGEMENT PRACTICES DISCUSSED IN THE PREVIOUS SECTIONS OF THIS PLAN, THE FOLLOWING PRACTICES WILL BE FOLLOWED FOR SPILL PREVENTION AND CLEANUP.

- MANUFACTURERS' RECOMMENDED METHODS FOR SPILL CLEANUP WILL BE CLEARLY
 POSTED AND SITE PERSONNEL WILL BE MADE AWARE OF THE PROCEDURES AND
 THE LOCATION OF THE INFORMATION CLEANUP SUPPLIES.
- ALL SPILLS WILL BE CLEANED UP IMMEDIATELY AFTER DISCOVERY.
- THE SPILL AREA WILL BE KEPT WELL VENTILATED AND PERSONNEL WILL WEAR APPROPRIATE PROTECTIVE CLOTHING TO PREVENT INJURY FROM CONTACT WITH A HAZARDOUS SUBSTANCE.

- SPILLS OF TOXIC OR HAZARDOUS MATERIAL WILL BE REPORTED TO THE APPROPRIATE STATE OR LOCAL GOVERNMENT AGENCY, REGARDLESS OF THE SIZE.
- THE SPILL PREVENTION PLAN WILL BE PREPARED BY THE CONTRACTOR AND KEPT IN THE CONSTRUCTION OFFICE TRAILER AND WILL INCLUDE MEASURES TO PREVENT THIS TYPE OF SPILL FROM REOCCURRING AND HOW TO CLEAN UP THE SPILL IF THERE ARE OTHERS. A DESCRIPTION OF THE SPILL, WHAT CAUSED IT, AND THE CLEANUP MEASURES WILL ALSO BE INCLUDED. ALL SPILLS AND RESPONSES WILL BE REPORTED TO THE APPROPRIATE AGENCY.
- THE SITE SUPERINTENDENT WILL BE THE SPILL PREVENTION AND CLEANUP COORDINATOR. HE WILL DESIGNATE OTHER SITE PERSONNEL WHO WILL RECEIVE SPILL PREVENTION AND CLEANUP TRAINING. THESE INDIVIDUALS WILL EACH BECOME RESPONSIBLE FOR A PARTICULAR PHASE OF PREVENTION AND CLEANUP. THE NAMES OF RESPONSIBLE SPILL PERSONNEL WILL BE POSTED IN THE MATERIAL STORAGE AREA AND IN THE OFFICE TRAILER ON SITE.
- USE AND CHARACTERISTICS OF FUEL OR CHEMICAL STORAGE TANK ON SITE SHALL COMPLY WITH ALL RELATED FEDERAL, STATE, AND LOCAL REGULATIONS. STORAGE TANKS MUST BE LOCATED AS FAR AS POSSIBLE FROM ANY DRAINAGE STRUCTURES, DITCHES, AND/OR SURFACE WATERS. IN ADDITION, THE CONTRACTOR MUST PROVIDE A SECONDARY CONTAINMENT WITH A LINER CHEMICALLY RESISTANT TO THE FUEL OR CHEMICAL STORED ON SITE. THE SECONDARY CONTAINMENT MUST BE SIZED TO CONTAIN MINIMUM OF ONE AND A HALF TIME THE TOTAL CAPACITY OF STORAGE TANK BEING USED. CONTRACTOR HAS TO PROVIDE A DAILY INSPECTION LOG FOR THE SECONDARY CONTAINMENT WITH INDICATION OF DATE, INSPECTORS NAME AND INSPECTION REPORT. FURTHERMORE, ANY CONTAMINATION HAS TO BE IMMEDIATELY CONTAINED AND THE COUNTY INSPECTOR MUST BE NOTIFIED OF THE NATURE AND EXTEND OF THE CONTAMINATION.

PERMITTEE CERTIFICATION

I CERTIFY UNDER PENALTY OF LAW THAT THIS DOCUMENT AND ALL ATTACHMENTS WERE PREPARED UNDER MY DIRECTION OR SUPERVISION IN ACCORDANCE WITH A SYSTEM DESIGNED TO ASSURE THAT QUALIFIED PERSONNEL PROPERLY GATHERED AND EVALUATED THE INFORMATION SUBMITTED. BASED ON MY INQUIRY OF THE PERSON OR PERSONS WHO MANAGE THE SYSTEM, OR THOSE PERSONS DIRECTLY RESPONSIBLE FOR GATHERING THE INFORMATION, THE INFORMATION SUBMITTED IS, TO THE BEST OF MY KNOWLEDGE AND BELIEF, TRUE, ACCURATE, AND COMPLETE. I AM AWARE THAT THERE ARE SIGNIFICANT PENALTIES FOR SUBMITTING FALSE INFORMATION, INCLUDING POSSIBILITY OF FINE AND IMPRISONMENT FOR KNOWING VIOLATIONS.

NNA MABILLEAU, E.I.	DATE
CITY OF TAMPA TRANSPORTATION AND STORMWATER SERVICES	

CONTRACTOR CERTIFICATION

I CERTIFY UNDER PENALTY OF LAW THAT I UNDERSTAND, AND SHALL COMPLY WITH , THE TERMS AND CONDITIONS OF THE STATE OF FLORIDA GENERIC PERMIT FOR STORMWATER DISCHARGE FROM LARGE AND SMALL CONSTRUCTION ACTIVITIES AND THIS STORMWATER POLLUTION PREVENTION PLAN PREPARED THEREUNDER.

GENERAL CONTRACTOR NAME & TITLE	DATE
COMPANY NAME	
COMPANT NAME	
COMPANY STREET ADDRESS	
CITY, STATE, ZIP CODE	

R E V I S I O N S						
DATE	DESCRIPTION	DATE	DESCRIPTION			

KISINGER CAMPO & ASSOCIATES CORP. 201 N FRANKLIN ST, SUITE 400, TAMPA, FL 33602 ENGINEER OF RECORD: CURT SPRUNGER, P.E. NO: 66524 CITY OF TAMPA
MOBILITY DEPARTMENT

ROAD NO

COUNTY PROJECT DESIGN NO.

HILLSBOROUGH 21-C-00022

STORMWATER POLLUTION PREVENTION PLAN (2) SHEET NO.

17

Christian Tabares 8/2/2023 2:46:40 PM

TEMPORARY TRAFFIC CONTROL PLAN NOTES

- THE SUPERVISOR OR FOREMAN CONTROLLING THE WORK ON THE PROJECT MUST HAVE A WORK ZONE TRAFFIC CONTROL SAFETY
 CERTIFICATION OR TRAFFIC SUPERVISOR CERTIFICATION FROM THE FLORIDA DEPARTMENT OF TRANSPORTATION. THE
 CERTIFIED SUPERVISOR SHALL BE ON THE PROJECT SITE AT ALL TIMES DURING CONSTRUCTION ACTIVITIES.
- 2. ALL EXISTING WARNING, GUIDE, AND REGULATORY SIGNS SHALL BE MAINTAINED AT ALL TIMES. SIGNS SHALL BE RELOCATED, REMOVED, OR COVERED FOR EACH TRAFFIC PATTERN PHASE, AS APPROVED BY THE ENGINEER.
- 3. ALL LANE TAPERS AND MAINTAINED LANE LINES ADJACENT TO CONSTRUCTION AREAS SHALL BE DELINEATED WITH TYPE I OR II BARRICADES, VERTICAL PANELS, TEMPORARY DRUMS OR TEMPORARY LOW PROFILE BARRIER AS APPROVED BY THE ENGINEER.
- 4. THE EXISTING SPEED LIMIT SHALL BE MAINTAINED AT ALL TIMES, UNLESS OTHERWISE NOTED IN THE PLANS.
- 5. THE CONTRACTOR SHALL NOTIFY THE ENGINEER A MINIMUM OF 7 DAYS IN ADVANCE OF ANY LANE CLOSURES.
- 6. AT THE DISCRETION OF THE THE ENGINEER, ANY TEMPORARY LANE CLOSURE CAUSING EXTENDED TRAFFIC CONGESTION (5 MINUTE DELAY) SHALL BE OPENED UNTIL TRAFFIC HAS RETURNED TO AN ACCEPTABLE FLOW AS DETERMINED BY THE ENGINEER.
- 7. PROVIDE A TEMPORARY TRAFFIC CONTROL PLAN, PREPARED BY A FDOT ADVANCED TRAFFIC CONTROL CERTIFIED PROFESSIONAL.
- 8. THE CITY OF TAMPA PARKING DIVISION SHALL BE NOTIFIED A MINIMUM OF 7 DAYS IN ADVANCE OF ANY PARKING SPACE CLOSURE. PHONE: (813) 274-8179
- 9. THE HILLSBOROUGH AREA REGIONAL TRANSIT AUTHORITY (HART) PROJECT MANAGER SHALL BE NOTIFIED A MINIMUM OF 7 DAYS IN ADVANCE OF PERFORMING ANY LANE CLOSURE OR DETOUR AS WELL AS ANY WORK AFFECTING HART BUS STOPS.

 PHONE: (813) 384-6438
 EMAIL: RODRIGUEZD@GOHART.ORG
- 10. THE UNIVERSITY OF TAMPA SENIOR PROJECT MANAGER FOR DESIGN AND CONSTRUCTION SERVICES SHALL BE CONTACTED FOR CONSTRUCTION COORDINATION OF THE UNIVERSITY OF TAMPA ACCESS POINTS.
- 11. PORTABLE CHANGEABLE (VARIABLE) MESSAGE SIGNS (PCMS) SHALL BE PLACED 500 FT. IN ADVANCE OF THE WORK ZONE FOR A PERIOD OF SEVEN DAYS PRIOR TO THE FIRST DAY OF ROADWAY CONSTRUCTION. MESSAGES SHOULD READ:

MESSAGE 1 MESSAGE 2 NUCCIO BEGINS PKWY "BEGIN DATE" CONST MESSAGE 1 MESSAGE 2 E 12TH REGINS AV E BEGIN DATE CONST MESSAGE 1 MESSAGE 2 N 15TH BEGINS ST "BEGIN DATE" CONST

TWO WEEKS PRIOR TO WEEKDAY LANE CLOSURES, THE MESSAGE FOR THE PCMS SHALL READ (UNLESS OTHERWISE DIRECTED BY THE ENGINEER):

MESSAGE 1

EXPECT LANE CLOSURE TWO WEEKS PRIOR TO WEEKEND LANE CLOSURES, THE MESSAGE FOR THE PCMS SHALL READ (UNLESS OTHERWISE DIRECTED BY THE ENGINEER):

MESSAGE 1

MESSAGE 2

WEEKEND LANE CLOSURE FRI PM TO MON AM

PHASE I NOTES:

THE INTENT OF THIS PHASE IS TO CONSTRUCT DRAINAGE, SIGNALIZATION AND ROADSIDE IMPROVEMENTS ALONG NUCCIO PKWY AND E 15TH ST

- 1. PLACE ADVANCE WARNING TRAFFIC CONTROL DEVICES AS SHOWN IN THE ADVANCED WARNING LAYOUT DETAIL AND AS SHOWN IN STANDARD PLANS FOR ROAD CONSTRUCTION (102 SERIES).
- 2. USE STANDARD PLANS 102-613, 102-615, 102-660 TO CONSTRUCT THE PROPOSED DRAINAGE, CURB, SIDEWALK, DRIVEWAYS AND SIGNALIZATION. EXCEPT THE PROPOSED CYCLE TRACK SEPARATOR AND BICYCLE SIGNALS TO BE PLACED ON THE SEPARATOR.

PHASE II NOTES:

THE INTENT OF THIS PHASE IS TO MILL AND RESURFACE THE ROADWAY AND CONSTRUCT THE CYCLE TRACK SEPARATOR.

- 1. USE STANDARD PLANS 102-613, 102-615, 102-620, 102-625 AND 102-628 TO MILL AND RESURFACE THE PAVEMENT BETWEEN THE NORTHERN CURB LINE AND THE NORTHERN EDGE OF THE PROPOSED CYCLE TRACK SEPARATOR. THE PAVING OPERATION SHALL BE PERFORMED PER THE FINAL LANE CONFIGURATION. LEVEL THE JOINTS BETWEEN ALL UNMILLED PAVEMENT AND THE RESURFACED PAVEMENT TO ELIMINATE THE DIFFERENCE IN ELEVATION.
- 2. PLACE TEMPORARY LANE PAVEMENT MARKINGS IN THE EXISTING CONFIGURATION. PLACE CROSSWALK AND STOP BAR MARKINGS IN THE FINAL CONFIGURATION.

PERFORM THE FOLLOWING WORK IN TWO-BLOCK SEGMENTS AT A TIME:

- 3. PERMANENTLY CLOSE THE EXISTING OUTSIDE TRAVEL LANE AND ADJACENT PARKING LANE. PLACE TEMPORARY 6" WHITE PAVEMENT MARKINGS ALONG THE NORTHERN EDGE OF THE EXISTING CENTER LANE.
- 4. USE STANDARD PLANS 102-613, 102-615, 102-620, 102-625 AND 102-628 TO MILL THE PAVEMENT BETWEEN THE SOUTHERN CURB LINE AND THE EDGE OF THE PROPOSED CYCLE TRACK SEPARATOR. LEVEL THE JOINTS BETWEEN ALL UNMILLED PAVEMENT AND THE RESURFACED PAVEMENT TO ELIMINATE THE DIFFERENCE IN ELEVATION.
- 5. USE STANDARD PLAN 102-613 TO SAWCUT AND REMOVE THE EXISTING PAVEMENT AND ANY BRICK BASE IN THE AREA OF THE CYCLE TRACK SEPARATOR. CONSTRUCT THE PROPOSED SEPARATOR CURB LINE AND PLACE THE PROPOSED BICYCLE SIGNAL HEADS UNTIL THE CYCLE TRACK OPENS.
- 6. RESURFACE THE MILLED PAVEMENT USING STANDARD PLANS 102-613, 102-615, 102-620 AND 102-625.
- 7. PLACE TEMPORARY CROSSWALK AND STOPBAR PAVEMENT MARKINGS IN THE FINAL CONFIGURATION.
- 8. PLACE FINAL PAVEMENT MARKINGS (THERMO).
- 9. UNCOVER BICYCLE SIGNAL HEADS AND SHIFT BICYCLE TRAFFIC TO CYCLE TRACK.
- 10. UPON COMPLETION OF ALL OTHER CONSTRUCTION, REMOVE EXISTING PAVEMENT MARKINGS AS CALLED OUT ON PLANS AND INSTALL FINAL PAVEMENT MARKINGS AND SIGNS AND REMOVE TEMPORARY TRAFFIC CONTROL DEVICES.

R E V I S I O N S

DATE DESCRIPTION DATE DESCRIPTION

KISINGER CAMPO & ASSOCIATES CORP. 201 N FRANKLIN ST, SUITE 400, TAMPA, FL 33602 ENGINEER OF RECORD: FATHY ABDALLA, P.E. NO: 63914 CITY OF TAMPA
MOBILITY DEPARTMENT

ROAD NO. COUNTY PROJECT

COUNTY PROJECT DESIGN NO.


HILLSBOROUGH 21-C-00022

TRAFFIC CONTROL PLAN - (1)

SHEET NO.

18

Christian Tabares 8/2/2023 2:46:47 PM

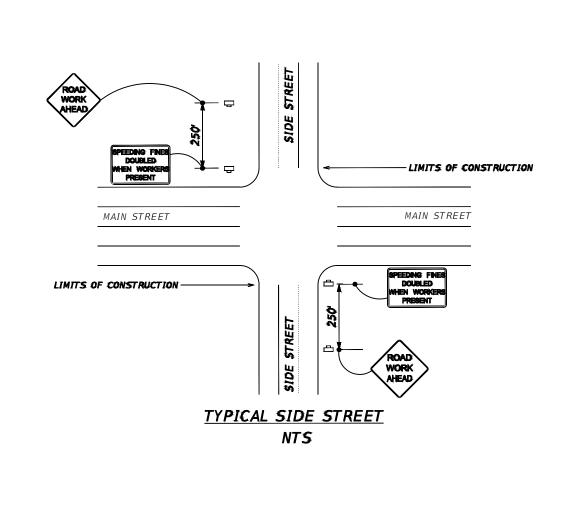

→ LANE IDENTIFICATION AND DIRECTION OF TRAFFIC

№ WORK ZONE SIGN

___ PORTABLE CHANGEABLE (VARIABLE) MĘSSĄGĘ SIGNS ☐ ULE (SEE TTC GENERAL NOTES FOR MORE INFORMATION) ☐ ULE (SEE TTC GENERAL NOTES FOR MORE INFORMATION)

REVISIONS					CITY OF TAMPA		
DATE	DESCRIPTION	DATE	DESCRIPTION	KISINGER CAMPO & ASSOCIATES CORP. 201 N FRANKLIN ST, SUITE 400,	MOBILITY DEPARTMENT		
				TAMPA, FL 33602 ENGINEER OF RECORD:	ROAD NO.	COUNTY	PROJECT DESIGN NO.
		FATHY ABDALLA, P.E. NO: 63914		HILLSBOROUGH	21-C-00022		


8/2/2023 2:46:47 PM


Christian Tabares


TRAFFIC CONTROL PLAN - (2)

SHEET NO.

G:\2201706 Green Spine Cycle Track-COT\Civil\AutoCAD-Current\TTCPRD01.dwg

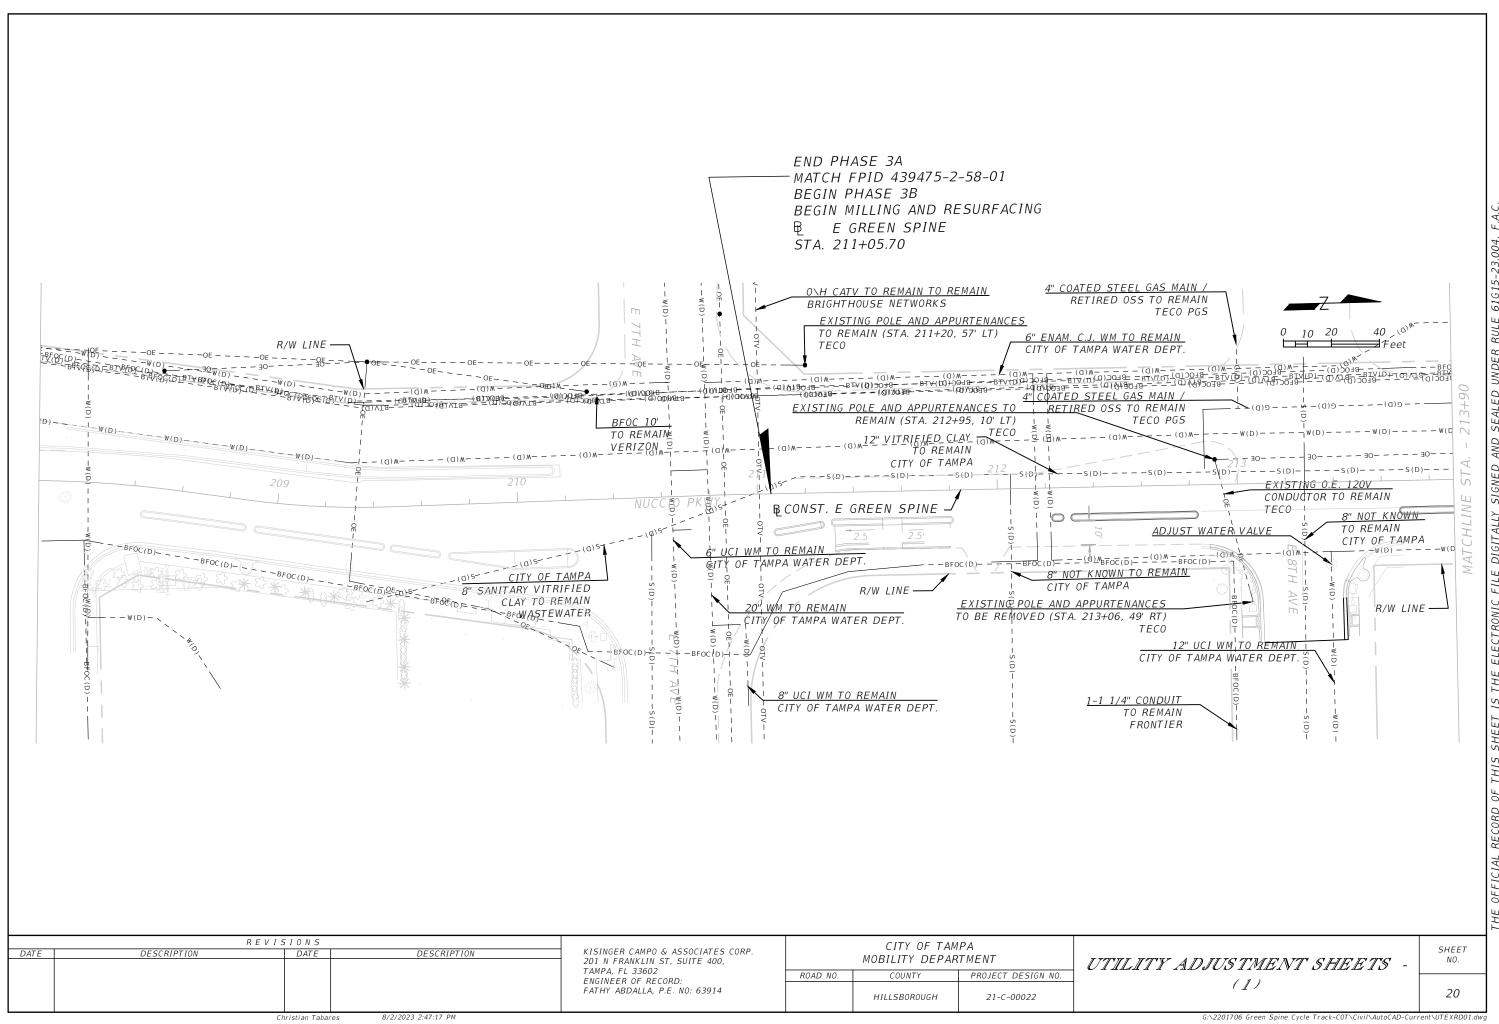

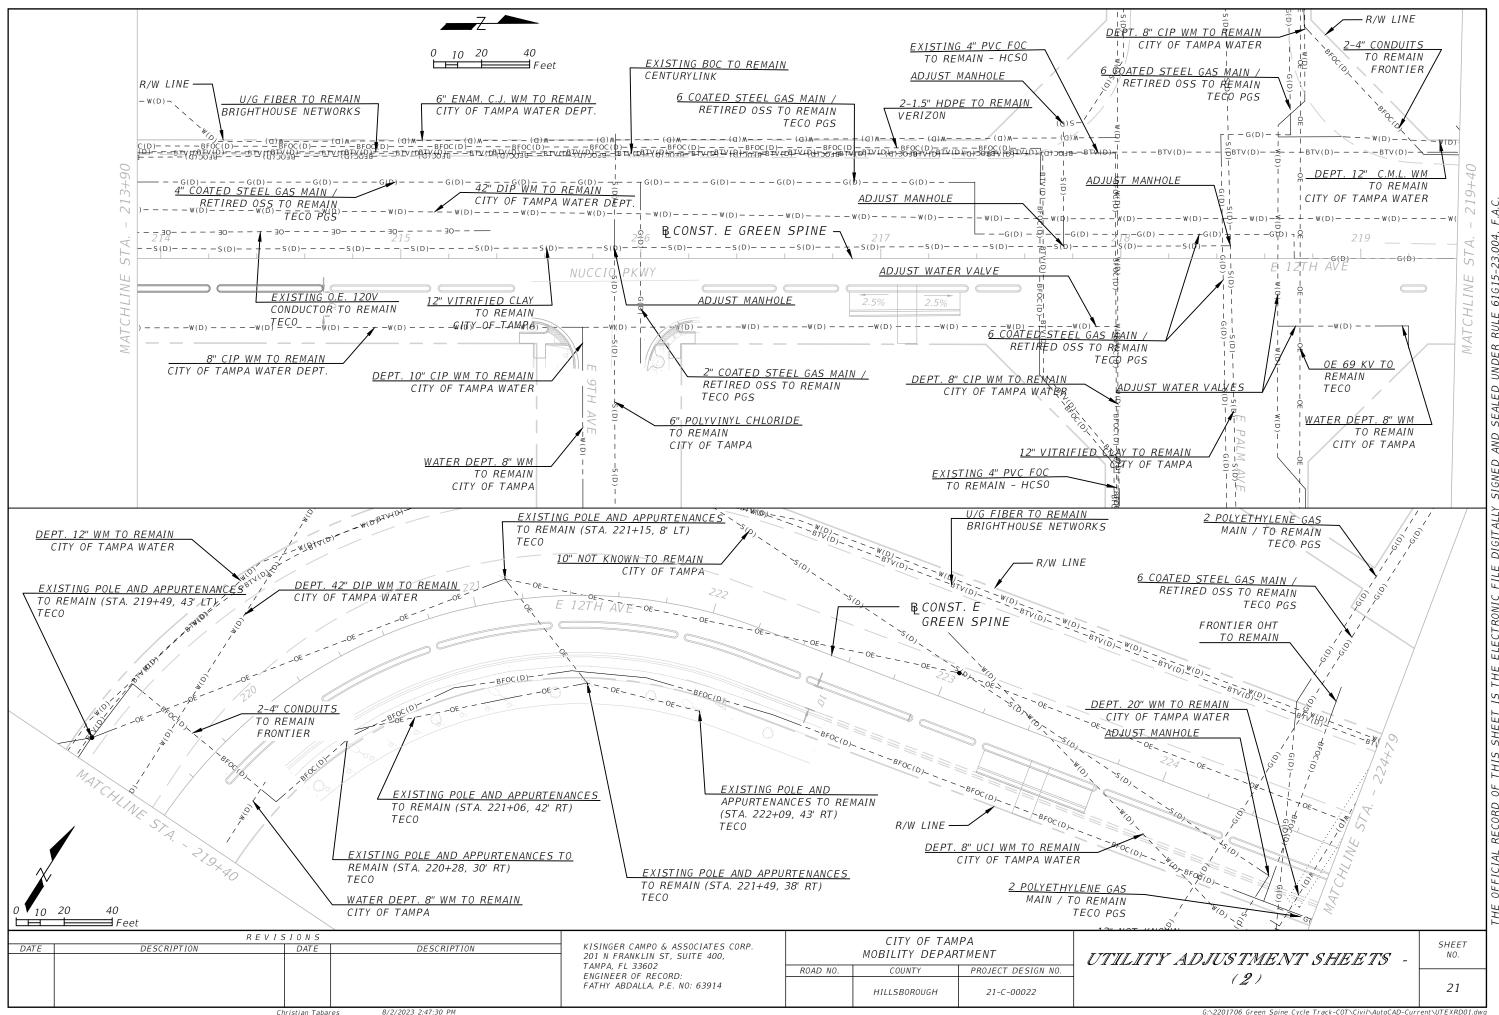

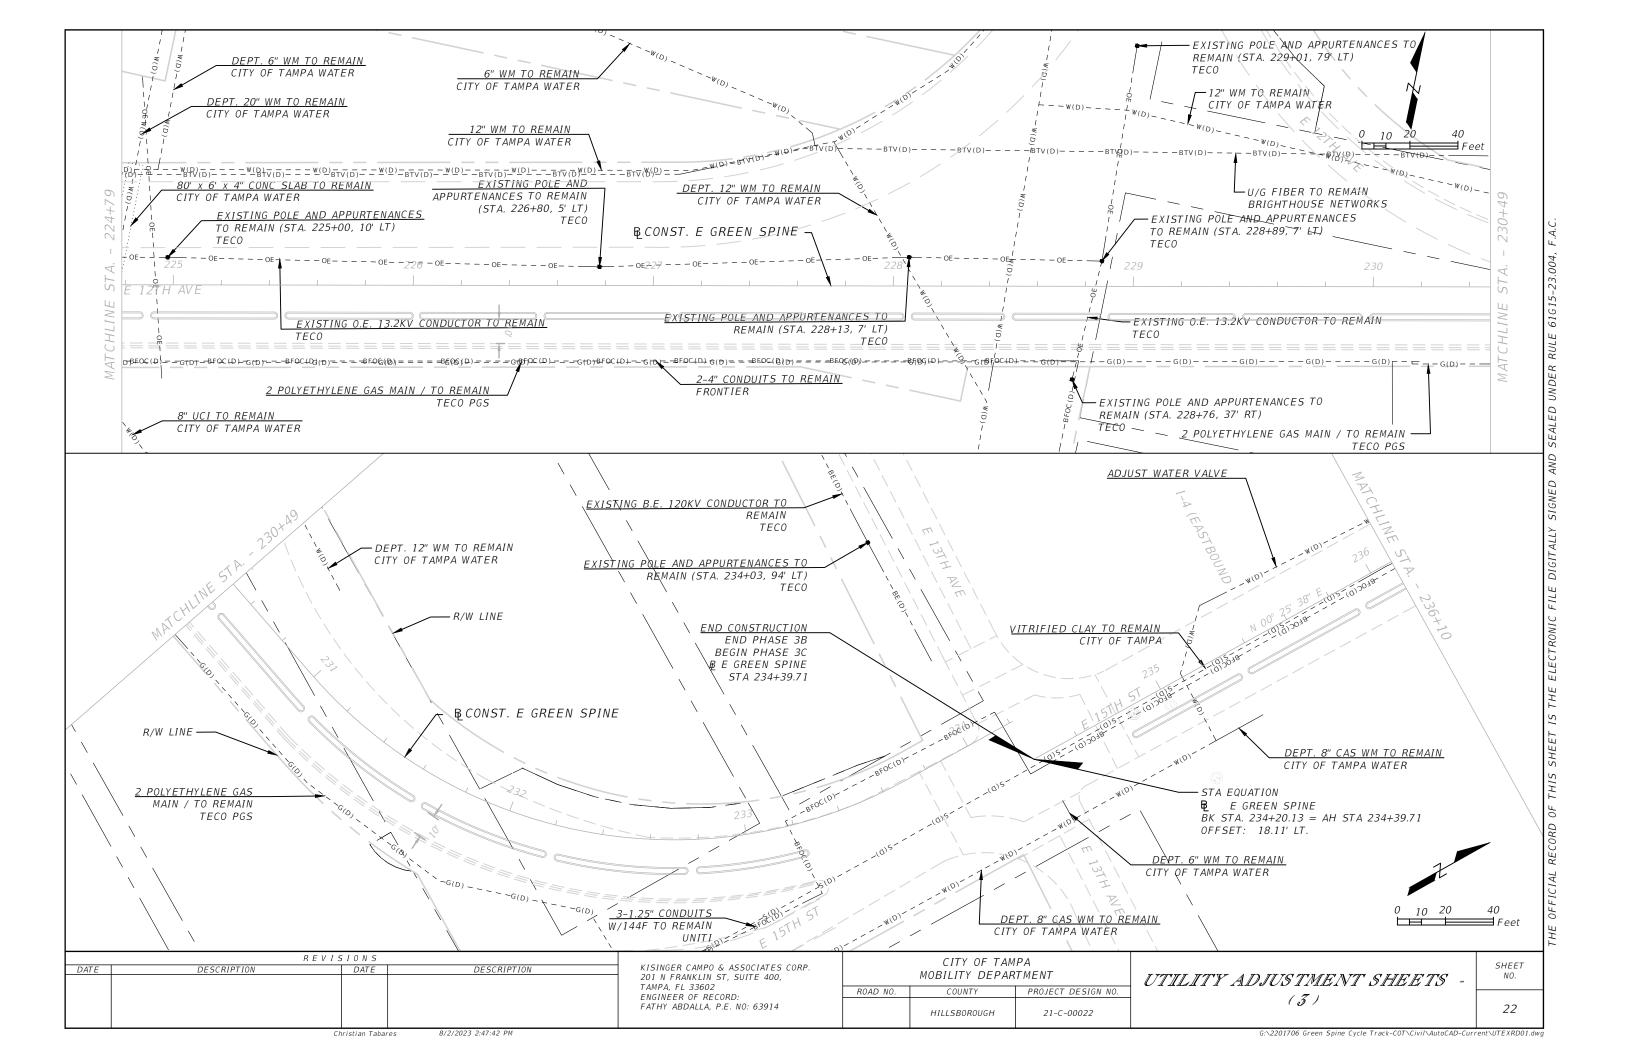

SUMMARY OF LUMP SUM ITEMS								
PAY ITEM NO.	PAY ITEM DESCRIPTION	QUANTITY		DESIGN NOTES	CONSTRUCTION			
		P	F		REMARKS			
0101 1	MOBILIZATION	1						
0102 1	MOBILIZATION OF TRAFFIC	1						
0110 1 1	CLEARING AND GRUBBING	1						

PAY ITEM NOTES

0526 1A IF THE BRICK PAVERS ARE NOT AVAILABLE FROM THE CITY, THE CONTRACTOR WILL NEED TO PROVIDE A SAMPLE AND HAVE IT APPROVED BY THE CITY BEFORE THEY ARE PURCHASED BY THE CONTRACTOR AND INSTALLED.

INDEX OF SUMMARY OF QUANTITIES							
SHEET NO. SHEET DESCRIPTION							
SUMMARY OF LUMP SUM ITEMS							
SQ-2	SUMMARY OF CLEARING AND GRUBBING & REMOVAL ITEMS						
	SUMMARY OF EROSION AND SEDIMENT CONTROL DEVICES						
SQ-3	SUMMARY OF PAVEMENT						
SQ-4	SUMMARY OF MISCELLANEOUS DRAINAGE ITEMS						
SQ-5,6	SUMMARY OF CURB & GUTTER AND/OR TRAFFIC SEPARATORS						
SQ=7	SUMMARY OF SIDEWALK & DETECTABLE WARNINGS						
SQ-8	SUMMARY OF UTILITY ADJUSTMENTS						
	SUMMARY OF PERFORMANCE TURF						

0527 2 ALL DETECTABLE WARNINGS ARE TO BE THE STANDARD ADA 'PLASTIC' MAT TRUNCATED DOMES (RED COLORED) ON CONCRETE ADA RAMPS. SUBMIT SAMPLE OF DETECTABLE WARNING MATERIAL WITH SHOP DRAWING TO THE CITY FOR APPROVAL PRIOR TO INSTALLATION).

PAINT PEDESTAL, POLE AND BACK 646-1-11 OF SIGN ASSEMBLIES BLACK (FEDERAL STANDARD NO. 17038). PAYMENT FOR PAINTING THESE ELEMENTS IS TO BE INCLUDED WITHIN THIS PAY ITEM.

PAINT POLE AND BACK OF SIGN 700-1-11 ASSEMBLIES BLACK (FEDERAL STANDARD NO. 17038). PAYMENT FOR PAINTING THESE ELEMENTS IS TO BE INCLUDED WITHIN THIS PAY

700-1-50 PAINT POLE AND BACK OF SIGN ASSEMBLIES BLACK (FEDERAL STANDARD NO. 17038). PAYMENT FOR PAINTING THESE ELEMENTS IS TO BE INCLUDED WITHIN THIS PAY ITEM.

R E V I S I O N S								
DATE	DESCRIPTION	DATE	DESCRIPTION					

KISINGER CAMPO & ASSOCIATES CORP. 201 N FRANKLIN ST, SUITE 400, TAMPA, FL 33602 ENGINEER OF RECORD: FATHY ABDALLA, P.E. NO: 63914

CITY OF TAMPA MOBILITY DEPARTMENT PROJECT DESIGN NO. ROAD NO. COUNTY HILLSB0R0UGH 21-C-00022

SUMMARY OF QUANTITIES

SHEET

SQ1

Christian Tabares 8/2/2023 2:47:50 PM

	SUMMARY OF CLEARING AND GRUBBING & REMOVAL ITEMS												
PAY ITEM NO.	PAY ITEM DESCRIPTION	LOCATION	SIDE	AREA ID	UNITS	SECONDARY UNITS (IF LUMP SUM)		ТО	TAL	DESIGN NOTES	CONSTRUCTION REMARKS		
		STA. TO STA.				AREA (AC)	LENGTH (LF)	Р	F				
0110 4 10	REMOVAL OF EXIST. CONCRETE				5Y			39					
		212+94.49 to 213+00.96	RT .		6					CURB RAMP REMOVAL			
		213+45.54 to 213+54.92	RT .		7					CURB RAMP REMOVAL			
		212+88.39 to 213+10.13	RT .		11					EXIST. TYPE F CURB			
		213+43.38 to 213+45.54	RT.		6					EXIST. TYPE F CURB			
		215+54.75 to 215+75.05	RT.		7					EXIST. TYPE F CURB			
		216+02.01 to 216+10.54	RT.		2					EXIST. TYPE F CURB			

LOCATION	ARTIFICIAL SEDIMENT SOIL TRACKING INLET PREVENTION PROTECTION DEVICE SYSTEM		CTION	DECTON							
	SIDE	010	04 1	0104	10 3	010	4 15	0104	4 18	DESIGN NOTES	CONSTRUCTION REMARKS
STA. TO STA.		SY		LF		EA		Е	A		TALEN UNIX
		Р	F	Р	F	Р	F	Р	F		
213+48.23	RT.							1			
216+02.73	RT.							1			
217+33.78	RT.							1			
218+80.10	RT.							1			
218+77.76	RT.							1			
227+12.86	RT.							1			
229+96.26	RT.							1			
232+81.87	RT.							1			
234+08.86	LT.							1			
231+70.00	LT.							1			
	SUB-TOTAL:							10			
	TOTAL:							10			

	REVISIONS												
DATE	DESCRIPTION	DATE	DESCRIPTION										

CITY OF TAMPA
MOBILITY DEPARTMENT

ROAD NO. COUNTY PROJECT DESIGN NO.

HILLSBOROUGH 21-C-00022

SUMMARY OF QUANTITIES

SHEET NO.

Christian Tabares 8/2/2023 2:47:50 PM

	SUMMARY OF PAVEMENT													
PAY ITEM	PAY ITEM DESCRIPTION		LOCATION			AREA	UNIT	QUAN	TITY	TOTAL		DESIGN	CONSTRUCT I ON	
NO.	PAY ITEM DESCRIPTION	STA. TO STA.			SIDE	ID	UNII	Р	F	P	F	NOTES	REMARKS	
0327 70 6	Milling Exist Asph Pavt, 1.5" Avg Depth	211+05.70	t o	233+76.67	RT		SY	6604		6604				
0337 7 83	7 83 ASPHALT CONCRETE FRICTION COURSE, TRAFFIC C FC-12.5, PG 76-22		t o	233+76.67	RT		TN	555		555		BUS STOPS SLOPED PAVEMENT INCLUDED		

R E V I S I O N S DESCRIPTION DATE DESCRIPTION	CRIPTION KISINGER CAMPO & ASSOCIATES CORP.		CITY OF TAI MOBILITY DEPA		
	201 N FRANKLIN ST, SUITE 400, TAMPA, FL 33602	ROAD NO.	COUNTY	PROJECT DESIGN NO.	SUMMARY OF QUANTITIES
	ENGINEER OF RECORD: FATHY ABDALLA, P.E. NO: 63914		HILLSBOROUGH	21-C-00022	
Christian Tahasas 8/2/2023 2:47:	EO DM				GN 2201706 Green Spine Cycle Track COTY Civil NutoCAD Curre

SHEET NO.

SQ3

Christian Tabares 8/2/2023 2:47:50 PM

	SUMMARY OF MISCELLANEOUS DRAINAGE ITEMS										
PAY ITEM	PAY ITEM DESCRIPTION	LOCATION	SIDE	UNIT	QUAN	TITY	ТОТ	ΓΑL	DESIGN	CONSTRUCTION	
NO.		STA.			Р	F	Р	F	NOTES	REMARKS	
435 - 100 - 2	INLET SPECIAL DRAINAGE GRATE	211+56.00	RT .	LF	48.0		141				
		217+11.00	RT .	LF	45.0						
		223+50.00	RT .	LF	48.0						

	R E V I S I O N S												
DATE	DESCRIPTION	DATE	DESCRIPTION										

CITY OF TAMPA
MOBILITY DEPARTMENT

ROAD NO. COUNTY PROJECT DESIGN NO.

HILLSBOROUGH 21-C-00022

SUMMARY OF QUANTITIES

SHEET NO.

SQ4

Christian Tabares 8/2/2023 2:47:51 PM

PAY ITEM NO.	PAY ITEM DESCRIPTION		TO STA.	SIDE	UNIT	GROSS		QUANT ITY	NET LE	ENGTH	<i>T0</i> 1	-AL	DESIGN CONSTRUCTION NOTES REMARKS	I
						LENGTH	TYPE	LENGTH	Р	F	Р	F		
0520 2 4	Concrete Curb & Gutter, Type D	211+29.00	to 211+83.00	RT.	LF	54.0			54.0		199			
		213+01.00	to 213+07.00	RT.	LF	6.0			12.0					
		213+45.55	to 213+50.00	RT .	LF	4.5			8.9					
		215+60.32	to 215+70.09	RT.	LF	9.8			9.8					
		216+05.42	to 216+11.73	RT.	LF	6.3			6.3					
			to 217+38.00	RT.	LF	54.0			54.0					
		223+23.00	to 223+77.00	RT.	LF	54.0			54.0					
0520 1 10	Concrete Curb & Gutter, Type F	211+32 00	to 211+80.00	RT.	LF	48.0			48.0		258			
	and a datter, type i		to 213+08.13	RT.	LF	25.0			50.0		230			
			to 213+45.66	RT.	LF	0.1			24.0					
			to 215+74.07	RT.	LF	19.3			31.0					
			to 216+10.54	RT.	LF	5.1			9.0					
		216+87.00	to 217+35.00	RT.	LF	48.0			48.0					
		223+26.00	to 223+74.00	RT .	LF	48.0			48.0					
0520 70	Traffic Separator Concrete - SP-Var. width	211+08.00	to 211+26.00	RT .	SY	7.0			7.0		568.0			
		211+32.00	to 211+80.00	RT.	SY	17.0			17.0					
		212+24.00	to 212+26.00	RT.	SY	1.5			1.5					
		212+32.00	to 212+82.00	RT.	SY	17.5			17.5					
		213+69.00	to 214+19.00	RT .	SY	17.5			17.5					
		214+25.00	to 214+66.00	RT.	SY	14.5			14.5					
		214+72.00	to 215+11.00	RT.	SY	14.0			14.0					
			to 215+46.00	RT.	SY	10.5			10.5					
			to 216+55.00	RT.	SY	10.5			10.5					
			to 216+81.00	RT.	SY	8.0			8.0					
			to 217+35.00	RT .	SY	17.0			17.0					
			to 217+57.00	RT.	SY	6.5			6.5					
			to 219+26.00	RT.	SY	3.5			3.5					
			to 220+19.00 to 220+75.00	RT .	SY SY	16.5 16.5			16.5 16.5					
			to 221+30.00	RT .	SY	16.5			16.5					
			to 221+86.00	RT.	SY	16.5			16.5					
			to 222+42.00	RT.	SY	17.0			17.0					
			to 222+92.00	RT.	SY	16.0			16.0					
			to 223+20.00	RT.	SY	8.5			8.5					
			to 223+74.00	RT.	SY	17.0			17.0					
			to 224+30.00	RT.	SY	17.5			17.5					
DESC		DESCRI		KISING	GER CAMPO &	ASSOCIATES COI	RP.	1		TAMPA				
	201 N FRANKLIN ST, SUITE 400, TAMPA, FL 33602					ROAD NO.	MOBILITY D		1ENT PROJECT DESIG	N NO	SUMMARY OF QUANTITIES			
	ENGINEER OF RECORD: FATHY ABDALLA, P.E. NO: 63914							HILLSBOROU		21-C-00022				

Christian Tabares 8/2/2023 2:47:51 PM

SUMMARY OF CURB & GUTTER AND/OR TRAFFIC SEPARATORS															
PAY		LOC	CAT	ION				C	QUANT ITY			TO	TAL	2501011	
ITEM NO.			STA. TO STA.		SIDE	UNIT	GROSS	DEDU	CTIONS	NET L	ENGTH	707712		DESIGN NOTES	CONSTRUCTION REMARKS
							LENGTH	TYPE	LENGTH	Р	F	Р	F		
0520 70	Traffic Separator Concrete - SP-Var. width	224+36.00	to	224+58.00	RT .	SY	8.0			17.5		568.0			
		224+70.00	to	224+86.00	RT.	SY	6.0			17.5					
		224+92.00	t o	225+42.00	RT .	SY	17.5			17.5					
		225+48.00	t o	225+98.00	RT.	SY	18.0			18.0					
		226+04.00	t o	226+50.00	RT.	SY	16.5			16.5					
		226+56.00	t o	227+06.00	RT.	SY	17.5			17.5					
		227+12.00	t o	227+62.00	RT.	SY	17.5			17.5					
		227+68.00	t o	228+03.00	RT.	SY	12.5			12.5					
		228+09.00	t o	228+45.00	RT.	SY	13.0			13.0					
		228+51.00	t o	228+85.00	RT.	SY	12.5			12.5					
		228+91.00	t o	229+41.00	RT.	SY	17.5			17.5					
		229+47.00	t o	229+94.00	RT.	SY	16.5			16.5					
		230+00.00	to	230+50.00	RT.	SY	17.5			17.5					
		230+56.00	to	231+06.00	RT.	SY	18.0			18.0					
		231+12.00	t o	231+62.00	RT.	SY	19.0			19.0					
		231+68.00	to	232+18.00	RT .	SY	19.0			19.0					
		232+24.00	to	232+74.00	RT .	SY	19.0			19.0					
		232+80.00	to	233+22.00	RT.	SY	15.5			15.5					

R E V I S I O N S											
DATE	DESCRIPTION	DATE	DESCRIPTION								

Christian Tabares

8/2/2023 2:47:51 PM

KISINGER CAMPO & ASSOCIATES CORP. 201 N FRANKLIN ST, SUITE 400, TAMPA, FL 33602 ENGINEER OF RECORD: FATHY ABDALLA, P.E. NO: 63914 CITY OF TAMPA
MOBILITY DEPARTMENT

ROAD NO. COUNTY PROJECT DESIGN NO.

HILLSBOROUGH 21-C-00022

SUMMARY OF QUANTITIES

SHEET NO.

SQ6

G:\2201706 Green Spine Cycle Track-COT\Civil\AutoCAD-Current\SUMQRD01_3B.dwg

THE OLIVER RECORD OF THE SHEET IS THE EECTHOMIC TIEF DIG

						SUM	MARY OF	SIDEWAL	K & DET	ECTABLE W	/ARNINGS	
LOC	AT I	ON			CONC SIL		CONC SI			CTABLE NINGS		
			SIDE	AREA	0522	1	0522	2	052	7 2	DESIGN	CONSTRUCTION REMARKS
CT A	Τ0	CT A		ID	SY	•	SY	,	9	SF.	NOTES	
STA.	10	SIA.			Р	F	Р	F	Р	F		
211+52.00	to	211+60.00	RT .				10.7					
217+07.00	to	217+15.00	RT .				10.7					
223+46.00	to	223+54.00	RT .				10.7					
213+00.84	to	213+07.91	RT .				3.5					
213+45.36	to	213+49.66	RT .				2.2					
215+60.32	to	215+69.61	RT .				3.8					
212+94.50	to	213+00.96	RT .		4.9							
213+51.48	to	213+53.95	RT .		2.4							
215+49.49	to	215+60.32	RT .		8.9							
216+07.45	to	216+22.63	RT .		10.8							
213+00.84	to	213+02.84	RT .						10.3			
213+44.78	to	213+46.78	RT .						10.3			
215+67.61	to	215+69.61	RT .						13.6			
216+07.45	to	216+09.45	RT .						14.8			
				SUB-TOTAL:	27.0		42.0		49.0			
				TOTAL:	27.0		42.0		49.0			

	R E V I S I O N S											
DATE	DESCRIPTION	DATE	DESCRIPTION									

CITY OF TAMPA
MOBILITY DEPARTMENT

ROAD NO. COUNTY PROJECT DESIGN NO.

HILLSBOROUGH 21-C-00022

SUMMARY OF QUANTITIES

SHEET NO.

SQ7

Christian Tabares 8/2/2023 2:47:52 PM

		S	UMMARY	OF MIS	CELLA	NEOUS	DRAI	NAGE	ITEMS	
PAY ITEM	PAY ITEM DESCRIPTION	LOCATION	SIDE	UNIT	QUAN	QUANT ITY		AL	DESIGN	CONSTRUCTION
NO.		STA.			Р	F	Р	F	NOTES	REMARKS
425 - 5	MANHOLE, ADJUST	215+90.00	LT.	EA	1		4			
425 - 5	MANHOLE, ADJUST	217+76.00	LT.	EA	1					
425 - 5	MANHOLE, ADJUST	218+44.00	LT.	EA	1					
425 - 5	MANHOLE, ADJUST	224+55.00	RT.	EA	1					
9910	ADJUST VALVE BOX (HEIGHT)	PROJECT LIMITS	LT./RT.	EA	2		2			

							SU	MMARY (OF PERF	ORMANC	E TURF																															
LOCATION STA. TO STA.		ON			(LF)	LF)	PERFOR TURF	RMANCE (SOD)		STIC ON MAT																																
		SIDE A		H.) H	0570	1 2	0571 1 11 SY		DESIGN NOTES	CONSTRUCTION																															
		CTA			ENGT	IDT	SY			NOTES	REMARKS																															
SIA.	. 10	SIA.			LE	W	Р	F	P F		P F		P F		P F		P F		P F		P F		P F		P F		P F		P F		P F		P F		P F		P F		P F			
21300.96	to	213+03.77	RT.	71A0D8			0.8																																			
213+46.36	to	213+51.48	LT.	71A067			4.2																																			
					SU	JB-TOTAL:	5.0																																			
						TOTAL:	5.0																																			

	R E V I S I O N S								
DATE	DESCRIPTION	DATE	DESCRIPTION						

CITY OF TAMPA MOBILITY DEPARTMENT ROAD NO. COUNTY PROJECT DESIGN NO. HILLSB0R0UGH 21-C-00022

SUMMARY OF QUANTITIES

SHEET NO.

8/2/2023 2:47:52 PM Christian Tabares

CITY OF TAMPA MOBILITY DEPARTMENT

CONTRACT PLANS

LOCATION OF PROJECT

INDEX OF SIGNING AND PAVEMENT MARKING PLANS

SHEET NO. SHEET DESCRIPTION

S-1 KEY SHEET

S-2 TABULATION OF QUANTITIES

S-3 SIGNING AND PAVEMENT MARKING DETAILS

GENERAL NOTES


SIGNING AND MARKING PLANS

5-4

S-5 THRU S-9


FINANCIAL PROJECT ID 439476-3-58-01 (FEDERAL FUNDS)

E/W GREEN SPINE CYCLE TRACK - PH. 3B FROM 7TH AVE. TO 13TH AVE.

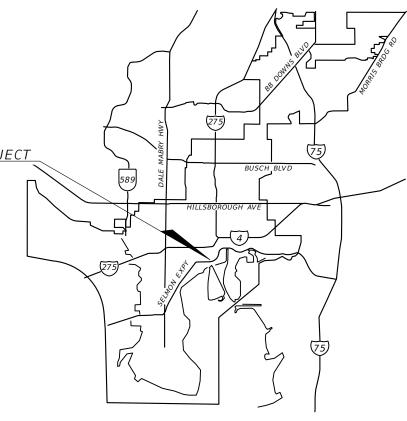

SIGNING AND PAVEMENT MARKING PLANS

FINAL SUBMITTAL FEBRUARY 2023

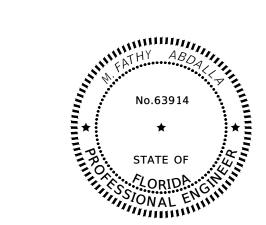

THIS ITEM HAS BEEN DIGITALLY SIGNED AND SEALED BY

ON THE DATE ADJACENT TO THE SEAL

PRINTED COPIES OF THIS DOCUMENT ARE NOT CONSIDERED SIGNED AND SEALED AND THE SIGNATURE MUST BE VERIFIED ON ANY ELECTRONIC COPIES.

KISINGER CAMPO & ASSOCIATES CORP. 201 N FRANKLIN ST, SUITE 400, TAMPA, FL 33602

FATHY ABDALLA, P.E. NO. 63914

CITY OF TAMPA PROJECT MANAGER:

NINA S MABILLEAU E.I.

CONSTRUCTION	FISCAL	SHEET				
CONTRACT NO.	YEAR	NO.				
21-C-00022	2021	S-1				

	<u>'</u>	ABULATION OF	QUAI						WD50	<u> </u>								
DAV								IEET N							TOT		GR	AND
PAY ITEM	DESCRIPTION	UNIT		N	JCCIO PARK	WAY / 12	th AVE	/15th	St fr	om 7th AVE	to 13	Bth AVE			TH SHE	IS	l	TAL
NO.			5 - 5	5	5-6	5	- 7	5 - 8	3	5-9					3111	- L 1		
		P	LAN I	FINAL	PLAN FINAL	PLAN	FINAL	PLAN	FINAL	PLAN FINAL	PLAN	FINAL	PLAN	FINAL	PLAN	FINAL	PLAN	FINA
?3 - 1 - 3	PATTERNED PAVEMENT, INCLUDING GREEN BIKE LANES	SY	44		84					22					150			
0 - 1 - 11	SINGLE POST SIGN, F&I GROUND MOUNT, UP TO 12 SF	AS	1		2					2					5			
0-1-18	SINGLE POST SIGN, F&I GROUND MOUNT, IN-STREET FLEXIBLE POST SIGN	AS	3		4					1					8			
00 - 1 - 50	SINGLE POST SIGN, RELOCATE	AS	1												1			
0 - 1 - 60	SINGLE POST SIGN, REMOVE	AS								1					1			
05 - 11 - 3	DELINEATOR, FLEXIBLE HIGH VISABILITY MEDIAN		5		5	-				1					11			
710-90	PAINTED PAVEMENT MARKINGS, FINAL SURFACE	LS																
*	RAISED PAVEMENT MARKER, TYPE B	EA			5					20					25			
*	PAINTED PAVEMENT MARKINGS, STANDARD, WHITE, SOLID, 6"	GM 0	.044		0.072	0.087		0.097		0.094					0.394			
*	PAINTED PAVEMENT MARKINGS, STANDARD, WHITE, SOLID FOR INTERCHANGE AND URBAN ISLAND, 8"	GM			0.006					0.026					0.032			
*	PAINTED PAVEMENT MARKINGS, STANDARD, WHITE, SOLID FOR CROSSWALK AND ROUNDABOUT, 12"	LF	70		410										480			
*	PAINTED PAVEMENT MARKINGS, STANDARD, WHITE, SOLID FOR DIAGONAL OR CHEVRON, 18"	LF								32					32			
*	PAINTED PAVEMENT MARKINGS, STANDARD, WHITE, SOLID FOR STOP LINE OR CROSSWALK, 24"	LF	17		405					19					441			
*	PAINTED PAVEMENT MARKINGS, STANDARD, WHITE, 2-4 DOTTED GUIDELINE, 6"	GM 0	.064		0.113										0.177			
*	PAINTED PAVEMENT MARKINGS, STANDARD, WHITE, 6-10 SKIP, 6"	GM			0.015										0.015			
*	PAINTED PAVEMENT MARKINGS, STANDARD, WHITE, MESSAGE OR SYMBOL	EA	6		10					2					18			
*	PAINTED PAVEMENT MARKINGS, STANDARD, WHITE, ARROWS	EA	6		14					3					23			
*	PAINTED PAVEMENT MARKINGS, STANDARD, YELLOW, SOLID, 6"		.069	-	0.130	0.087	1	0.097		0.086					0.469			
*	PAINTED PAVEMENT MARKINGS, STANDARD, YELLOW, SOLID FOR DIAGONAL OR CHEVRON, 18"	LF	.005		0.130	0.007		0.037		32					32			
*	PAINTED PAVEMENT MARKINGS, STANDARD, YELLOW, SKIP, 6"	GM				0.087		0.097		-					0.184			
	PAINTED PAVEMENT MARKINGS, STANDARD, YELLOW, ISLAND NOSE	SF	18		18					4					40			
1-11-123	THERMOPLASTIC, STANDARD, WHITE, SOLID, 12" FOR CROSSWALK AND ROUNDABOUT	LF	70		410										480			
1-11-124	THERMOPLASTIC, STANDARD, WHITE, SOLID, 18" FOR DIAGONALS AND CHEVRONS	LF			30					33					63			
1 - 11 - 125	THERMOPLASTIC, STANDARD, WHITE, SOLID, 24" FOR STOP LINE AND CROSSWALK	LF	17		65					19					101			
1-11-141	THERMOPLASTIC, STANDARD, WHITE, 2-4 DOTTED GUIDELINE/ 6-10 GAP EXTENSION, 6"	GM 0	.064		0.128					0.060					0.252			
1 - 11 - 160	THERMOPLASTIC, STANDARD, WHITE, MESSAGE OR SYMBOL	EA								2					2			
1 - 11 - 170	THERMOPLASTIC, STANDARD, WHITE, ARROW	EA	6		14					3					23			
1-11-224	THERMOPLASTIC, STANDARD, YELLOW, SOLID, 18" FOR DIAGONAL OR CHEVRON	LF								32					32			
1-14-125	THERMOPLASTIC, PREFORMED, WHITE, SOLID, 24" FOR CROSSWALK	LF			340										340			
1 - 14 - 160	THERMOPLASTIC, PREFORMED, WHITE, SYMBOL (BIKE)	EA	6		10					2					18			
1 - 16 - 101	THERMOPLASTIC, STANDARD-OTHER SURFACES, WHITE, SOLID, 6"	GM 0	.044		0.072	0.087		0.097		0.094					0.394			
1 - 16 - 102	THERMOPLASTIC, STANDARD-OTHER SURFACES, WHITE, SOLID, 8"	GM			0.006					0.026					0.032			
1 - 16 - 201	THERMOPLASTIC, STANDARD-OTHER SURFACES, YELLOW, SOLID, 6"	GM 0.	.069		0.130	0.087		0.097		0.086					0.469			
1 - 16 - 231	THERMOPLASTIC, STANDARD-OTHER SURFACES, YELLOW, SKIP, 6", 10-30 SKIP	GM																
	THERMOPLASTIC, STANDARD-OTHER SURFACES, YELLOW, SKIP, 6", 3-9 SKIP	GM 0.	.025		0.035	0.087		0.097		0.059					0.303			

R E V I S I O N S								
DATE	DESCRIPTION	DATE	DESCRIPTION					

CITY OF TAMPA
MOBILITY DEPARTMENT


ROAD NO. COUNTY PROJECT DESIGN NO.

HILLSBOROUGH 21-C-00022

TABULATION OF QUANTITIES

SHEET NO.

S-2

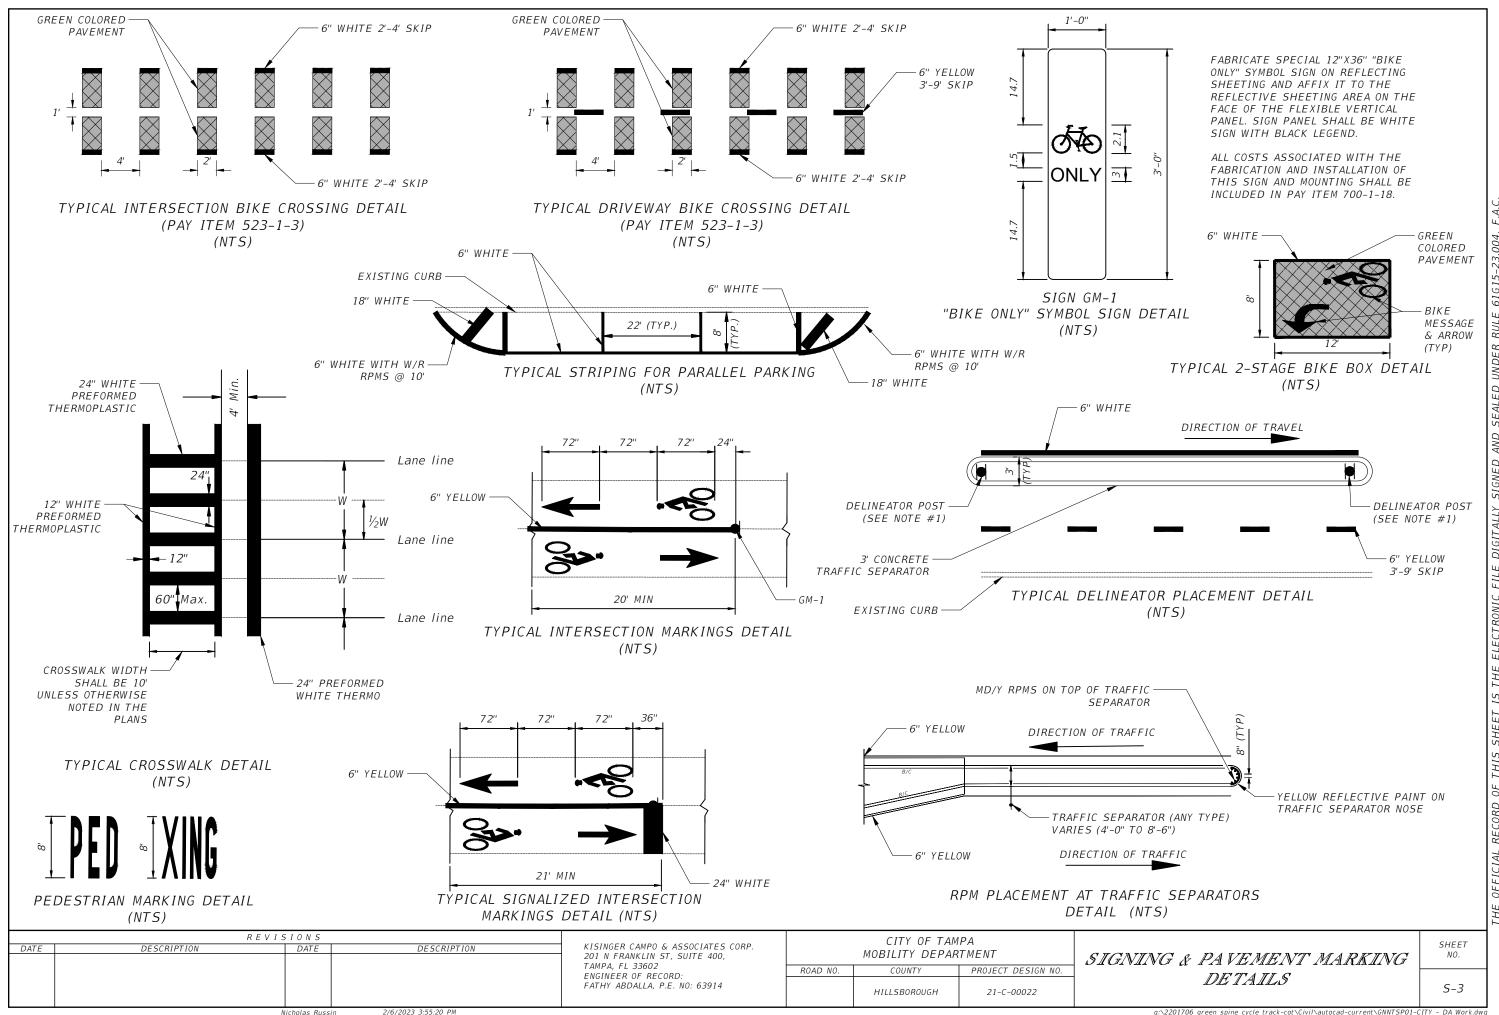

GENERAL NOTES:

- 1. USE YELLOW RETRO-REFLECTIVE SHEETING ON BOTH SIDES OF THE DELINEATOR. INSTALL THE POST SO THAT THE TOP IS 4' ABOVE THE GRADE AT THE EDGE OF THE PAVEMENT.
- 2. ALL PEDESTRIAN/BICYCLE WARNING SHALL BE IN ACCORDANCE WITH THE MUTCD, SECT. 1A-12, COLOR CODE "F"-FLUORESCENT YELLOW-GREEN.
- 3. PAVEMENT MARKINGS ON ASPHALT PAVEMENT SHALL BE STANDARD THERMOPLASTIC EXCEPT FOR BICYCLE MARKINGS AND SPECIAL EMPHASIS CROSSWALKS. USE PREFORMED THERMOPLASTIC FOR BICYCLE MARKINGS AND SPECIAL EMPHASIS CROSSWALKS.
- 4. UNLESS OTHERWISE NOTED ON PLAN SHEETS, ALL PROPOSED CROSSWALKS ACROSS MAIN STREETS SHALL BE 10' IN WIDTH AND ALL CROSSWALKS ACROSS SIDE STREETS SHALL BE 6' IN WIDTH. MEASUREMENTS SHALL BE FROM INSIDE TO INSIDE OF 12" STRIPES.
- 5. PAY ITEM FOOT NOTE 710-90 SHALL INCLUDE ALL PAVEMENT MARKINGS APPLICATIONS NEEDED BEFORE APPLYING THE THERMOPLASTIC APPLICATION.
- 6. ALL BRICK STREETS AND GRANITE CURBS SHALL BE RETAINED AND PRESERVED IN PLACE.

	REVIS	5 I O N S	
DATE	DESCRIPTION	DATE	DESCRIPTION

KISINGER CAMPO & ASSOCIATES CORP. 201 N FRANKLIN ST, SUITE 400, TAMPA, FL 33602 ENGINEER OF RECORD: FATHY ABDALLA, P.E. NO: 63914 CITY OF TAMPA
MOBILITY DEPARTMENT


ROAD NO. COUNTY PROJECT DESIGN NO.

HILLSBOROUGH 21-C-00022

GENERAL NOTES

SHEET NO.

5-4

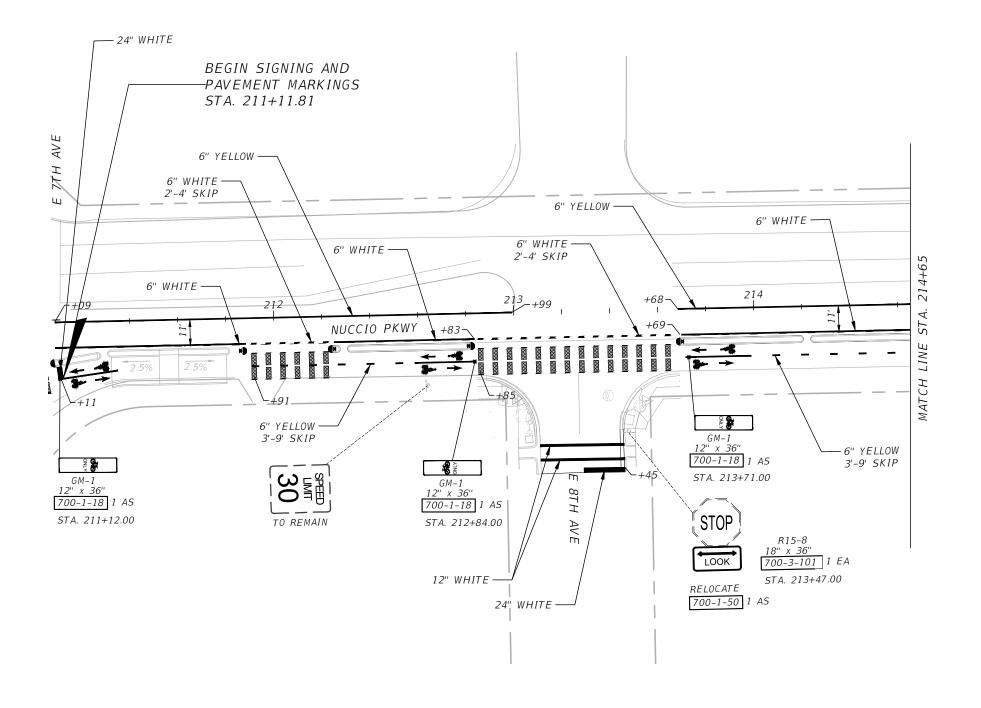

SEE SHEET S-3 FOR DELINEATOR PLACEMENT DETAIL AND TYPICAL INTERSECTION MARKINGS DETAIL

705-11-3 5 EA

	R E V I S I O N S									
DATE	DESCRIPTION	DATE	DESCRIPTION							


KISINGER CAMPO & ASSOCIATES CORP. 201 N FRANKLIN ST, SUITE 400, TAMPA, FL 33602 ENGINEER OF RECORD: FATHY ABDALLA, P.E. NO: 63914


CITY OF TAMPA MOBILITY DEPARTMENT PROJECT DESIGN NO. ROAD NO. COUNTY *HILLSBOROUGH* 21-C-00022


SIGNING AND PAVEMENT MARKING PLAN (1)


SHEET

S-5

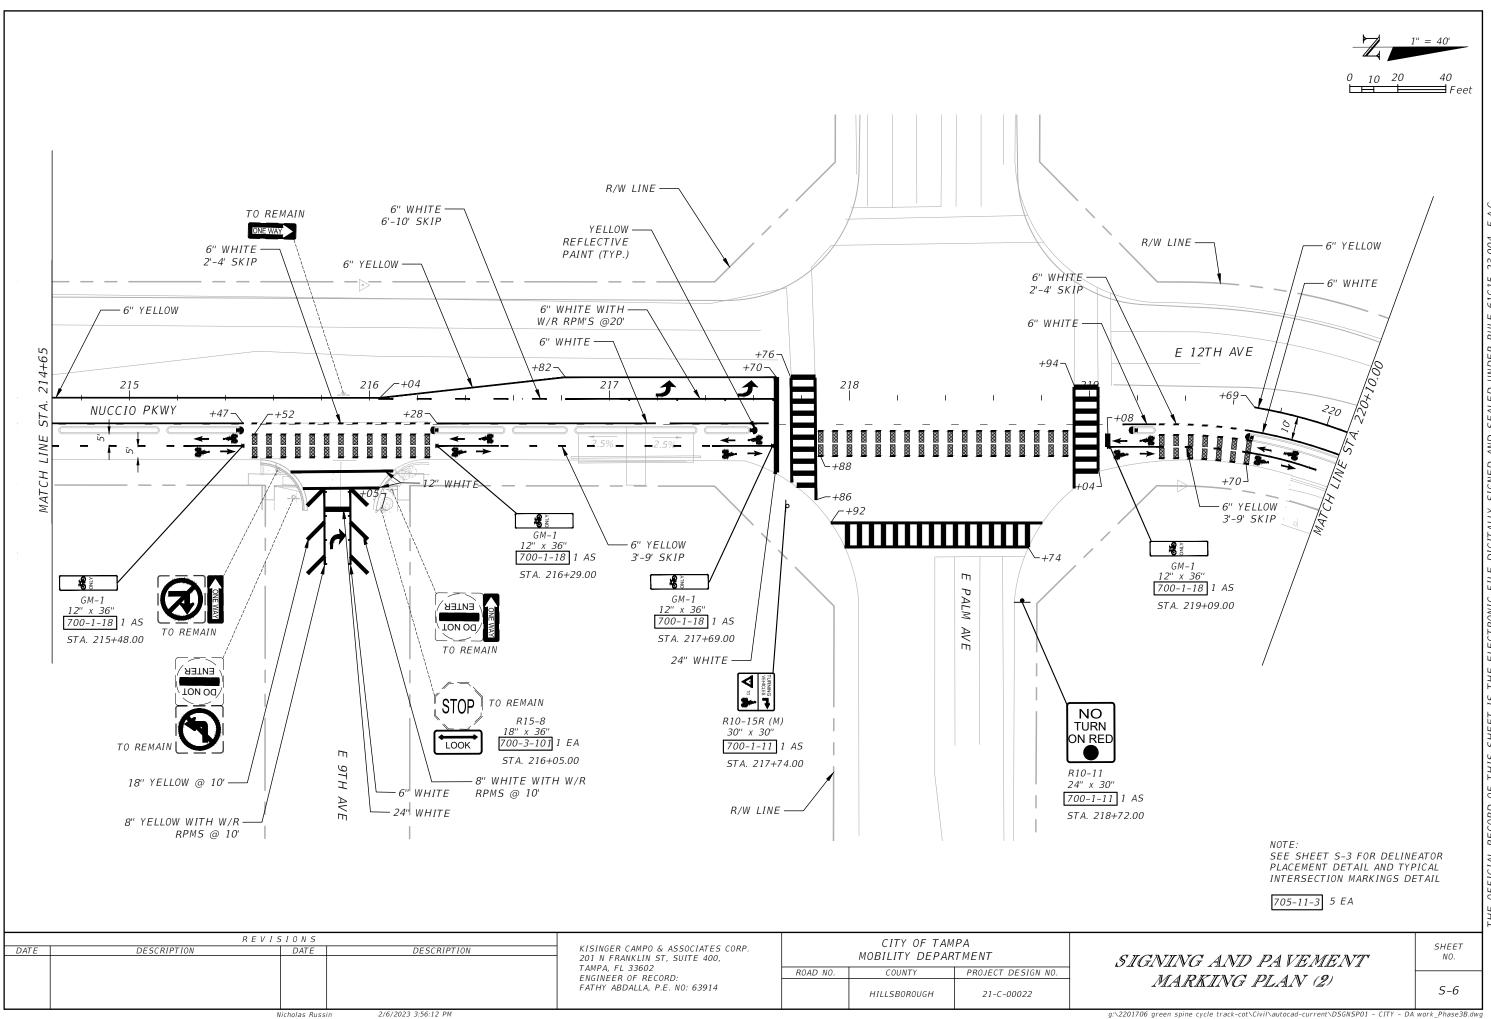

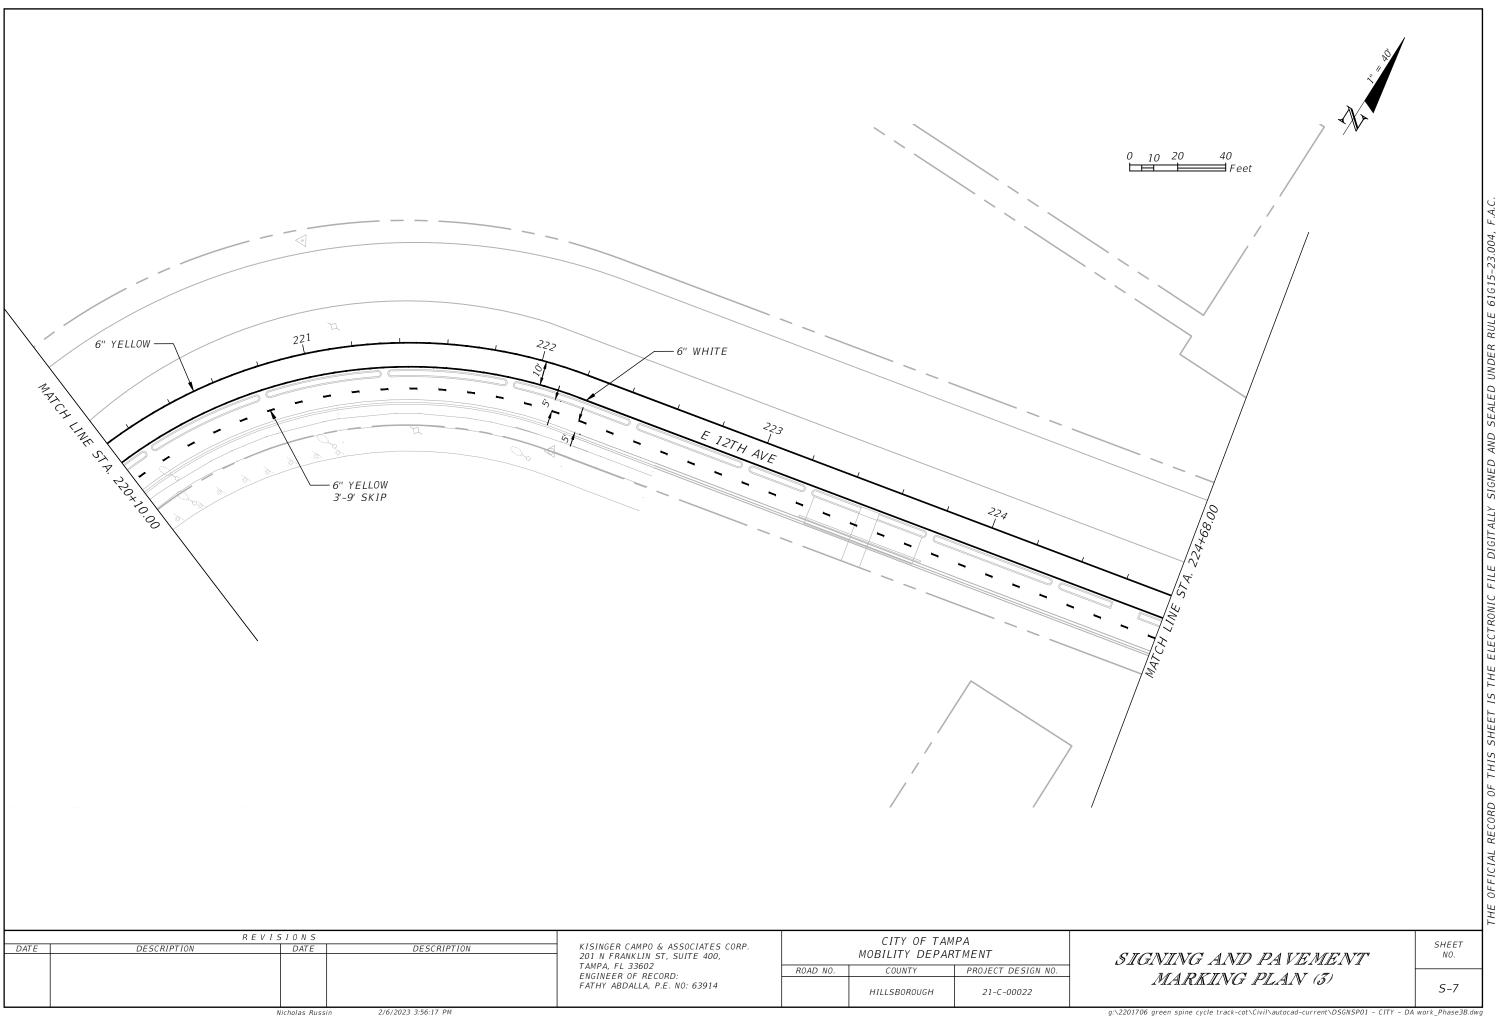

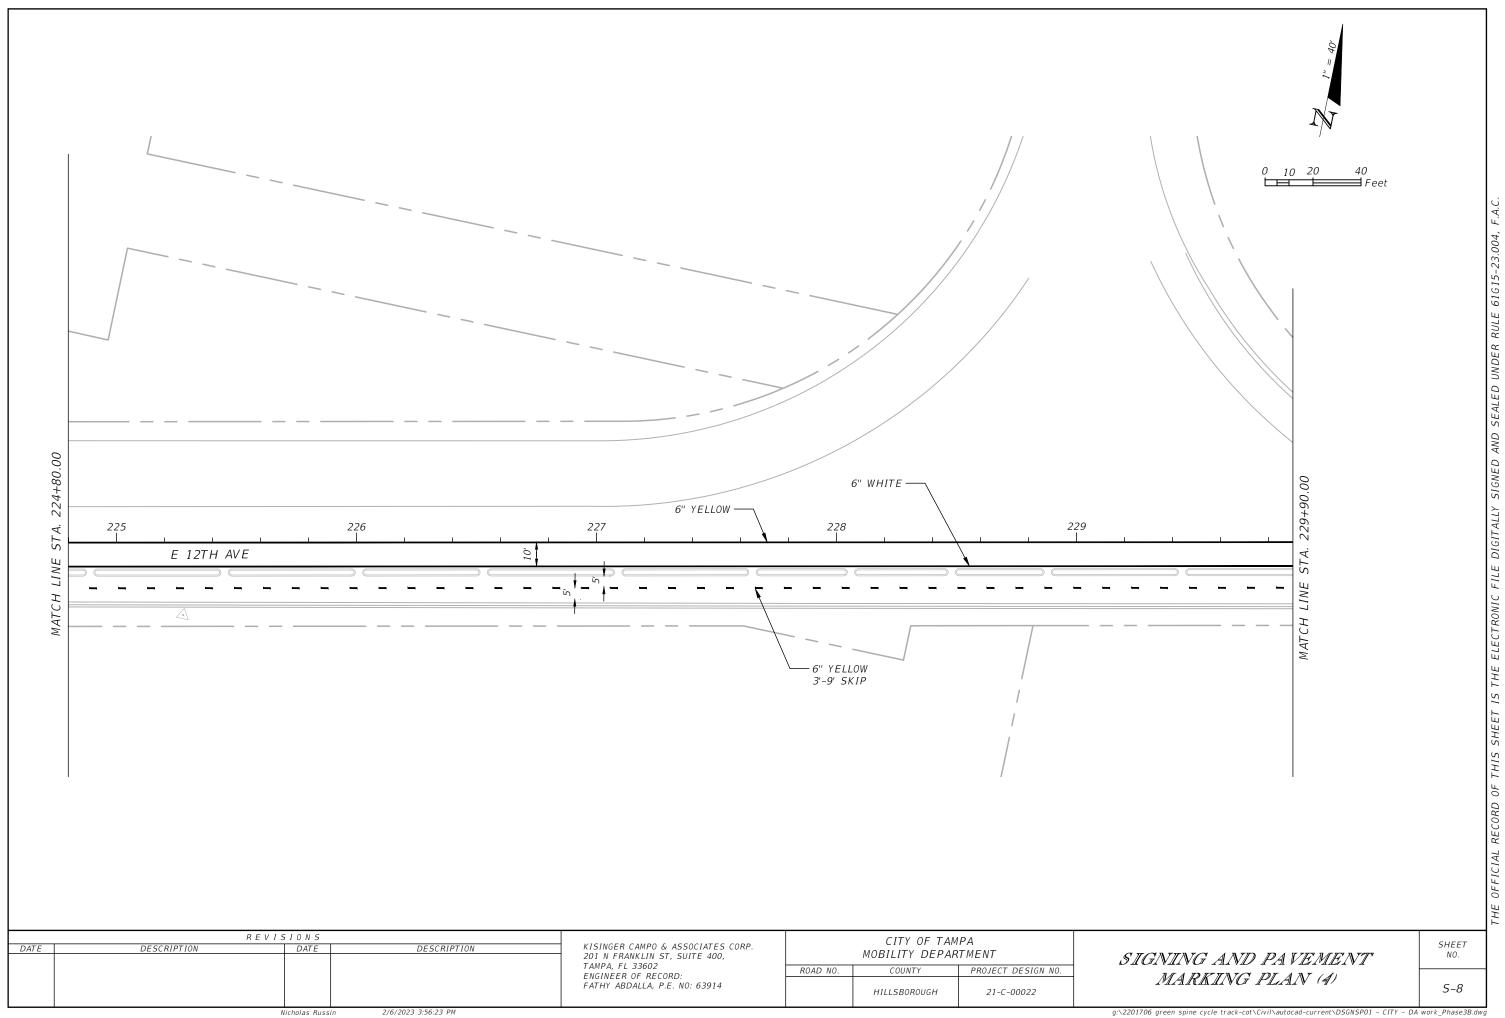

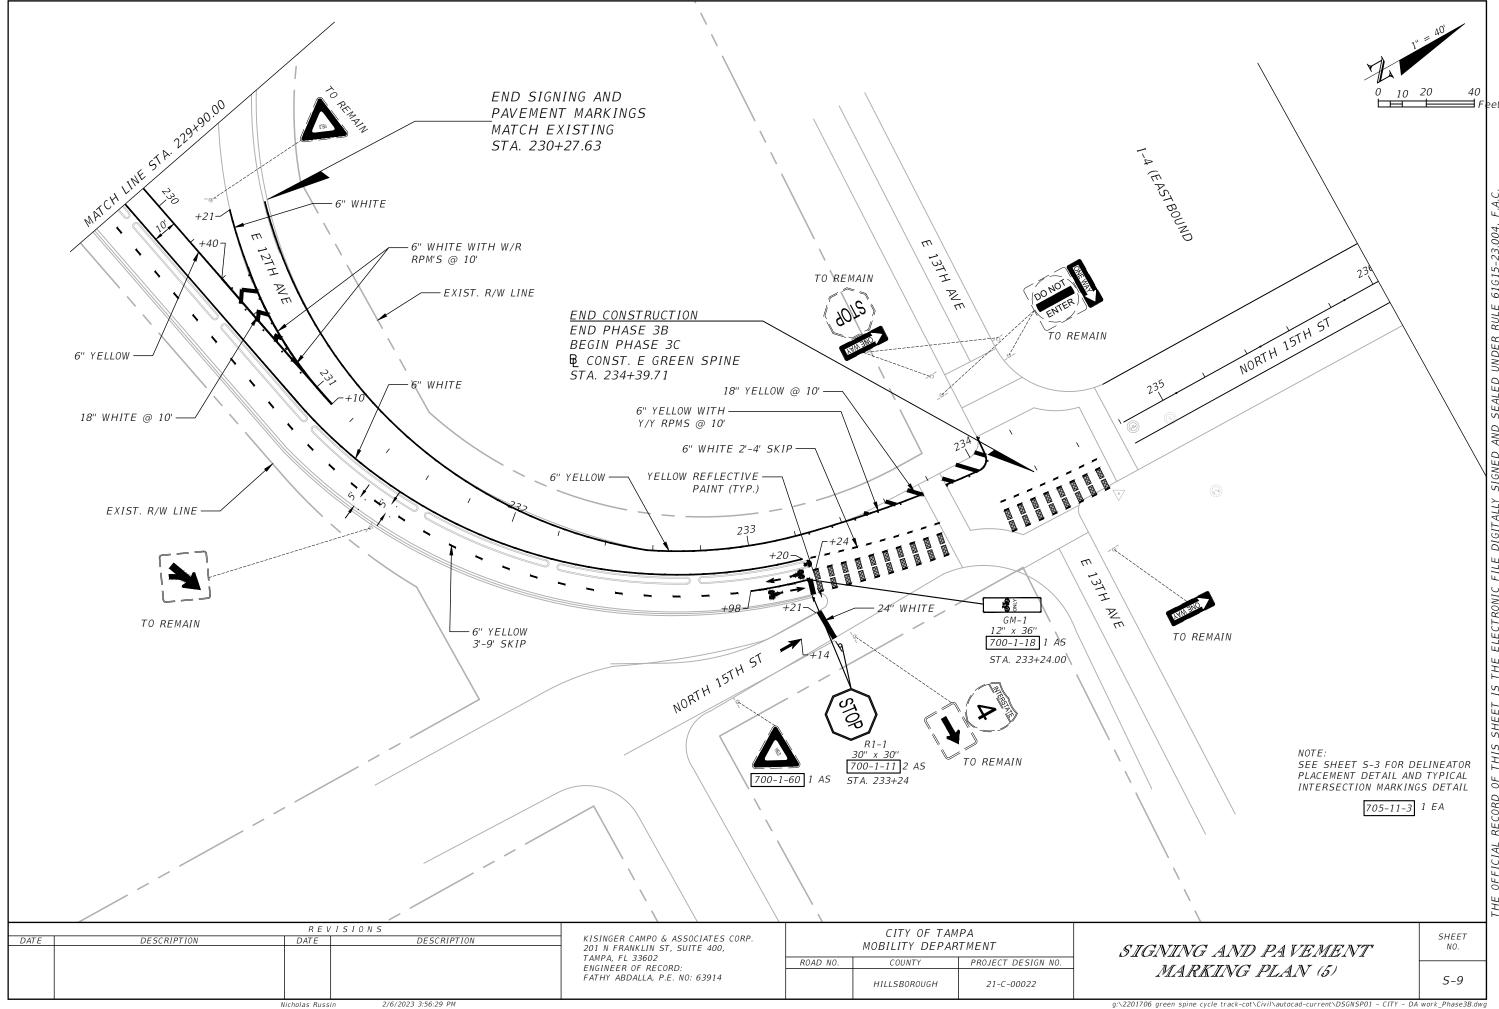

CITY OF TAMPA MOBILITY DEPARTMENT

CONTRACT PLANS

LOCATION OF PROJECT

INDEX OF SIGNALIZATION PLANS

SHEET NO. SHEET DESCRIPTION

T – 1 KEY SHEET


T-2 TABULATION OF QUANTITIES

T-3 GENERAL NOTES


T-4SIGNALIZATION PLAN FINANCIAL PROJECT ID 439476-3-58-01 (FEDERAL FUNDS)

E/W GREEN SPINE CYCLE TRACK -PH. 3B FROM 7TH AVE. TO 13TH AVE.

SIGNALIZATION PLANS

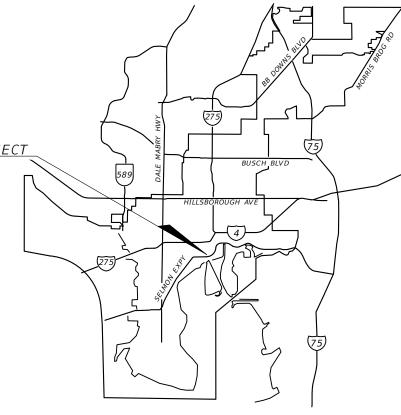

FINAL SUBMITTAL FEBRUARY 2023

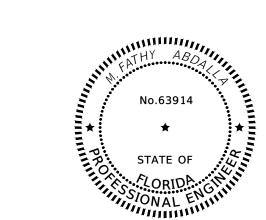

THIS ITEM HAS BEEN DIGITALLY SIGNED AND SEALED BY

ON THE DATE ADJACENT TO THE SEAL

PRINTED COPIES OF THIS DOCUMENT ARE NOT CONSIDERED SIGNED AND SEALED AND THE SIGNATURE MUST BE VERIFIED ON ANY ELECTRONIC COPIES.

KISINGER CAMPO & ASSOCIATES CORP. 201 N FRANKLIN ST, SUITE 400, TAMPA, FL 33602

FATHY ABDALLA, P.E. NO. 63914

CITY OF TAMPA PROJECT MANAGER:

NINA S. MABILLEAU E.I.

CONSTRUCTION	FISCAL	SHEET
CONTRACT NO.	YEAR	NO.
21-C-00022	23	T-1

	TABULATION OF QUANTITIES																
			SHEET NUMBERS														
	DESCRIPTION	IPTION UNIT	T -	- 4												GRA TO	
NO.			PLAN	FINAL	PLAN	FINAL	PLAN	FINAL	PLAN	FINAL	PLAN	FINAL	PLAN	FINAL		PLAN	FINAL
630-2-11	CONDUIT, FURNISH & INSTALL, OPEN TRENCH	LF	10													10	
630-2-12	CONDUIT, FURNISH & INSTALL, DIRECTIONAL BORE	LF	250													250	
632-7-2	SIGNAL CABLE- REPAIR/REPLACE/OTHER, FURNISH & INSTALL	LF	95													95	
635-2-11	PULL & SPLICE BOX, F&I, 13" x 24" COVER SIZE	EA	2													2	
646 - 1 - 11	ALUMINUM SIGNALS POLE, PEDESTAL	EA	2													2	
650 - 1 - 14	VEHICULAR TRAFFIC SIGNAL, FURNISH & INSTALL ALUMINUM, 3 SECTION, 1 WAY	AS	4								·					4	
670 - 5 - 400	TRAFFIC CONTROLLER ASSEMBLY, MODIFY	AS	1													1	

REVISIONS								
DATE	DESCRIPTION	DATE	DESCRIPTION					

KISINGER CAMPO & ASSOCIATES CORP. 201 N FRANKLIN ST, SUITE 400, TAMPA, FL 33602 ENGINEER OF RECORD: FATHY ABDALLA, P.E. NO: 63914 CITY OF TAMPA
MOBILITY DEPARTMENT

ROAD NO. COUNTY PROJECT DESIGN NO.

HILLSBOROUGH 21-C-00022

TABULATION OF QUANTITIES

SHEET NO.

T-2

GENERAL NOTES:

- 1. ALL RELOCATED PED POLES SHALL BE GROUNDED WITHIN THE FOUNDATION OF THE POLES OR WITHIN THE PULL BOX IF WITHIN 10 FEET FROM THE POLE LOCATION.
- 2. CONTRACTOR IS RESPONSIBLE TO REPLACE ANY DAMAGE EQUIPMENT DUE TO RELOCATION WITH NO ADDITIONAL COMPENSATION.
- 3. ALL BICYCLE POLES MUST HAVE A SUPPORT COLLAR WITH ROLL PINS.

R E V I S I O N S									
DATE	DESCRIPTION	DATE	DESCRIPTION] K					
				2					
				T					
				E					
				F					
				1					

KISINGER CAMPO & ASSOCIATES CORP. 201 N FRANKLIN ST, SUITE 400, TAMPA, FL 33602 ENGINEER OF RECORD: FATHY ABDALLA, P.E. NO: 63914 CITY OF TAMPA
MOBILITY DEPARTMENT

ROAD NO. COUNTY PROJECT DESIGN NO.


HILLSBOROUGH 21-C-00022

GENERAL NOTES

SHEET NO.

T-3

nolas Russin 2/6/2023 4:00:34 PM

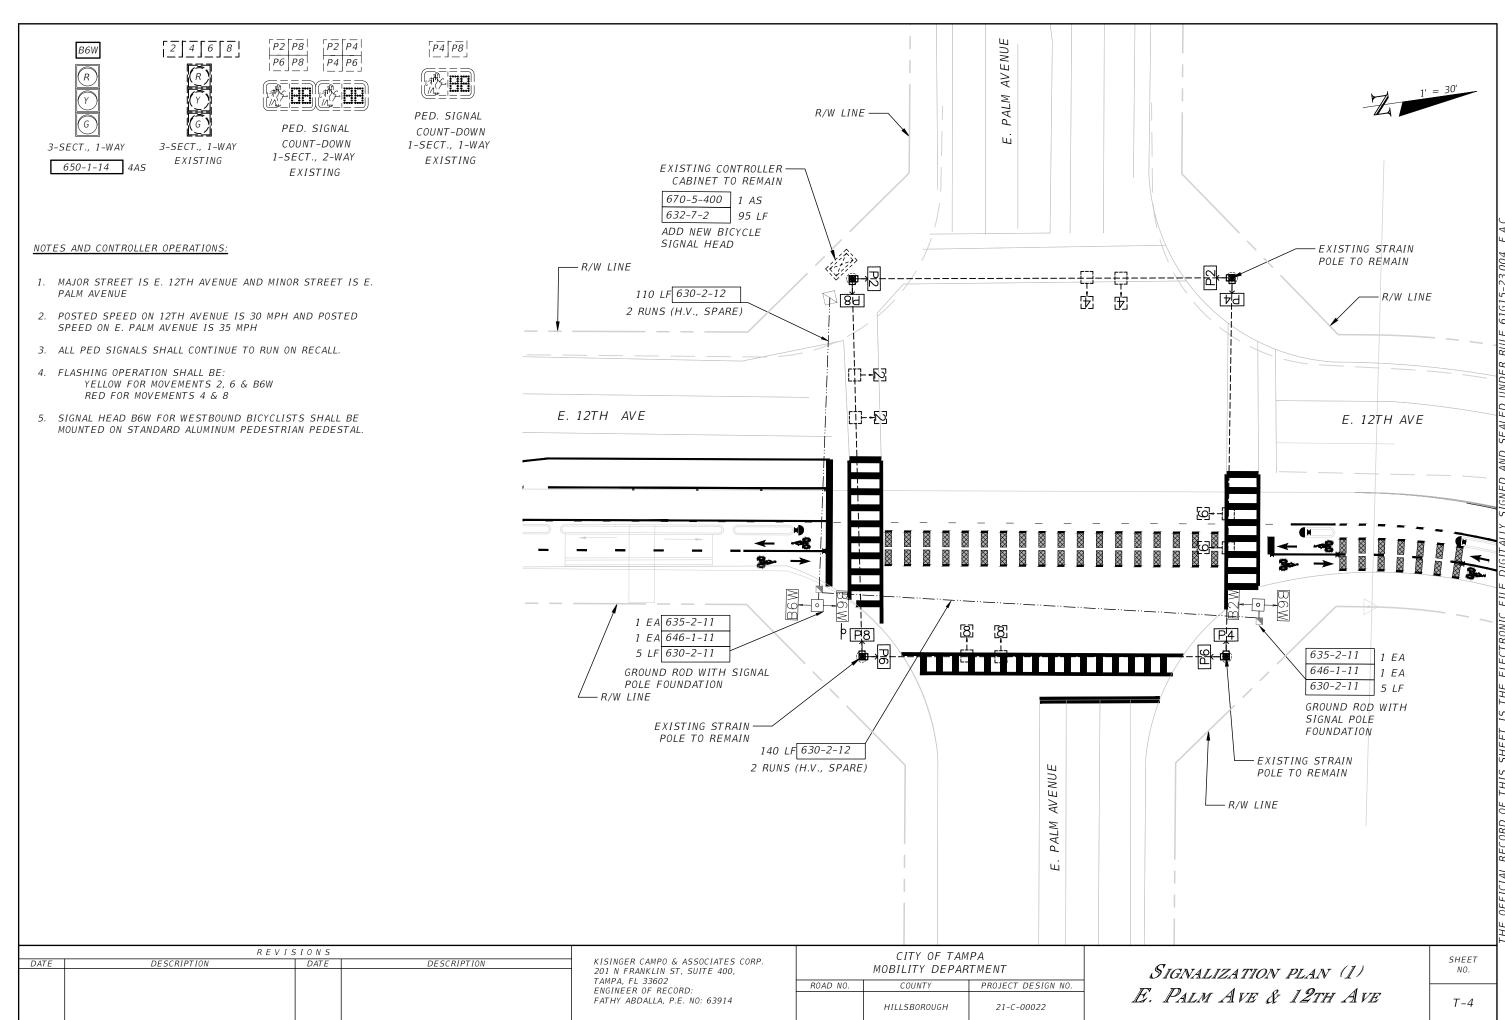

COMPONENTS OF CONTRACT PLANS SET ROADWAY PLANS SIGNING AND PAVEMENT MARKING PLANS SIGNAL PLANS LANDSCAPE PLANS

INDEX OF ROADWAY PLANS

SHEET NO.	SHEET DESCRIPTION
1	KEY SHEET
2	SIGNATURE SHEET
3	SUMMARY OF PAY ITEMS
4-5	TYPICAL SECTIONS
6	SUMMARY OF DRAINAGE STRUCTURES
7	GENERAL NOTES
8	CURVE DATA TABLE & BENCHMARK TABLE
9	PROJECT LAYOUT
10-12	ROADWAY PLANS
13	DRAINAGE DETAILS
14-16	SPECIAL DETAILS
17-18	INTERSECTION DETAILS
19-20	DRAINAGE STRUCTURES
21	EROSION CONTROL PLAN
22-23	STORMWATER POLLUTION PREVENTION PLAN
24-25	TRAFFIC CONTROL PLAN
26-28	UTILITY ADJUSTMENT SHEETS
SQ1 - SQ10	SUMMARY OF QUANTITIES SHEETS


CITY OF TAMPA MOBILITY DEPARTMENT

CONTRACT PLANS

FINANCIAL PROJECT ID 439476-4-58-01 FINANCIAL PROJECT ID 439476-4-58-02 (FEDERAL FUNDS)


E/W GREEN SPINE CYCLE TRACK -PH. 3C FROM 13TH AVE. TO 21ST AVE.

TO NORTH TAMPA

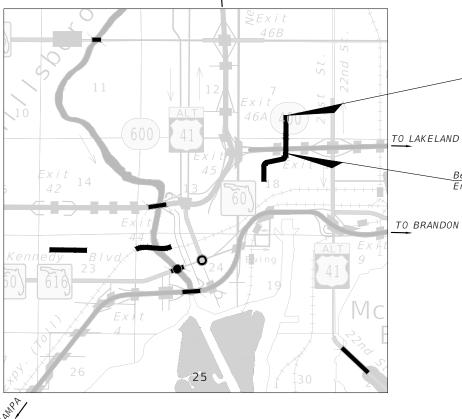

TO CLEARWATER

THIS PROJECT TO BE LET TO CONTRACT WITH FINANCIAL PROJECT ID(S): 439476-3-58-01

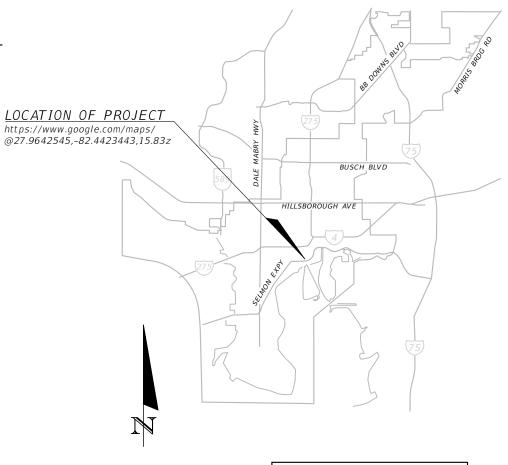

Ending of Project Ending of Phase 3C STA. 256+85.00

FINAL SUBMITTAL FEBRUARY 2023

Beginning of Phase 3C STA. 234+39.71 Ending of Phase 3B

TO BRANDON

ENGINEER OF RECORD:

FATHY ABDALLA, P.E. P.E. NO.: 63914 KISINGER CAMPO & ASSOCIATES CORP. 201 N FRANKLIN STREET, SUITE 400 TAMPA, FL, 33602 (813) 871-5331 CONTRACT NO.: 21-C-00022 VENDOR NO.: 59-1677145


CITY OF TAMPA PROJECT MANAGER:

NINA S. MABILLEAU E.I.

CONSTRUCTION	FISCAL	SHEET
CONTRACT NO.	YEAR	NO.
21-C-00022	23	1

GOVERNING DESIGN STANDARD: FLORIDA DEPARTMENT OF TRANSPORTATION, FY2023-24 DESIGN STANDARDS EBOOK (DSEB) AND APPLICABLE DESIGN STANDARDS REVISIONS (DSRS) AT THE FOLLOWING WEBSITE: https://www.fdot.gov/design/standardplans

GOVERNING STANDARD SPECIFICATIONS: CITY OF TAMPA AND FLORIDA DEPARTMENT OF TRANSPORTATION, FY2023-24 DIVISION II AT THE FOLLOWING WEBSITE: http://www.fdot.gov/programmanagement/Implemented/SpecBooks

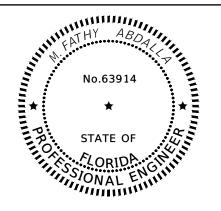

THIS ITEM HAS BEEN DIGITALLY SIGNED AND SEALED BY

M. Fathy 2023.08.04 Abdalla 11:19:36 -04'00'

ON THE DATE ADJACENT TO THE SEAL


PRINTED COPIES OF THIS DOCUMENT ARE NOT CONSIDERED SIGNED AND SEALED AND THE SIGNATURE MUST BE VERIFIED ON ANY ELECTRONIC COPIES.

KISINGER CAMPO & ASSOCIATES CORP. 201 N FRANKLIN ST, SUITE 400, TAMPA, FL 33602 FLORIDA CERTIFICATE OF AUTHORIZATION NO. 02317 FATHY ABDALLA, P.E. NO. 63914

THE ABOVE NAMED PROFESSIONAL ENGINEER SHALL BE RESPONSIBLE FOR THE FOLLOWING SHEETS IN ACCORDANCE WITH RULE 61G15-23.004, F.A.C.

PLAN INDEX

SHEET NO.	SHEET DESCRIPTION
1	KEY SHEET
2	SIGNATURE SHEET
3	SUMMARY OF PAY ITEMS
4-5	TYPICAL SECTIONS
7	GENERAL NOTES
8	CURVE DATA TABLE & BENCHMARK TABLE
9	PROJECT LAYOUT
10-12	ROADWAY PLANS
14-16	SPECIAL DETAILS
17-18	INTERSECTION DETAILS
24-25	TRAFFIC CONTROL PLAN
26-28	UTILITY ADJUSTMENT SHEETS
SQ1 -SQ10	SUMMARY OF QUANTITIES SHEETS

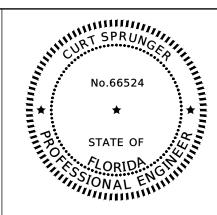

THIS ITEM HAS BEEN DIGITALLY SIGNED AND SEALED BY

Curtis Sprunger of Checurs Sprunger of Checurs

ON THE DATE ADJACENT TO THE SEAL

PRINTED COPIES OF THIS DOCUMENT ARE NOT CONSIDERED SIGNED AND SEALED AND THE SIGNATURE MUST BE VERIFIED ON ANY ELECTRONIC COPIES.

KISINGER CAMPO & ASSOCIATES CORP. 201 N FRANKLIN ST, SUITE 400, TAMPA, FL 33602 FLORIDA CERTIFICATE OF AUTHORIZATION NO. 02317 CURT SPRUNGER, P.E. NO. 66524

THE ABOVE NAMED PROFESSIONAL ENGINEER SHALL BE RESPONSIBLE FOR THE FOLLOWING SHEETS IN ACCORDANCE WITH RULE 61G15-23.004, F.A.C.

PLAN INDEX

SHEET NO.	SHEET DESCRIPTION
2	SIGNATURE SHEET
6	SUMMARY OF DRAINAGE STRUCTURES
13	DRAINAGE DETAILS
19-20	DRAINAGE STRUCTURES
21	EROSION CONTROL PLAN
22-23	STORMWATER POLLUTION PREVENTION PLAN

	R E V I S I O N S										
DATE	DESCRIPTION	DATE	DESCRIPTION								

KISINGER CAMPO & ASSOCIATES CORP. 201 N FRANKLIN ST, SUITE 400, TAMPA, FL 33602 ENGINEER OF RECORD: FATHY ABDALLA, P.E. NO: 63914 CITY OF TAMPA
MOBILITY DEPARTMENT

ROAD NO. COUNTY PROJECT DESIGN NO.

HILLSBOROUGH 21-C-00022

SIGNATURE SHEET

SHEET NO.

PHASE 3C - 15TH FROM 13TH AVE TO 21ST AVE

FLORIDA DEPARTMENT OF TRANSPORTATION SUMMARY OF PAY ITEMS						FLORIDA DEPARTMENT OF TRANSPORTATION								
						SUMMARY OF PAY ITEMS								
LEAD PROJECT:	439476-1-58-01 DISTRICT: D7	COUNTY	SECTION:			LEAD PROJECT:	439476-1-58-01 DISTRICT: D7	COUNTY	SECTION:					
PROJECT:	43947615801 COUNTY: HILLSBOROUGH	COUNTY :	HILLSBOROUGH			PROJECT:	43947615801 COUNTY: HILLSBOROUGH	COUNTY	: HILLSBOROUGH					
PAY ITEM NO.	ITEM DESCRIPTION	UNIT		QUANT ITY		PAY ITEM NO.	ITEM DESCRIPTION	UNIT	QUANTITY					
TAI TIEM NO.	THEM DESCRIPTION	ONTT	439476-4-58-01	439476-4-58-02	Total	TAI TIEM NO.		ONTT	439476-4-58-01	439476-4-58-02	Total			
101 1	MOBILIZATION	LS	0.15		0.15	0646 1 40	ALUMINUM SIGNALS POLE, RELOCATE	EA	4					
102 1	MAINTENANCE OF TRAFFIC	LS	1.00		1.00	0646 1 60	ALUMINUM SIGNALS POLE, REMOVE	EA	1					
104 10 3	SEDIMENT BARRIER	LF	175		175	0650 1 14	VEHICULAR TRAFFIC SIGNAL, FURNISH & INSTALL ALUMINUM, 3 SECTION, 1 WAY	AS	4					
104 18	INLET PROTECTION SYSTEM	EA	13		13	0654 2 22	RECTANGULAR RAPID FLASHING BEACON, FURNISH & INSTALL- SOLAR POWERED, COMPLETE SIGN ASSEMBLY- BACK TO BACK	AS	2					
110 1 1	CLEARING AND GRUBBING	LS	1		1	0653 1 11	PEDESTRIAN SIGNAL, FURNISH & INSTALL LED COUNTDOWN, 1 WAY	AS	2					
110 4 10	REMOVAL OF EXISTING CONC	SY	985		985	0670 5400	TRAFFIC CONTROLLER ASSEMBLY, MODIFY	AS	2					
120 6	EMBANKMENT	CY	419		419	0700 1 11	SINGLE POST SIGN, F&I GROUND MOUNT, UP TO 12 SF	AS	10		1			
327 70 6	MILLING EXIST ASPH PAVT, 1.5" AVG DEPTH	SY	9,288		9,288	0700 1 12	SINGLE POST SIGN, F&I GROUND MOUNT, 12-20 SF	AS	1					
337 7 83	ASPHALT CONCRETE FRICTION COURSE, TRAFFIC C, FC-12.5, PG 76-22	TN	768		768	0700 1 18	SINGLE POST SIGN, F&I GROUND MOUNT, IN-STREET FLEXIBLE POST SIGN	AS	8					
425 2 043	MANHOLE TYPE 7, PARTIAL	EA	3		3	0700 1 50	SINGLE POST SIGN, RELOCATE	AS	6					
EX-425 5	MANHOLE, ADJUST	EA		8	8	0700 1 60	SINGLE POST SIGN, REMOVE	AS	8					
EX-435 100 2	INLET SPECIAL DRAINAGE GRATE	LF		181	181	0705 11 3	DELINEATOR, FLEXIBLE HIGH VISABILITY MEDIAN	EA	15		1			
430 175 115	PIPE CULVERT, OPTIONAL MATERIAL, ROUND, 15"S/CD	LF	102		102	0710 90	PAINTED PAVEMENT MARKINGS, FINAL SURFACE	LS	1					
430 175 118	PIPE CULVERT,OPTIONAL MATERIAL,ROUND, 18"S/CD	LF	63		63	0711 11123	THERMOPLASTIC, STANDARD, WHITE, SOLID, 12" FOR CROSSWALK AND ROUNDABOUT	LF	752		75			
520 1 10	CONCRETE CURB & GUTTER, TYPE F	LF	325		325	0711 11124	THERMOPLASTIC, STANDARD, WHITE, SOLID, 18" FOR DIAGONALS AND CHEVRONS	LF	307		30			
520 2 4	CONCRETE CURB, TYPE D	LF	2,410		2,410	0711 11125	THERMOPLASTIC, STANDARD, WHITE, SOLID, 24" FOR STOP LINE AND CROSSWALK	LF	294		29			
520 7 1	GRANITE CURB, FURNISH & INSTALL	LF	193		193	0711 11141	THERMOPLASTIC, STANDARD, WHITE, 2-4 DOTTED GUIDELINE/ 6-10 GAP EXTENSION, 6"	GM	0.255		0.25			
520 7 2	GRANITE CURB, RESET	LF	235		235	0711 11160	THERMOPLASTIC, STANDARD, WHITE, MESSAGE OR SYMBOL	EA	3					
522 2	CONCRETE SIDEWALK AND DRIVEWAYS, 4"	SY	340		340	0711 11170	THERMOPLASTIC, STANDARD, WHITE, ARROW	EA	21		2			
522 3	CONCRETE SIDEWALK AND DRIVEWAYS, 6"	SY	1,696		1,696	0711 11224	THERMOPLASTIC, STANDARD, YELLOW, SOLID, 18" FOR DIAGONAL OR CHEVRON	LF	468		46			
EX-526 1A	RED BRICK PAVERS, FURNISH AND INSTALL	SY		115		0711 14125	THERMOPLASTIC, PREFORMED, WHITE, SOLID, 24" FOR CROSSWALK	LF	670		67			
EX-526 1B	RED BRICK PAVERS, INSTALL	SY		115		0711 14160	THERMOPLASTIC, PREFORMED, WHITE, MESSAGE	EA	17		:			
EX-527 2	DETECTABLE WARNINGS	SF		357		0711 16101	THERMOPLASTIC, STANDARD-OTHER SURFACES, WHITE, SOLID, 6"	GM	0.662		0.66			
570 1 2	PERFORMANCE TURF, SOD	SY	432		432	0711 16102	THERMOPLASTIC, STANDARD-OTHER SURFACES, WHITE, SOLID, 8"	GM	0.115		0.11			
COT - 002	CITY INLET TYPE 2	EA	2		2	0711 16131	THERMOPLASTIC, OTHER SURFACES, WHITE, SKIP, 6",10-30 SKIP OR 3-9 LANE DROP	GM	0.343		0.34			
COT - 003	CITY INLET TYPE 3	EA	3		3	0711 16201	THERMOPLASTIC, STANDARD-OTHER SURFACES, YELLOW, SOLID, 6"	GM	0.194		0.19			
EX-9910	ADJUST VALVE BOX (HEIGHT)	EA		15	15	0711 16202	THERMOPLASTIC, STANDARD-OTHER SURFACES, YELLOW, SOLID, 8"	GM	0.003		0.00			
PAY ITEM NO.	ITEM DESCRIPTION	UNIT		QUANT ITY		0711 16231	THERMOPLASTIC, STANDARD-OTHER SURFACES, YELLOW, SKIP, 6"	GM	0.122		0.12			
			439476-4-58-01	439476 - 4 - 58 - 02	Total	PAY ITEM NO.	ITEM DESCRIPTION	UNIT		QUANT I TY				
0523 1 3	PATTERNED PAVEMENT, INCLUDING GREEN BIKE LANE	SY	128		128			0,117	439476-4-58-01	439476 - 4 - 58 - 02	Total			
0630 2 11	CONDUIT, FURNISH & INSTALL, OPEN TRENCH	LF	150		150	EX-0520 2 4	CONCRETE CURB, TYPE D	LF		160	16			
0630 2 12	CONDUIT, FURNISH & INSTALL, DIRECTIONAL BORE	LF	191		191	EX-0580 1 1	LANDSCAPE COMPLETE - SMALL PLANTS	LS		1				
0632 7 2	SIGNAL CABLE- REPAIR/REPLACE/OTHER, FURNISH & INSTALL	LF	900		900	EX-0580 1 2	LANDSCAPE COMPLETE - LARGE PLANTS	LS		1				
0635 2 11	PULL & SPLICE BOX, F&I, 13" x 24" COVER SIZE	EA	7		7	EX - COT - 101	PAVERS, ARCHITECTURAL, SIDEWALK	SY		87				
0646 1 11	ALUMINUM SIGNALS POLE, PEDESTAL	EA	4		4	EX - COT - 103	SPECIAL FURNISHINGS	LS		1				
							PRE-EMERGENT HERBICIDE	SY		142	1			


R E V I S I O N S							
DATE	DESCRIPTION	DATE	DESCRIPTION				


KISINGER CAMPO & ASSOCIATES CORP. 201 N FRANKLIN ST, SUITE 400, TAMPA, FL 33602 ENGINEER OF RECORD: FATHY ABDALLA, P.E. NO: 63914

CITY OF TAMPA MOBILITY DEPARTMENT ROAD NO. COUNTY PROJECT DESIGN NO. HILLSB0R0UGH 21-C-00022

SUMMARY OF PAY ITEMS - (1)

SHEET NO.

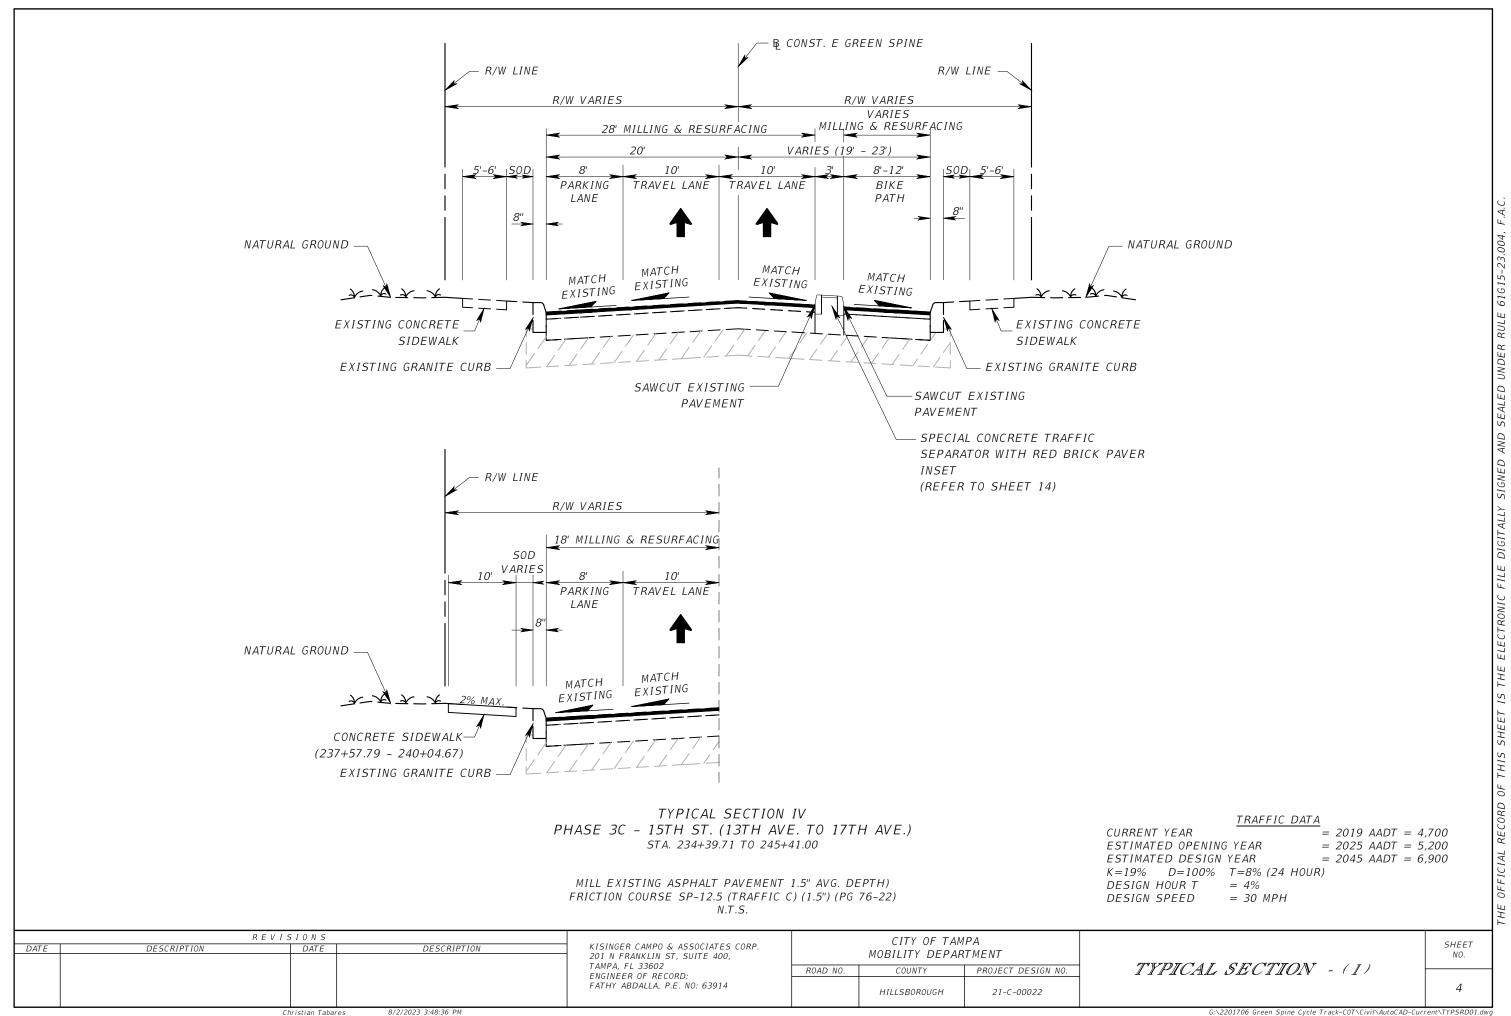

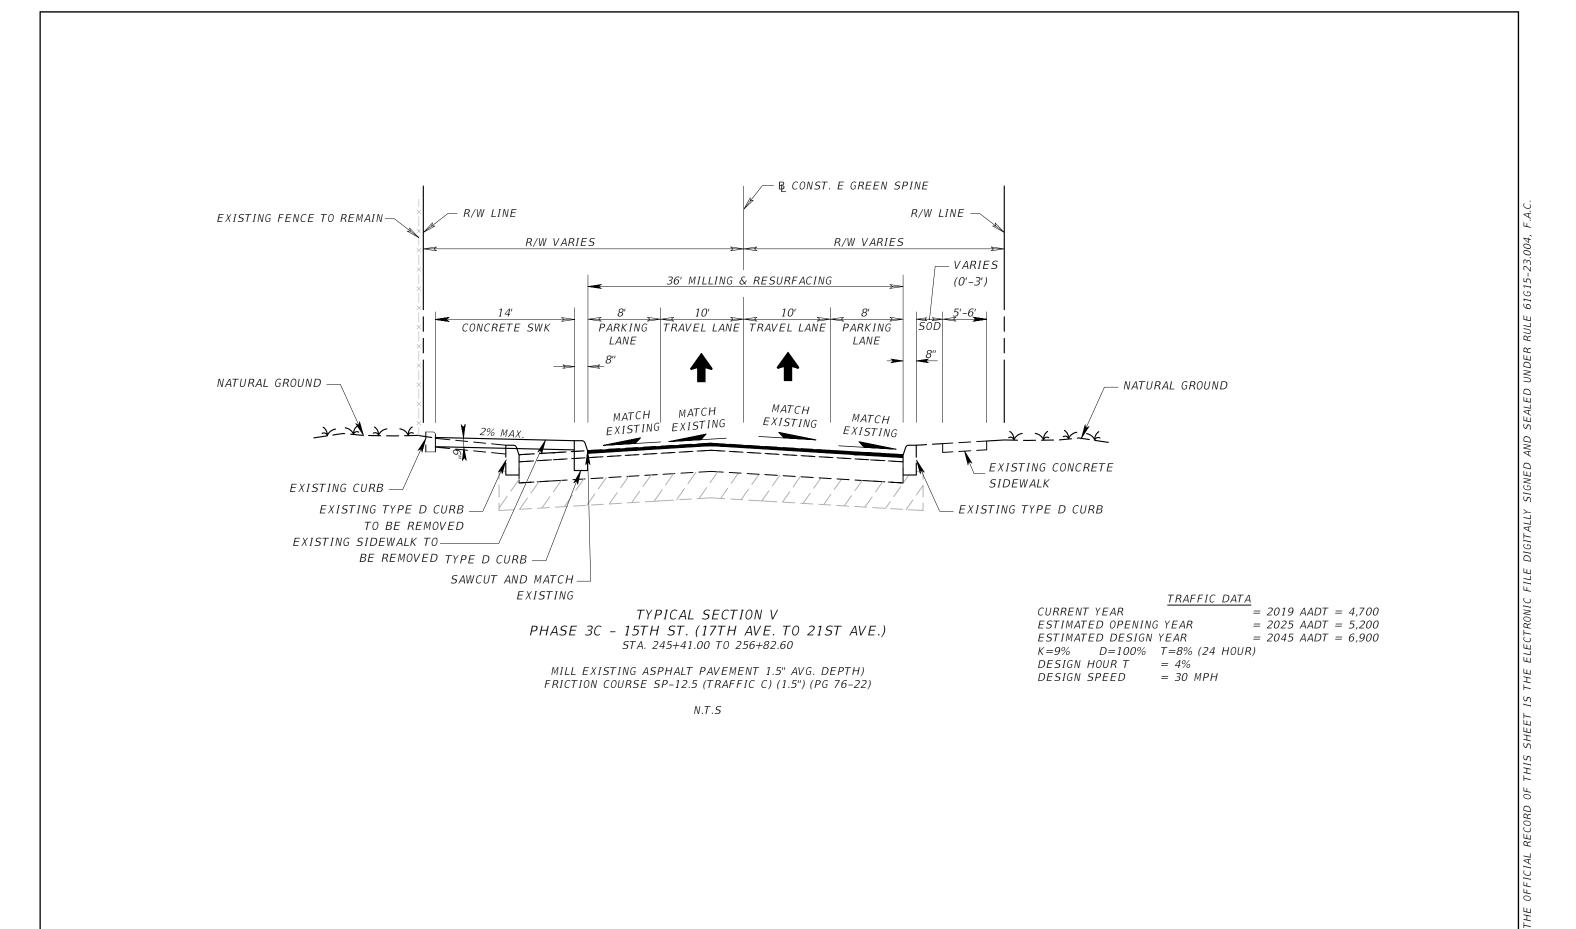

R E V I S I O N S			KISINGER CAMPO & ASSOCIATES CORP.	CITY OF TAMPA					
DATE	DESCRIPTION	DATE	DESCRIPTION			MOBILITY DEPAI	RTMENT		
				201 N FRANKLIN ST, SUITE 400, TAMPA, FL 33602	MODILITY DELANTMENT				
					I AMPA, FL 33602 ENGINEER OF RECORD:	ROAD NO.	COUNTY	PROJECT DESIGN NO.	TYPICAL SECTION - (
				FATHY ABDALLA, P.E. NO: 63914		HILLSBOROUGH	21-C-00022		

Christian Tabares

8/2/2023 3:48:36 PM

(2)

SHEET

G:\2201706 Green Spine Cycle Track-COT\Civil\AutoCAD-Current\TYPSRD01.dwg

QUANTITY	STR. NO.	STATION	STATION	STATION	STATION	SIDE	DESCRIPTION	BARRELS		DRAIN ROSS AIN	CURB	INLET	MANHOLE	REMARKS
						ROUND		COT COT TYPE 2 TYPE 3		TYPE 7				
						15"	18"	<10'	<10	PART I AL				
Р	S-105A	243+90.00	LT	INLET, PIPE	1		46		1					
F														
Р	S - 105B	243+41.30	RT	INLET, PIPE	1		17		1					
F														
Р	S - 105C	243+41.13	LT	PARTIAL MH						1				
F														
Р	S-105D	243+40.33	RT	PARTIAL MH						1				
F														
Р	S - 106	245+50.00	LT	INLET, PIPE	1	6			1					
F														
Р	S - 107	245+58.38	LT	PARTIAL MH						1				
F														
Р	S - 108	246+12.00	LT	INLET, PIPE	1	50		1						
F														
Р	5-109	246+80.00	RT	INLET, PIPE	1	46		1						
F														
	SURT	ΤΟΤ ΔΙ S	.	PLAN QUANTITY:		102	63	2	3	3				
	SUBTOTALS			FINAL QUANTITY:										

	REVIS		
DATE	DESCRIPTION	DATE	DESCRIPTION

KISINGER CAMPO & ASSOCIATES CORP. 201 N FRANKLIN ST, SUITE 400, TAMPA, FL 33602 ENGINEER OF RECORD: CURT SPRUNGER, P.E. NO: 66524 CITY OF TAMPA
MOBILITY DEPARTMENT

ROAD NO. COUNTY PROJECT DESIGN NO.

HILLSBOROUGH 21-C-00022

SUMMARY OF DRAINAGE STRUCTURES SHEET NO.

Christian Tabares 8/2/2023 3:48:47 PM

GENERAL NOTES

- 1. BENCHMARK ELEVATIONS SHOWN ON THE PLANS ARE NORTH AMERICAN VERTICAL DATUM OF 1988 (NAVD 88).
- 2. EXISTING DRAINAGE STRUCTURES WITHIN CONSTRUCTION LIMITS SHOULD REMAIN UNLESS OTHERWISE NOTED.
- 3. IF ANY PUBLIC LAND CORNER WITHIN THE LIMITS OF CONSTRUCTION IS IN DANGER OF BEING DESTROYED AND HAS NOT BEEN PROPERLY REFERENCED, IMMEDIATELY NOTIFY THE ENGINEER IN CONJUNCTION WITH THE CITY SURVEYOR, CLARENCE "LUCKY" WADE (813) 635-3430.
- 4. PROPOSED CONCRETE SIDEWALK TO BE 4" CONCRETE. SIDEWALK CROSSING DRIVEWAYS TO BE 6" CONCRETE.
- 5. AREAS DISTURBED OUTSIDE THE PAVEMENT SHALL BE RESTORED TO THEIR ORIGINAL NEW CONDITION. GRASSED AREAS DISTURBED SHALL BE RESTORED WITH PERFORMANCE SOD.
- 6. MAINTAIN ONE COMPLETE SET OF CONTRACT DOCUMENTS AT THE SITE, THESE DOCUMENTS SHALL INCLUDE BUT NOT BE LIMITED TO CONTRACT DOCUMENTS AND SPECIFICATIONS, AND ANY TECHNICAL OR REFERENCE DOCUMENTS THAT MAY BE RELATIVE. AS THE WORK PROGRESSES RECORD ON ONE SET OF REPRODUCIBLE DRAWINGS ALL CHANGES AND DEVIATIONS FROM THE ORIGINAL PLANS. RECORD THE EXACT LOCATION OF ALL CHANGES IN VERTICAL AND HORIZONTAL ALIGNMENT BY OFFSETS AND TIES TO PERMANENT IMPROVEMENTS SUCH AS STRUCTURES AND CURBS. ALL DEVIATIONS FROM THESE PLANS SHALL BE APPROVED BY THE ENGINEER.
- 7. ALL WORK AND MATERIALS WHICH DO NOT CONFORM TO THE CITY'S SPECIFICATIONS ARE SUBJECT TO REMOVAL AND REPLACEMENT WITH APPROVED MATERIALS FOR NO ADDITIONAL PAYMENT.
- 8. ANY WORK PERFORMED WITHOUT THE KNOWLEDGE OF THE CITY IS SUBJECT TO RE-EXCAVATION, REMOVAL AND REPLACEMENT OF SAME TO BE DONE FOR NO ADDITIONAL PAYMENT.
- 9. PROVIDE SUFFICIENT PERSONNEL AND EQUIPMENT ON THE JOB AT ALL TIMES DURING CONSTRUCTION TO SATISFY THE SPECIFICATIONS AND COMPLETE WORK.
- 10. VERIFY ALL QUANTITIES SHOWN ON THE PLANS. IF ANY DISCREPANCIES IN QUANTITIES ARE FOUND, NOTIFY THE PROJECT ENGINEER AND THE CITY.
- 11. ALL REGULATORY AND PERMITTING AGENCIES' REQUIREMENTS SHALL BE COMPLIED WITH.
- 12. APPROPRIATE TURBIDITY CONTROL DEVICES (E.G. SILT FENCES, SYNTHETIC BALES) WILL BE UTILIZED DURING ALL PHASES OF INSTALLATION AND GRADING. CONTRACTOR IS RESPONSIBLE FOR SUBMITTING THE NOTICE OF INTENT AND NOTICE OF TERMINATION TO THE EPA IN COMPLIANCE WITH THE CITY NPDES PERMIT. CONTRACTOR IS RESPONSIBLE FOR DEVELOPING AND MAINTAINING AN EFFECTIVE STORM WATER POLLUTION PREVENTION PLAN.
- 13. LOCATIONS, ELEVATIONS, AND DIMENSIONS OF EXISTING UTILITIES, STRUCTURES AND OTHER FEATURES ARE SHOWN ACCORDING TO THE BEST INFORMATION AVAILABLE AT THE TIME OF PREPARATION OF THESE PLANS, BUT DO NOT PURPORT TO BE ABSOLUTELY CORRECT. PRIOR TO CONSTRUCTION, THE CONTRACTOR SHOULD VERIFY AND SHOULD BE FULLY RESPONSIBLE FOR ANY AND ALL DAMAGES WHICH MIGHT BE OCCASIONED BY HIS FAILURE TO EXACTLY LOCATE AND PRESERVE ANY AND ALL EXISTING UTILITIES, STRUCTURES, AND OTHER FEATURES AFFECTING HIS WORK. ANYTHING NOT SHOWN ON THESE DRAWINGS SHOULD BE BROUGHT TO THE ATTENTION OF THE ENGINEER AND SHOULD NOT CONSTITUTE AN EXTRA, UNLESS APPROVED BY THE ENGINEER.
- 14. CONTACT THE ENGINEER AND CITY IMMEDIATELY CONCERNING ANY CONFLICTS WITH THE CITY'S UTILITIES/STRUCTURES ARISING DURING CONSTRUCTION OF ANY FACILITIES SHOWN ON THESE DRAWINGS.
- 15. VERIFY ALL UTILITIES AND PROVIDE AT LEAST 48 HOURS NOTICE TO THE INDIVIDUAL UTILITY AGENCY OWNERS AND CITY PRIOR TO CONSTRUCTION.
- 16. REPLACE ALL PAVEMENT, CURBS, DRIVEWAYS, SIDEWALKS, FENCES, ETC., WITH THE SAME TYPE OF MATERIAL THAT WAS REMOVED DURING CONSTRUCTION OR AS DIRECTED BY THE ENGINEER. THE CONTRACTOR SHOULD RESTORE ALL AREAS AFFECTED BY THE CONSTRUCTION TO ITS ORIGINAL CONDITION, OR BETTER.
- 17. THE INFORMATION PROVIDED IN THESE PLANS IS SOLELY TO ASSIST THE CONTRACTOR IN ASSESSING THE NATURE AND EXTENT OF THE CONDITIONS WHICH MAY BE ENCOUNTERED DURING THE COURSE OF WORK. ALL CONTRACTORS ARE DIRECTED, PRIOR TO BIDDING, TO CONDUCT WHATEVER INVESTIGATIONS THEY MAY DEEM NECESSARY TO ARRIVE AT THEIR OWN CONCLUSION REGARDING THE ACTUAL CONDITIONS THAT WILL BE ENCOUNTERED, AND UPON WHICH THEIR BIDS WILL BE BASED.
- 18. ALL FRAMES, COVERS, VALVE BOXES, METER BOXES, FIRE HYDRANTS AND MANHOLES SHALL BE ADJUSTED TO FINISHED GRADE UPON COMPLETION OF PAVING OR RELATED CONSTRUCTION. ALL VALVE PADS SHALL BE POURED IN PLACE. NO PRE-FORMED VALVE PADS ALLOWED.
- 19. EXISTING UTILITIES NOT BEING RELOCATED, ARE TO REMAIN IN SERVICE.

Christian Tahares

- 20. CONTRACTOR SHOULD MAINTAIN ALL VEHICLE DETECTION THROUGHOUT THE ENTIRETY OF THE PROJECT AND UNTIL THE REPLACED DETECTION DEVICES HAVE PASSED INSPECTION
- 21. THIS PROJECT IS TO BE CONSTRUCTED COMPLETELY WITHIN THE TRANSPORTATION RIGHT-OF-WAYS. THE CONTRACTOR SHOULD NOT ENCROACH OR UTILIZE ANY OF THE CUSCADEN PARK PROPERTY ON THE 2900 BLOCK OF N. 15TH STREET FOR CONSTRUCTION, STAGING, STOCKPILING OR ANY OTHER PURPOSE.

8/2/2023 3:48:55 PM

22. HISTORIC GRANITE CURBS WILL REMAIN IN PLACE THROUGHOUT THE PROJECT AND IN LOCATIONS WHERE CURB WORK IS ANTICIPATED, GRANITE CURBS WILL BE RE-INSTALLED AS NECESSARY.

CONSTRUCTION NOTES

- 1. DO NOT EXCAVATE ANY AREAS THAT CANNOT BE SAFELY REOPENED TO TRAFFIC WITHIN THE SAME WORK PERIOD.
- 2. USE APPROPRIATE MEASURES TO PREVENT EROSION AND TRANSPORT OF SEDIMENT MATERIAL TO INLETS, SURFACE DRAINS, LAKES, AND WETLANDS. THE CONTRACTOR SHOULD USE INLET PROTECTION SYSTEMS AND SEDIMENT BARRIERS OR OTHER APPROPRIATE MEASURES TO PREVENT ADVERSE IMPACTS TO EXISTING SURFACE WATER QUALITY.
- 3. CHECK ALL EROSION AND SILTATION CONTROL DEVICES AFTER EACH RAINFALL AND REPAIR OR REPLACE THEM AS NEEDED..
- 4. CHECK ALL FUGITIVE DUST GENERATED BY CONSTRUCTION ACTIVITIES IN THE PROJECT BY WATERING OR OTHER METHODS AS REQUIRED.
- 5. ALL UNSUITABLE MATERIAL ENCOUNTERED DURING CONSTRUCTION, AS DETERMINED BY THE CITY CONSTRUCTION INSPECTOR, SHALL BE REMOVED AND REPLACED WITH CLEAN FILL.

CONTAMINATION NOTES

BASED ON THE FLORIDA DEPARTMENT OF ENVIRONMENTAL PROTECTION'S CONTAMINATION LOCATOR MAP, THE FOLLOWING CONTAMINATED SITE MAY POTENTIALLY ADVERSELY IMPACT THE PROJECT:

1. FORMER SOUTHERN HYDRAULIC SERVICES LOCATED AT 1502 E. COLUMBUS DR - FOLIO NO. 187517.0000 (FACILITY ID #9100548 - ACTIVE PETROLEUM CLEANUP). NOTE THAT STRUCTURES S-105B, S105-D AND THEIR ASSOCIATED PIPES ARE LOCATED IN THIS AREA.

IF THE REVIEW OF THE WORK IN THIS AREAS IS DETERMINED TO HAVE AN IMPACT ON THE PROJECT BY THE ENGINEER, IMPACTED CONTAMINATED SOIL AND GROUNDWATER SHALL BE REMOVED FOR DISPOSAL BY THE CONTRACTOR AND PAID USING A PERCENTAGE OF THE REMEDIATION LINE ITEM.

NOTE THAT STRUCTURE S-105B AND ITS ASSOCIATED PIPE IS LOCATED IN THE AREA

STORMWATER NOTES

- 1. PROPOSED SIDEWALK SHALL NOT IMPEDE HISTORICAL DRAINAGE FLOW PATTERNS.
- 2. SIGNED AND SEALED AS-BUILT DRAWINGS WITH SURVEYED ELEVATION DATA SHALL BE SUBMITTED TO THE CITY OF TAMPA STORMWATER ENGINEERING SECTION (ATTENTION BARBARA GRAVE).
- 3. ALL PROPOSED PIPE TO BE RCP CLASS II.

	CONSTRUCTION, STAGING, STOCKPILING	OR ANY O	THER PURPOSE.				
	REVI	SIONS			CITY OF TAMPA MOBILITY DEPARTMENT		
DATE	DESCRIPTION	DATE	DESCRIPTION	KISINGER CAMPO & ASSOCIATES CORP. 201 N FRANKLIN ST, SUITE 400,			
				TAMPA, FL 33602 ENGINEER OF RECORD:	ROAD NO. COUNTY PROJE	PROJECT DESIGN NO.	
				FATHY ABDALLA, P.E. NO: 63914		HILLSBOROUGH	21-C-00022

GENERAL NOTES - (1)

SHEET NO.

7

							CURVE	DATA TABLE							
NUMBER	PC STA.	PI STA.	PT STA.	Т	D	Δ	DIRECTION	L	R	PC NORTH.	PC EAST.	PI NORTH.	PI EAST.	PT NORTH.	PT EAST.
C9	207+86.17	208+22.34	208+58.37	36.17	012° 03' 44"	008° 42′ 33″	RT	72.202	475.000	1318249.3720	511954.3413	1318285.5417	511954.6148	1318321.2529	511960.3620
C10	208+86.89	209+16.71	209+46.38	29.81	016° 22′ 13″	009° 44′ 17″	LT	59.486	350.000	1318349.4144	511964.8942	1318378.8503	511969.6315	1318408.6633	511969.3216
C11	219+33.72	221+04.42	222+20.38	170.70	027° 17′ 01″	078° 12' 42"	RT	286.660	210.000	1319395.9873	511971.4420	1319566.6834	511972.1610	1319600.8525	512139.4038
C12	230+98.52	232+60.40	233+70.69	161.88	028° 38' 52"	077° 58′ 19″	LT	272.173	200.000	1319776.6329	512999.7736	1319809.0360	513158.3730	1319970.9059	513159.7320

	<u>BENCHMARKS</u>										
<u>Benchmark</u> <u>Name</u>	<u>St a.</u>	<u>Offset</u>	<u>Side</u>	<u>East</u>	<u>North</u>	<u>Elev.</u>	<u>Description</u>				
BM509	207+73.49	34.11	Rt.	511 988.352	1 318 236.436	21.73	Nail & Disc "City of Tampa TS&S Survey Control"				
BM510	211+04.51	47.98	Lt.	511 919.966	1 318 566.986	23.69	Nail & Disc "City of Tampa TS&S Survey Control"				
BM511	213+00.09	34.74	Rt.	512 003.516	1 318 762.216	25.33	Nail & Disc stamped "City of Tampa Trans. Div. Survey Control"				
BM512	215+97.17	47.94	Lt.	511 922.086	1 319 059.648	28.30	Nail & Disc "City of Tampa TS&S Survey Control"				
BM513	219+07.09	49.30	Lt.	511 922.027	1 319 369.571	33.79	Nail & Disc "City of Tampa TS&S Survey Control"				
BM514	221+07.43	46.50	Lt.	512 008.601	1 319 584.629	40.93	Nail & Disc "City of Tampa TS&S Survey Control"				
BM515	225+27.85	29.62	Rt.	512 446.581	1 319 633.383	38.65	Nail & Disc "City of Tampa TS&S Survey Control"				
BM516	229+89.90	28.38	Rt.	512 899.034	1 319 727.081	32.37	Nail & Disc "City of Tampa TS&S Survey Control"				
BM517	232+59.59	36.71	Rt.	513 159.798	1 319 846.062	32.89	Nail & Disc "City of Tampa TS&S Survey Control"				
BM518	234+66.58	25.10	Rt.	513 203.568	1 320 048.336	34.82	Nail & Disc "City of Tampa TS&S Survey Control"				
BM519	228+96.21	278.40	Lt.	512 745.832	1 320 008.898	35.10	Nail & Disc "City of Tampa TS&S Survey Control"				
BM581	237+50.20	26.72	Lt.	513 153.720	1 320 332.250	40.40	Mag Nail & Disc "City of Tampa TS&S Survey Control"				
BM582	240+48.59	26.68	Rt.	513 208.351	1 320 630.416	43.13	Mag Nail & Disc "City of Tampa TS&S Survey Control"				
BM583	243+55.58	23.33	Lt.	513 160.794	1 320 937.584	44.82	Mag Nail & Disc "City of Tampa TS&S Survey Control"				
BM584	245+80.86	24.41	Rt.	513 212.580	1 321 161.561	45.69	Mag Nail & Disc "City of Tampa TS&S Survey Control"				
BM585	245+91.77	20.49	Rt.	513 209.172	1 321 172.641	45.64	Mag Nail & Disc "City of Tampa TS&S Survey Control"				
BM586	249+16.62	28.20	Lt.	513 161.730	1 321 498.495	45.70	Mag Nail & Disc "City of Tampa TS&S Survey Control"				
BM587	252+36.96	19.66	Rt.	513 210.336	1 321 818.724	46.35	Mag Nail & Disc "City of Tampa TS&S Survey Control"				
BM588	256+19.06	370.27	Lt.	513 161.964	1 322 264.938	46.68	Mag Nail & Disc "City of Tampa TS&S Survey Control"				
BM589	256+83.02	29.87	Lt.	512 821.338	1 322 202.183	44.25	Mag Nail & Disc "City of Tampa TS&S Survey Control"				

	R E V	ISIONS	
DATE	DESCRIPTION	DATE	DESCRIPTION


KISINGER CAMPO & ASSOCIATES CORP. 201 N FRANKLIN ST, SUITE 400, TAMPA, FL 33602 ENGINEER OF RECORD: FATHY ABDALLA, P.E. NO: 63914 CITY OF TAMPA
MOBILITY DEPARTMENT


ROAD NO. COUNTY PROJECT DESIGN NO.


HILLSBOROUGH 21-C-00022


CURVE DATA TABLE & BENCHMARKS TABLE SHEET NO.


Christian Tabares 8/2/2023 3:49:06 PM

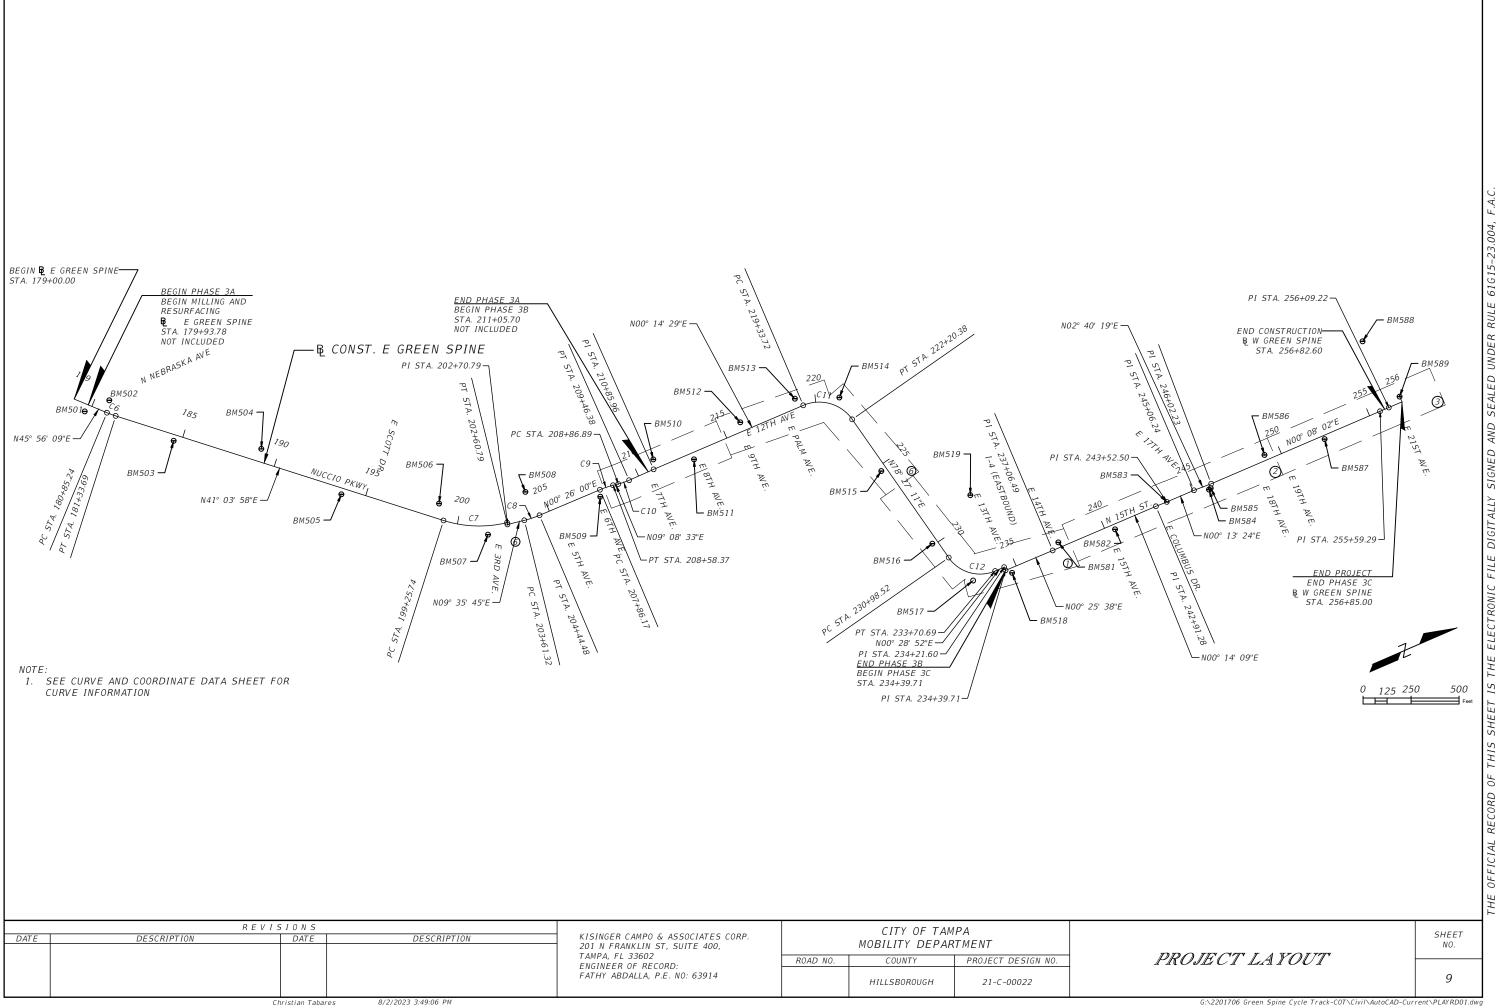


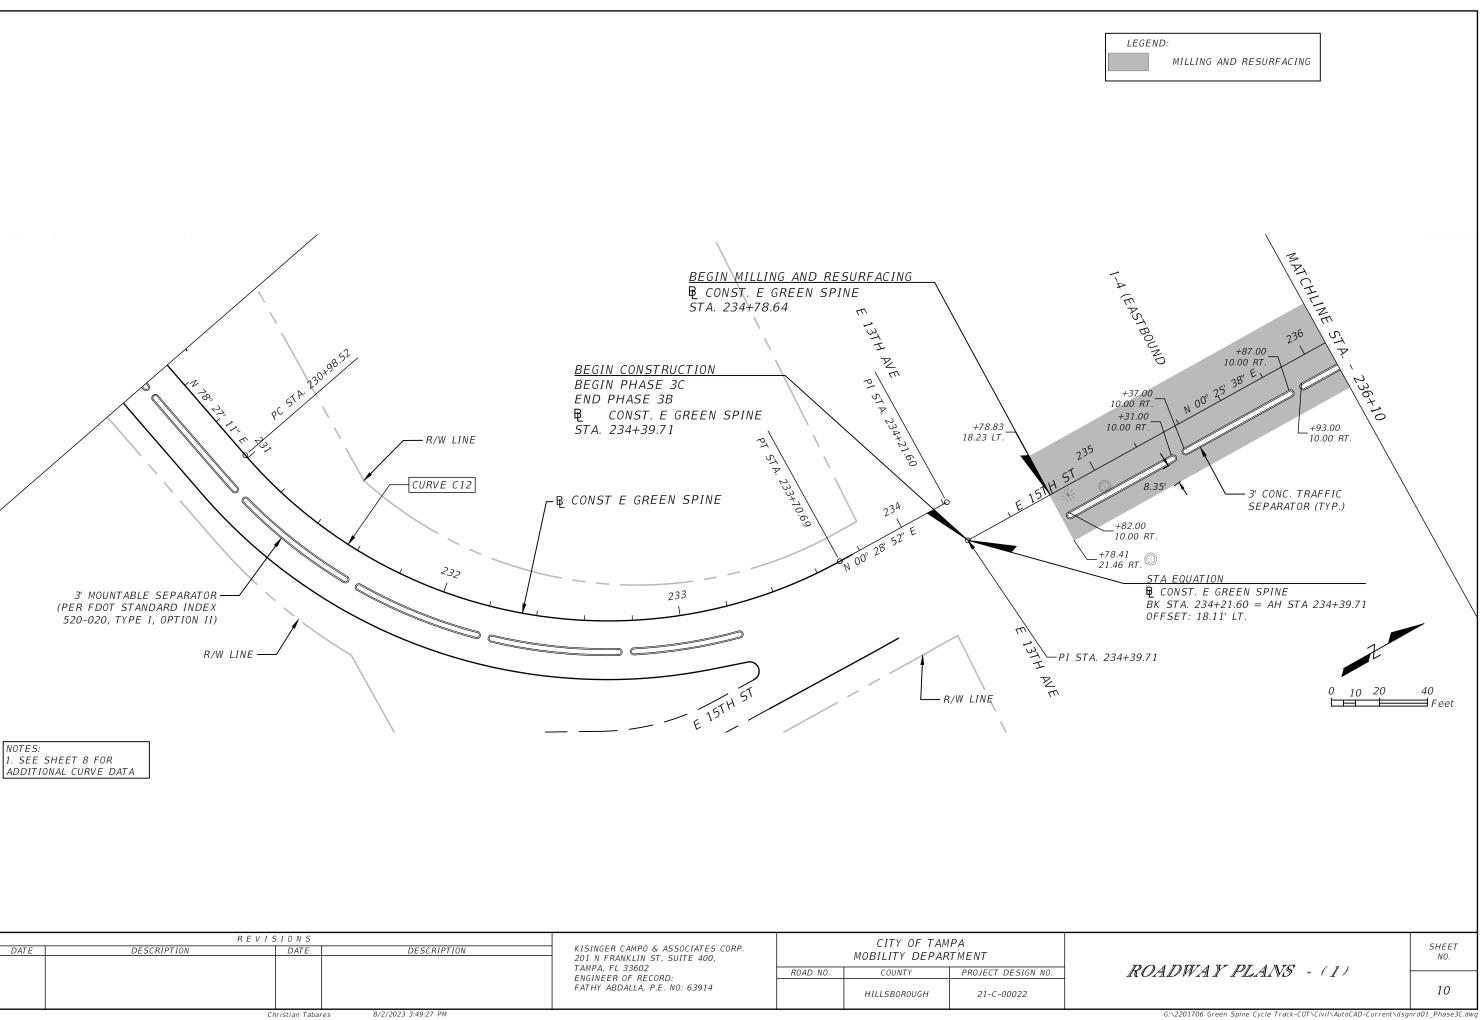

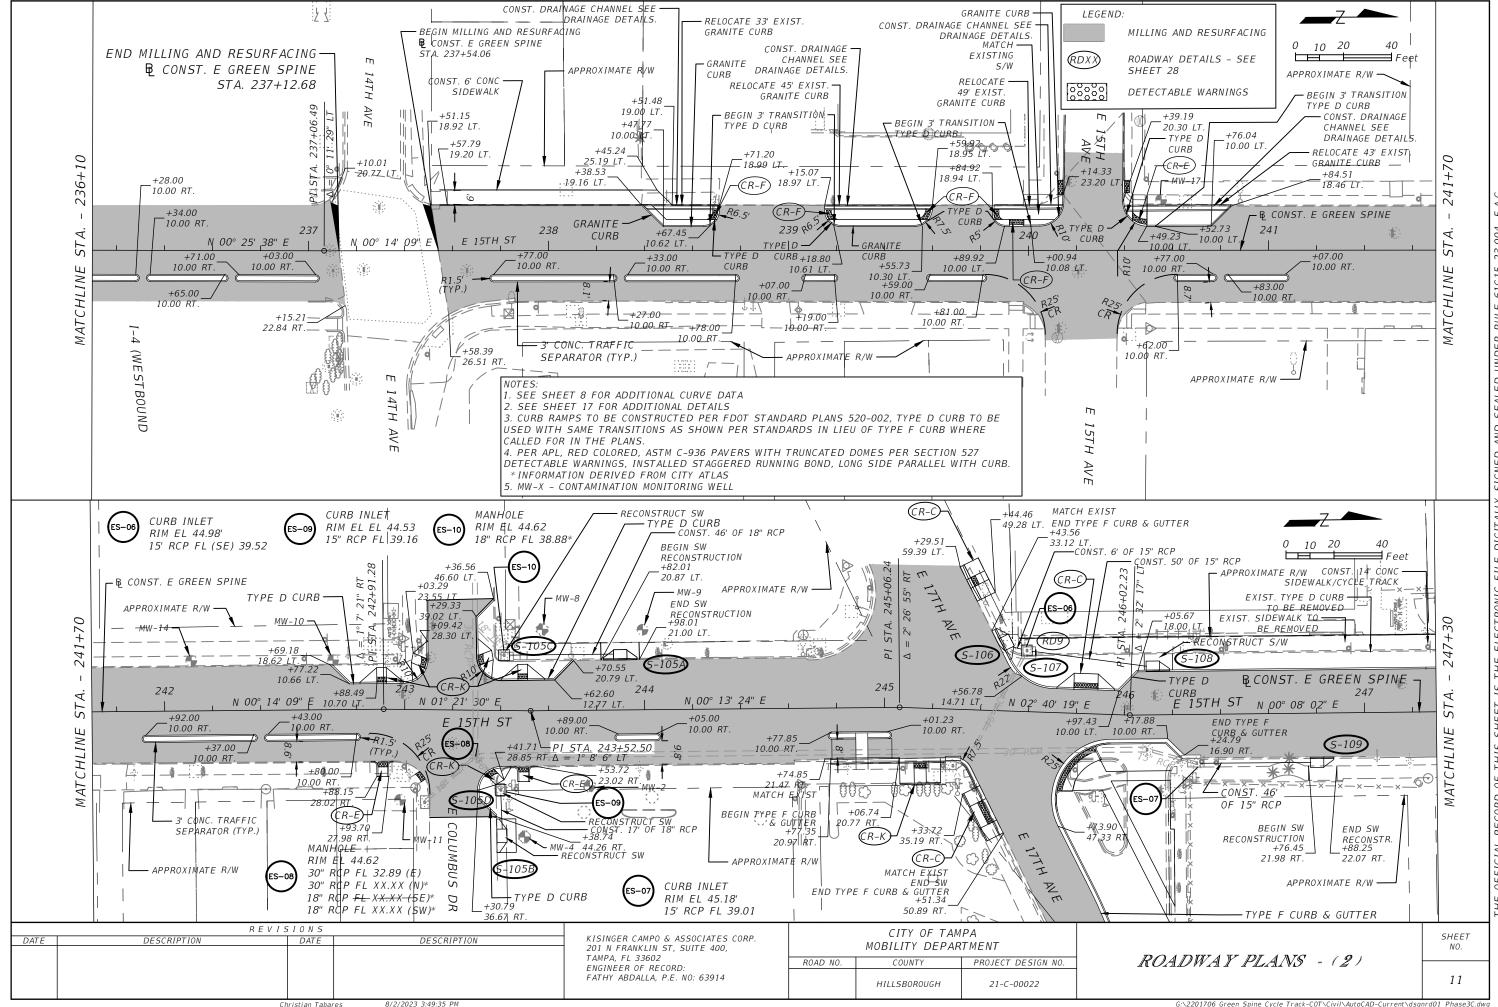

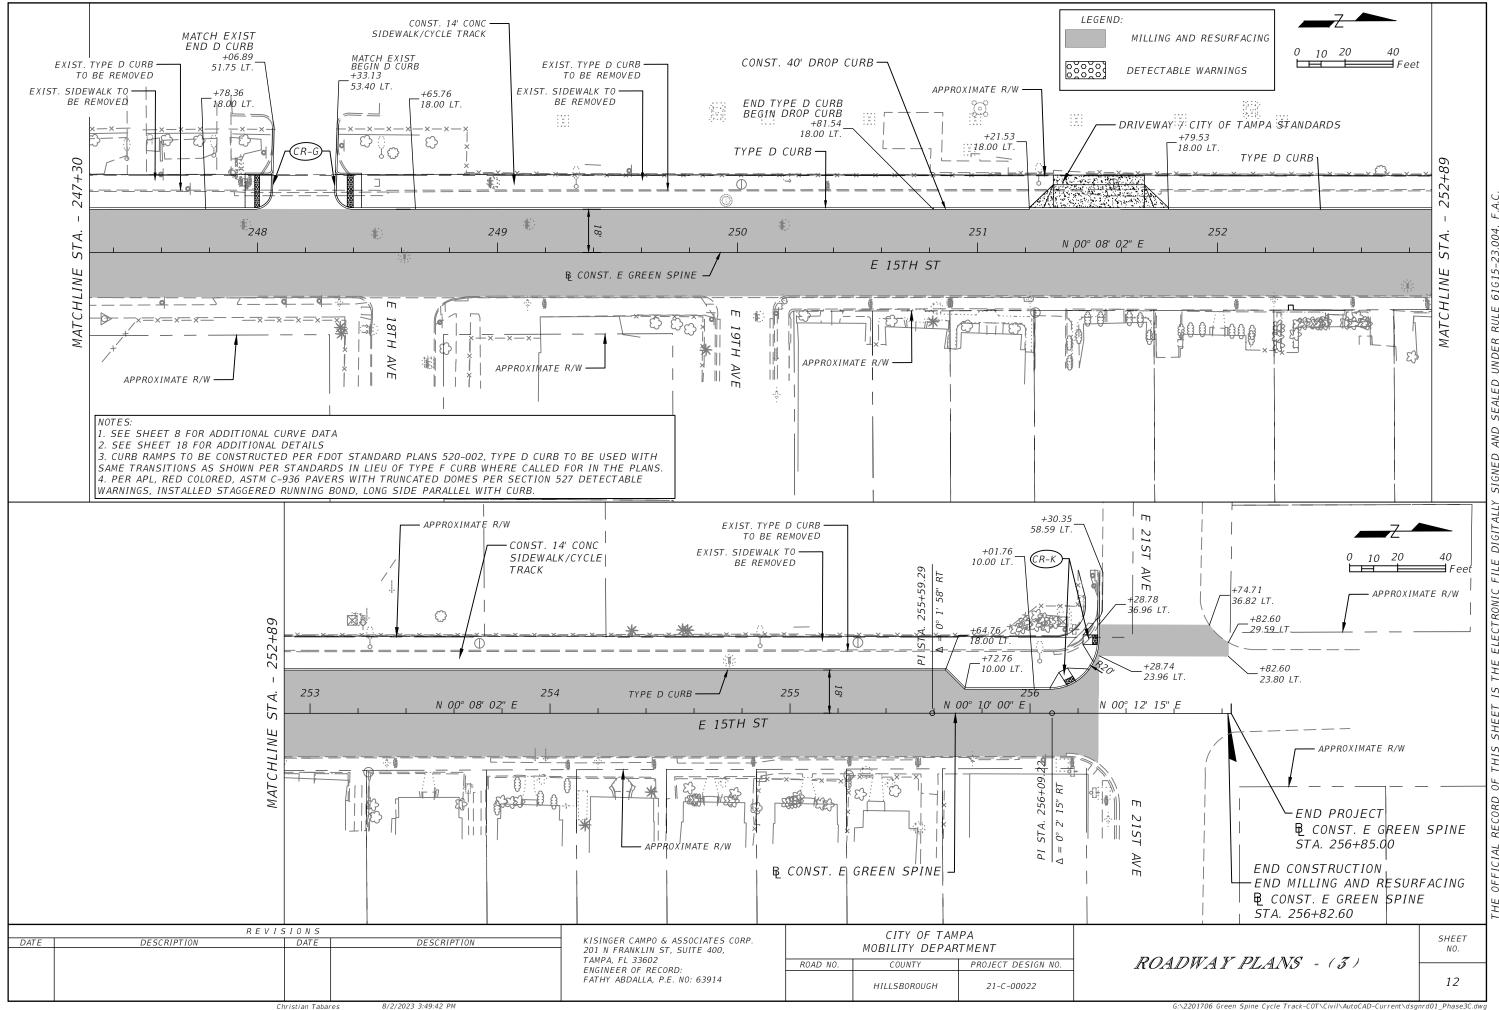


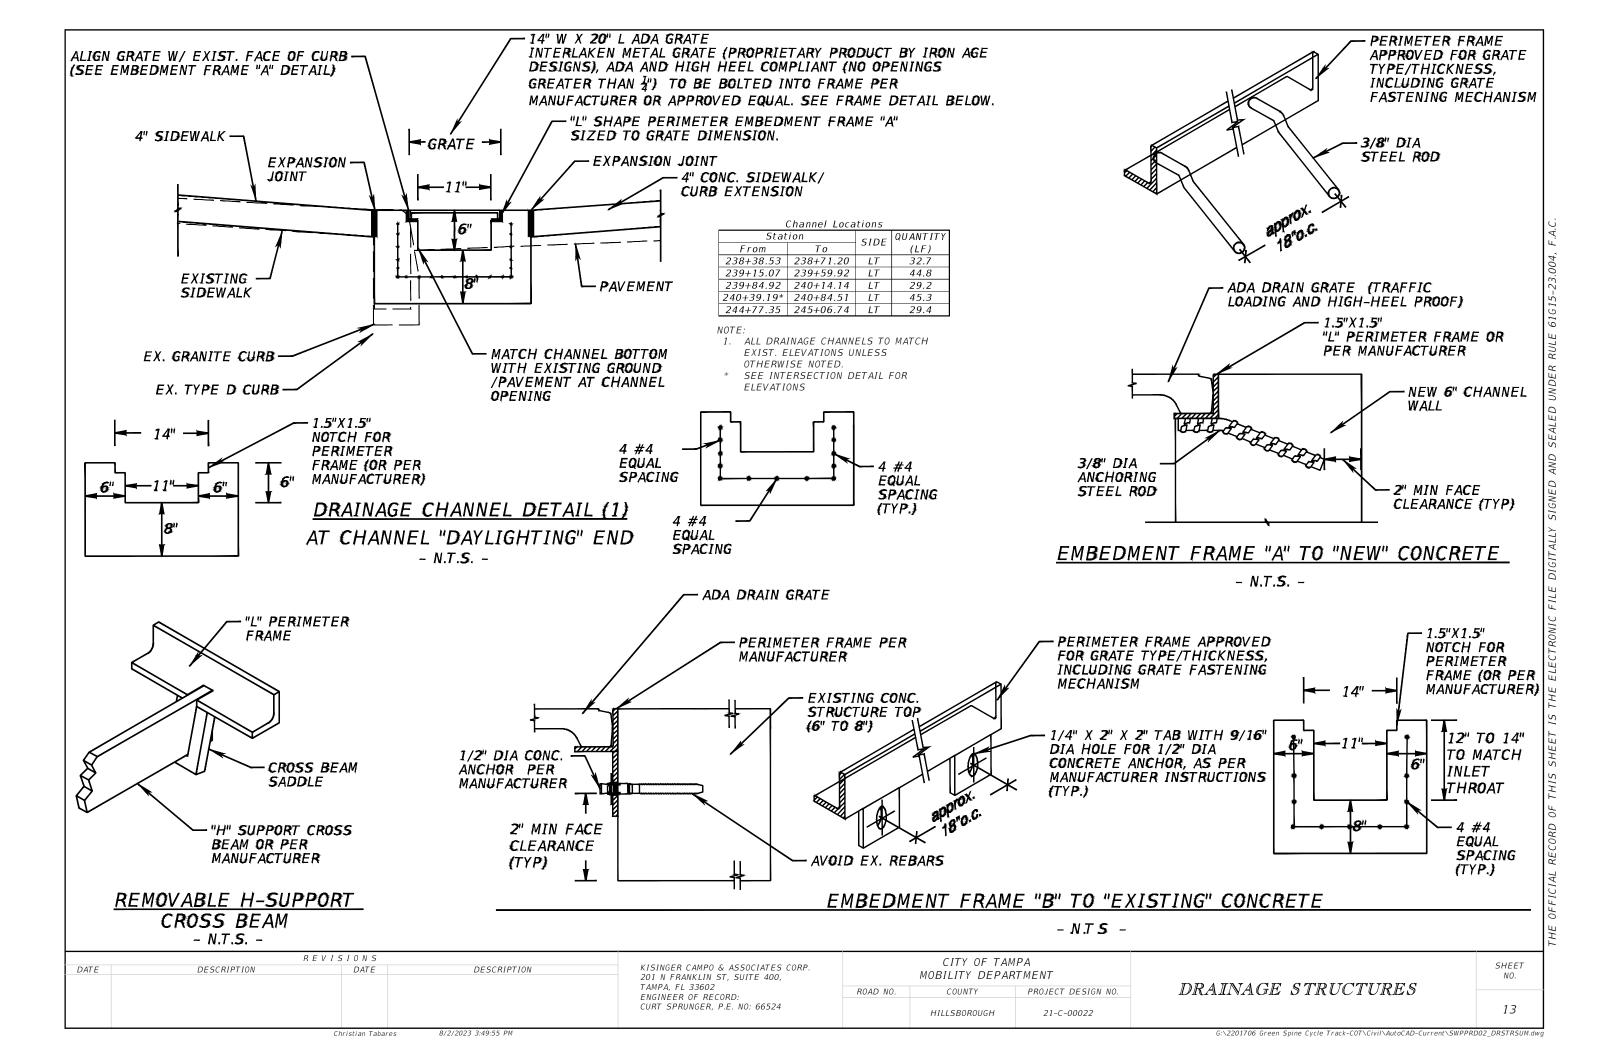

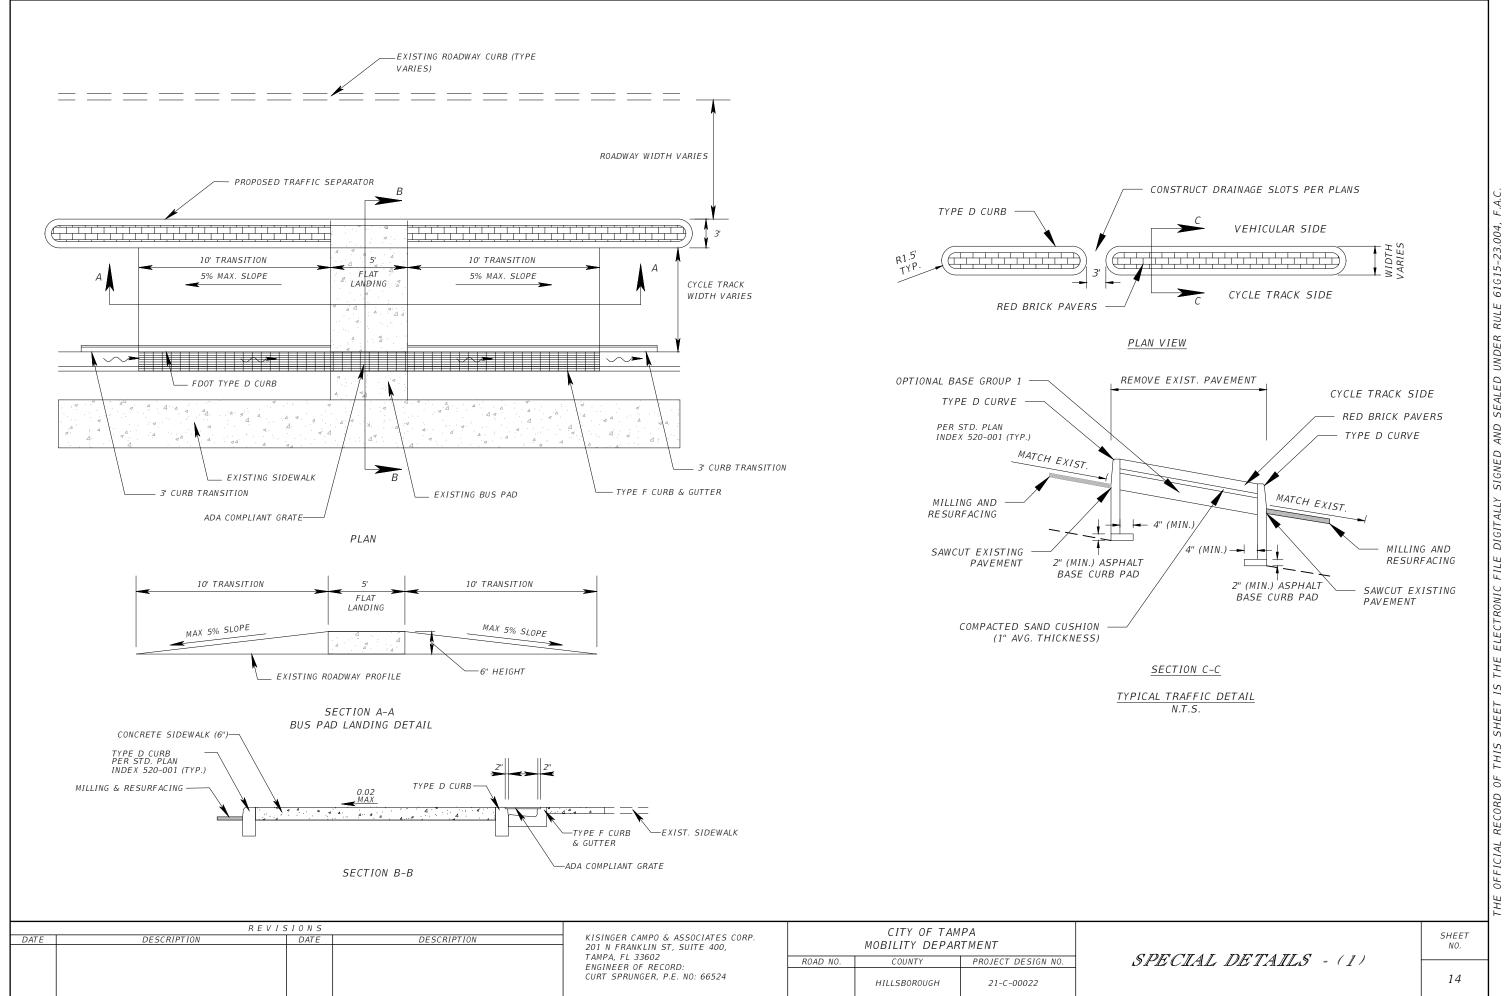


Christian Tabares

8/2/2023 3:50:03 PM

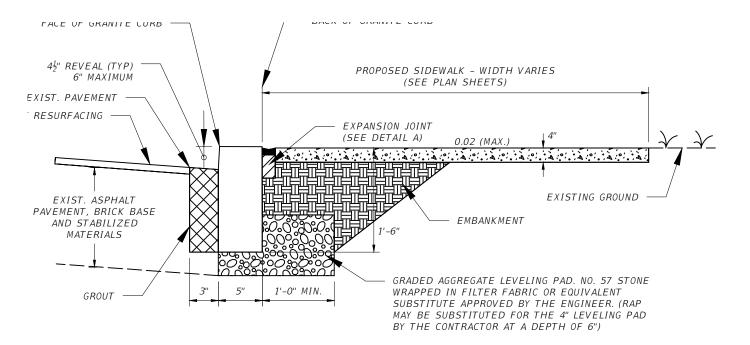

RESETTING GRANITE CURB

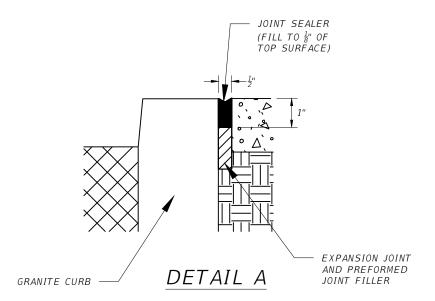



DATE	R E V I S DESCRIPTION	I O N S DATE	DESCRIPTION	KISINGER CAMPO & ASSOCIATES CORP.	CITY OF TAMPA				
DALE	DESCRIFTION	DATE	DESCRIFTION	201 N FRANKLIN ST, SUITE 400,	MOBILITY DEPARTMENT				
				TAMPA, FL 33602 ENGINEER OF RECORD:	ROAD NO.	COUNTY	PROJECT DESIGN NO.		
				FATHY ABDALLA, P.E. NO: 63914		HILLSBOROUGH	21-C-00022		


SPECIAL DETAILS - (2)


SHEET NO.


Christian Tabares 8/2/2023 3:50:08 PM

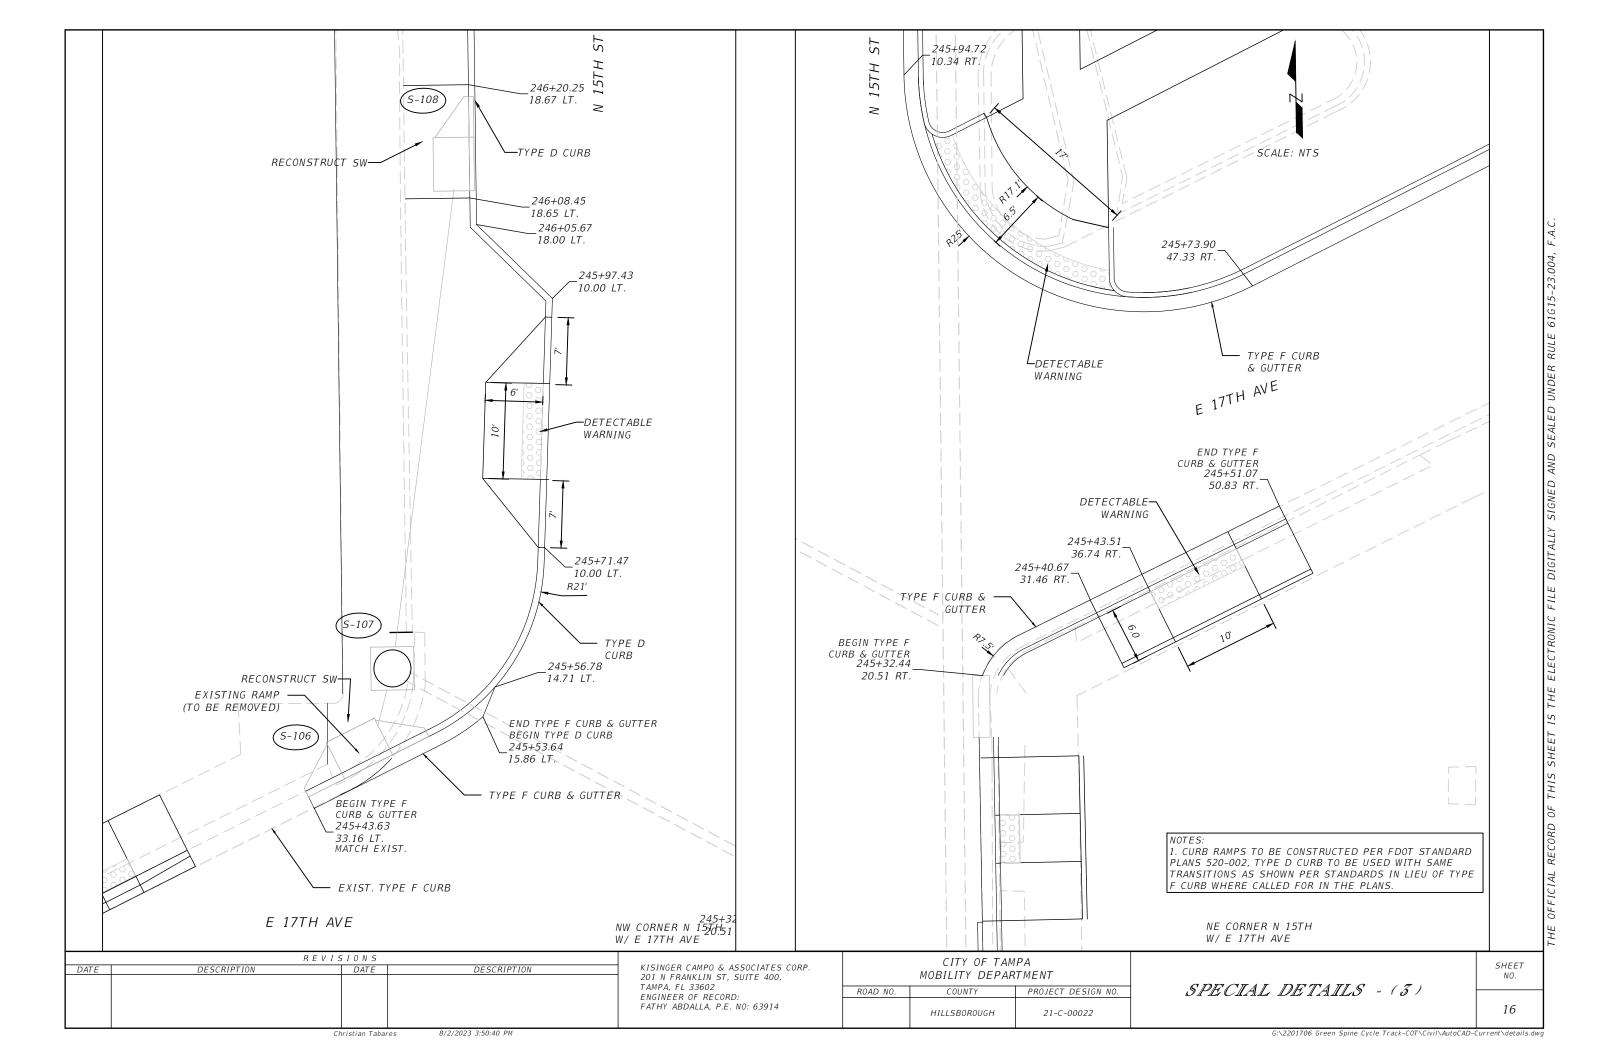


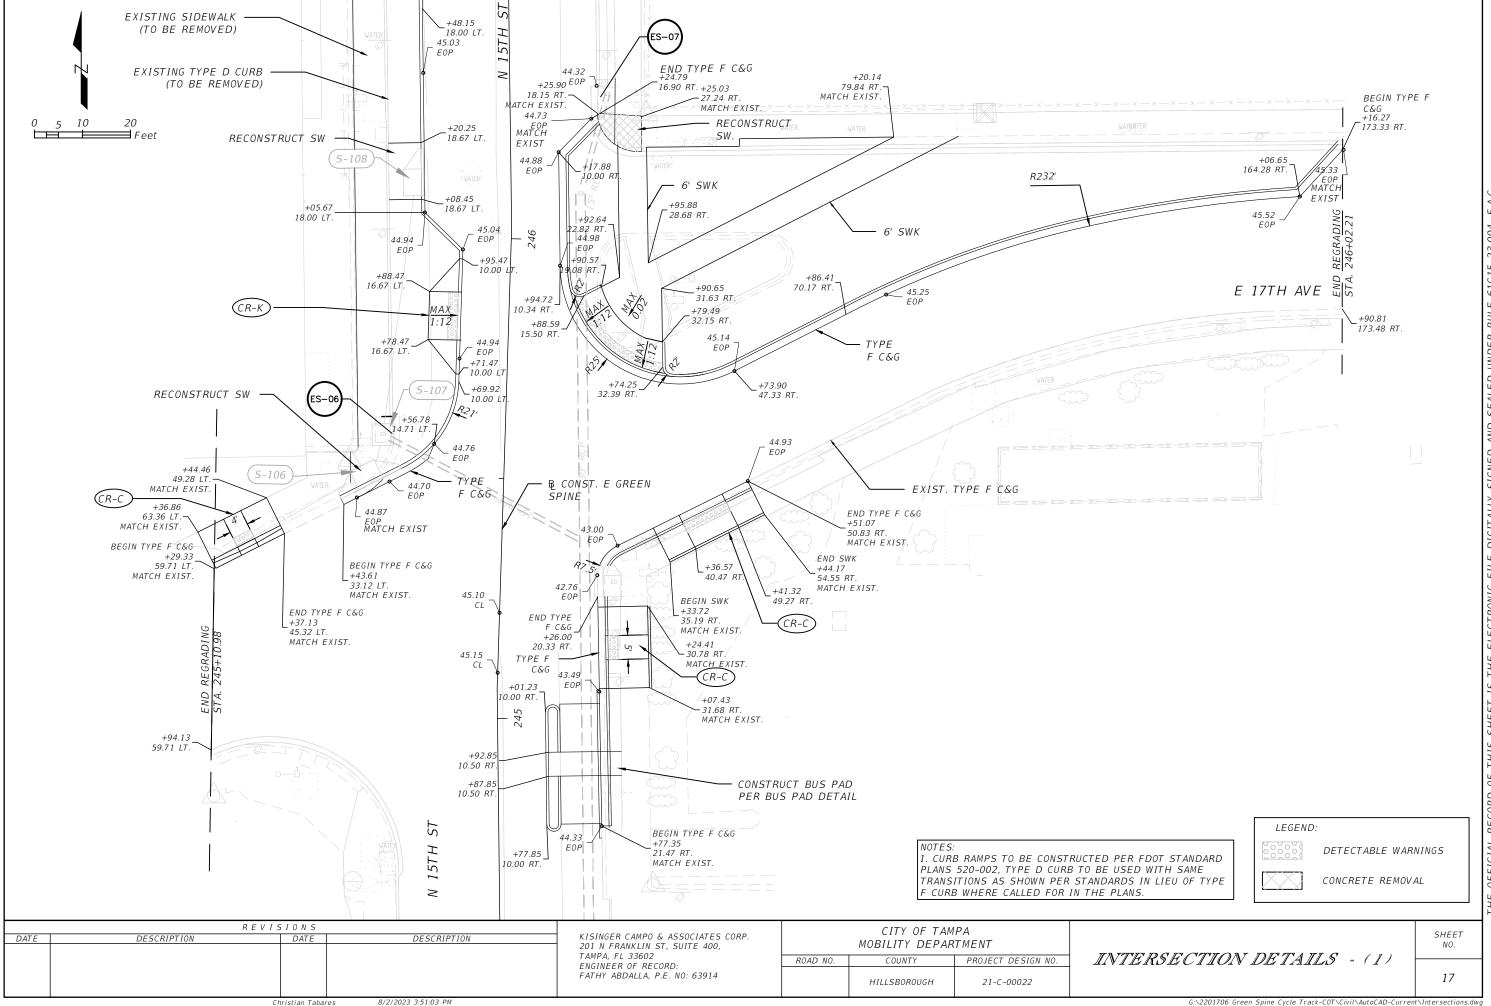

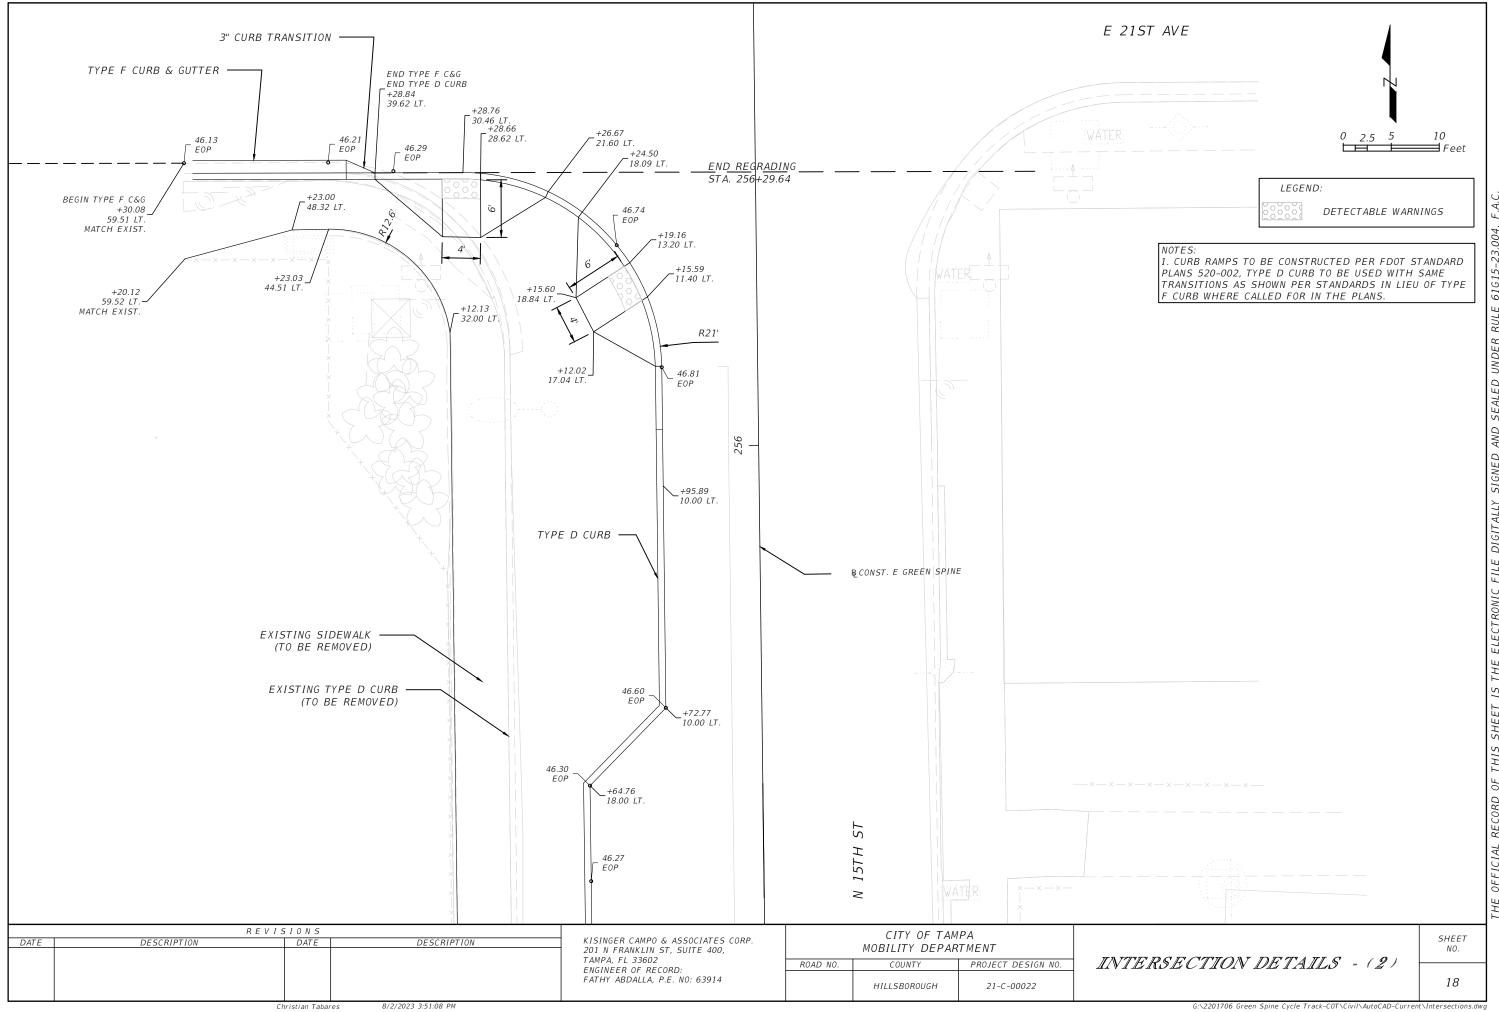

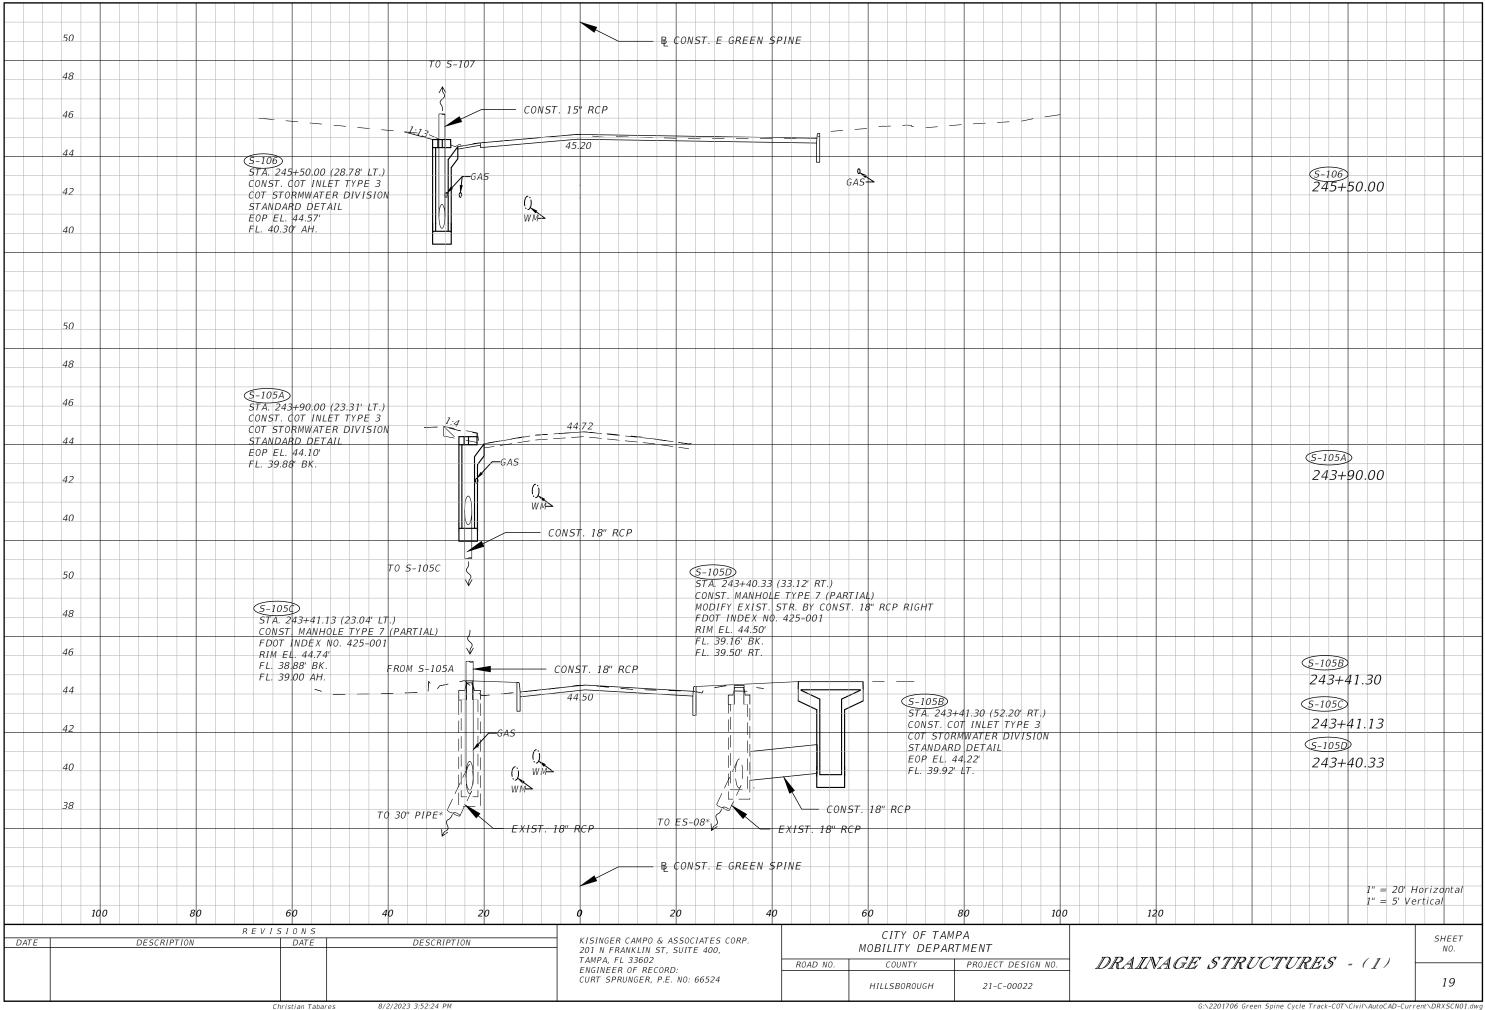

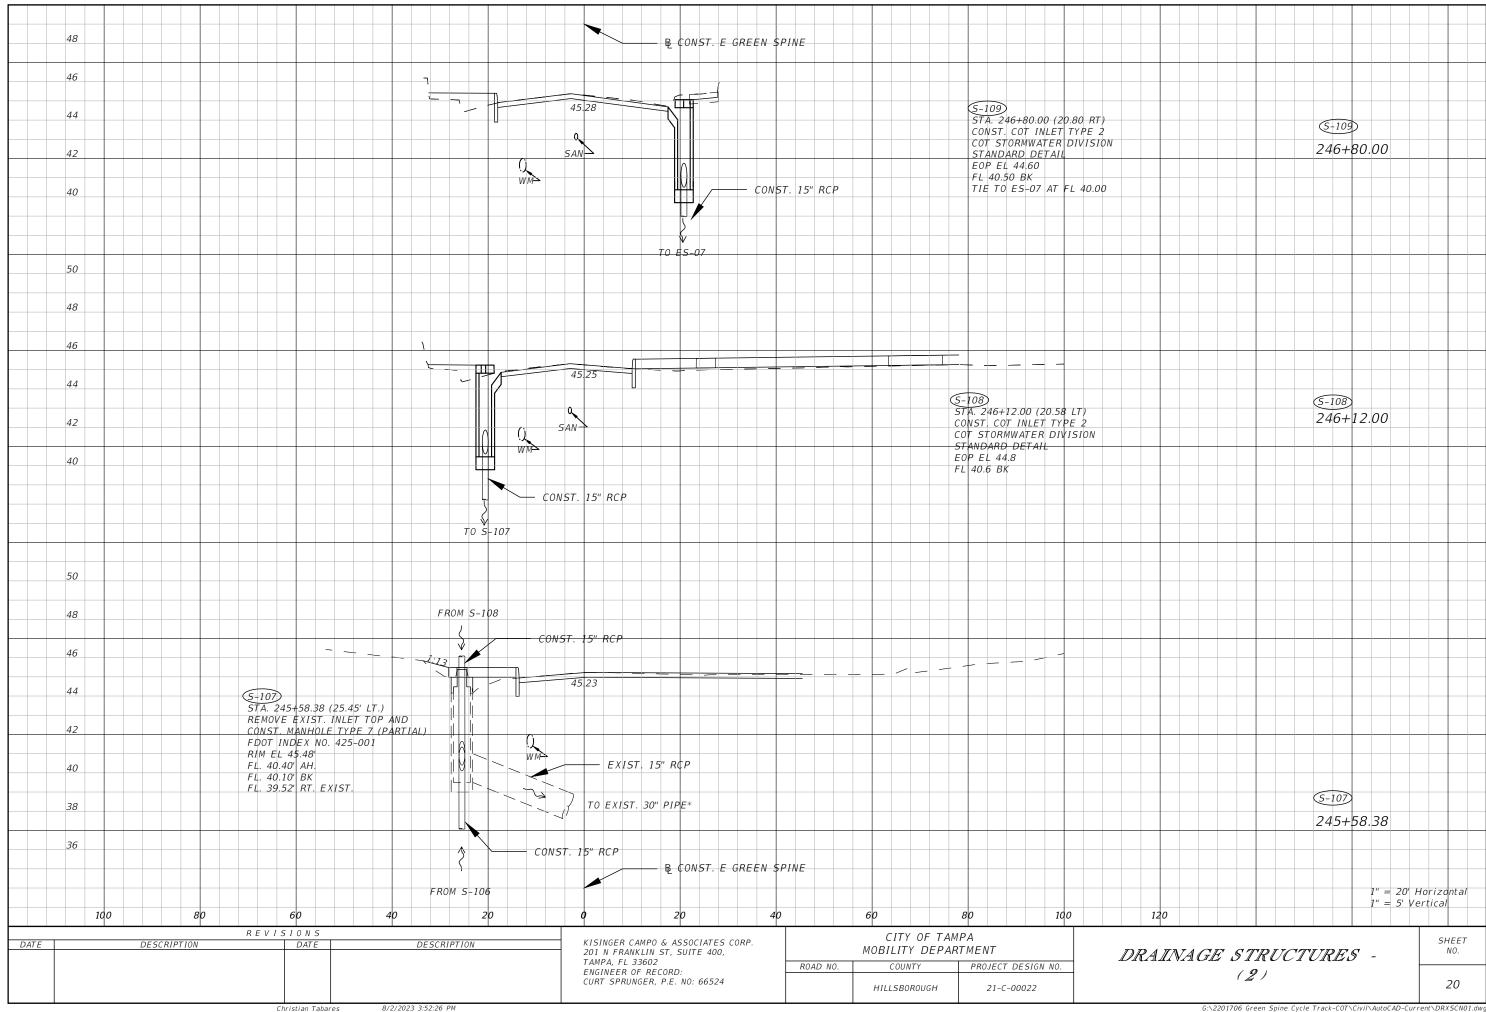

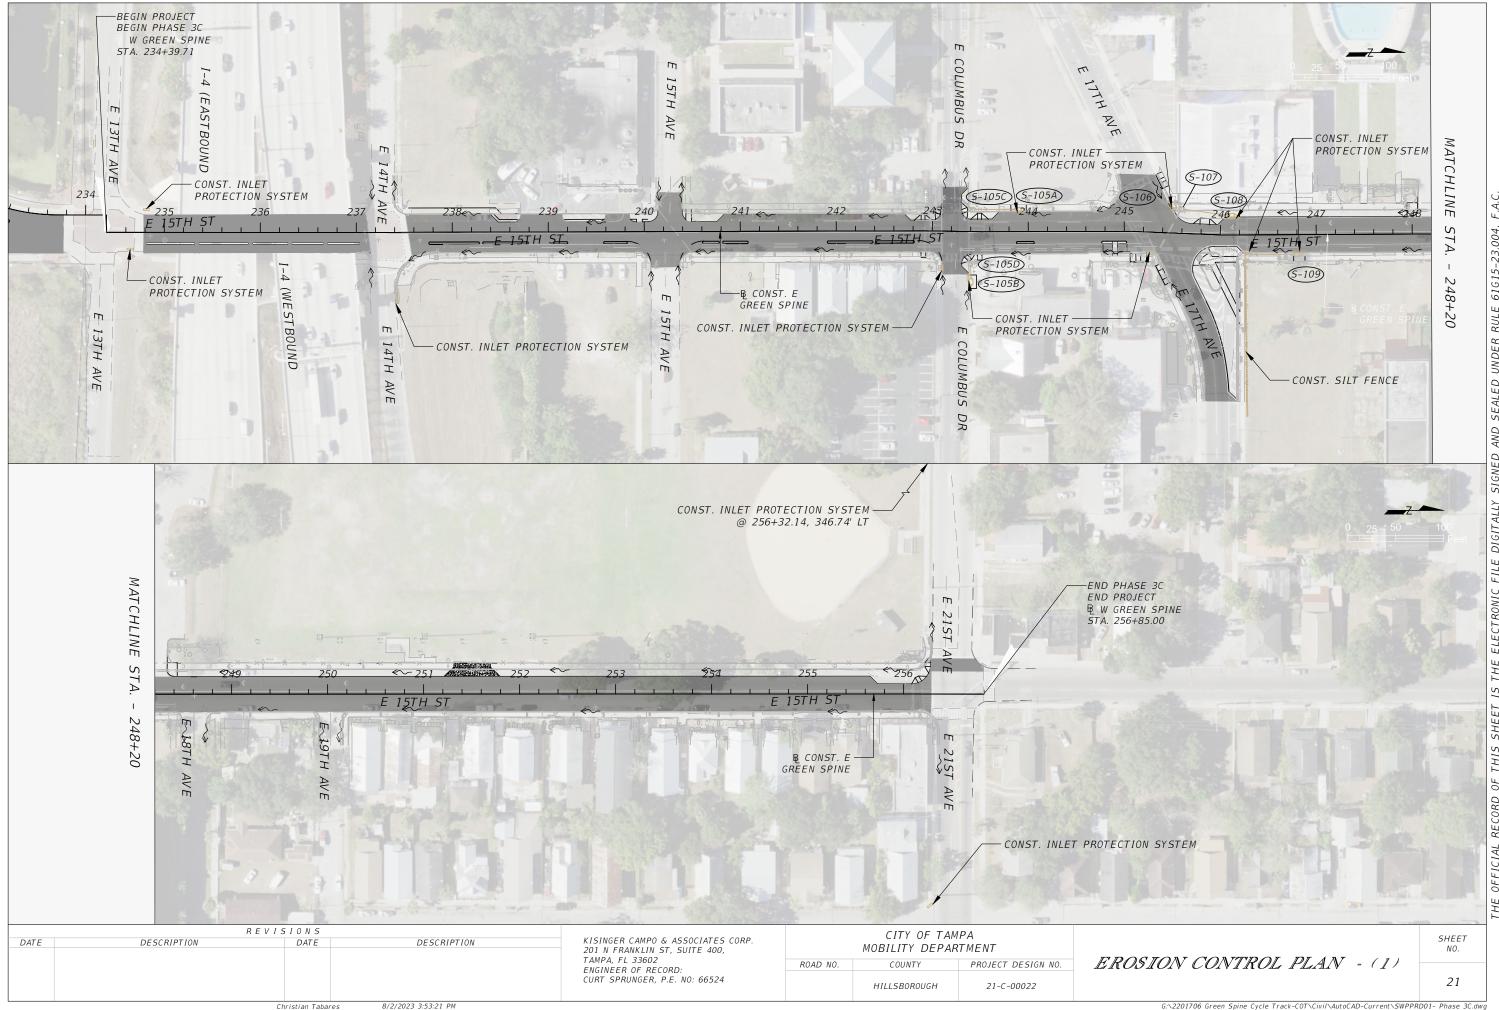

A. CONSTRUCTION ACTIVITY

ACTIVITIES ON THIS PROJECT INCLUDE BUT ARE NOT LIMITED TO CONSTRUCTION OF A BI-DIRECTIONAL CYCLE TRACK ALONG NUCCIO PKWY, INTERSECTION GRADING FROM E 7TH AVENUE TO E 21ST AVENUE.

B. PROJECT LIMITS

THE PROJECT LIMITS ARE ALONG NUCCIO PKWY FROM E 13TH AVENUE TO E 21ST AVENUE.

C. PROJECT DESCRIPTION

THE CITY WILL CONSTRUCT A NEW BI-DIRECTIONAL CYCLE TRACK WITHIN THE PROJECT LIMITS. EXISTING ROADWAYS WILL BE SHARED WITH THE PROPOSED CYCLE TRACK. THE CYCLE TRACK WILL BE 8 TO 12 FEET WIDE SEPARATED FROM THE ROADWAY BY A TRAFFIC SEPARATOR.

D. MAJOR SOIL DISTURBING ACTIVITIES

CONSTRUCTION OF THE CYCLE TRACK, INTERSECTION GRADING AND STORMSEWER MODIFICATION.

E. TOTAL PROJECT LENGTH: 0.4 MILES

F. SOIL DATA

MAJOR SOIL GROUPS IN THE PROJECT LIMITS INCLUDE:

- 1. 77.5% URBAN LAND, 0 TO 2 PERCENT SLOPES (56)
- 2. 11.1% MYAKKA-URBAN LAND COMPLEX (32)
- 3. 4.9% IMMOKALEE-URBAN LAND COMPLEX (22)
 4. 3.4% WATER (99)
- 5. 3.1% TAVARES-URBAN LAND COMPLEX, 0 TO 5 PERCENT SLOPES (55)

H. DRAINAGE AREA: 4.2 AC

I. RECEIVING WATERS

EXISTING STORMSEWER SYSTEMS (HILLSBOROUGH RIVER AND TAMPA BAY)

J. <u>WETLANDS AREAS</u> NO WETLAND IMPACTS

II. CONTROLS

ALL CONTROLS SHALL BE CONSISTENT WITH PERFORMANCE STANDARDS FOR EROSION AND SEDIMENT CONTROL AND STORM—WATER TREATMENT SET FORTH IN RULE 62-40.432, F.A.C., THE APPLICABLE STORM—WATER OR ENVIRONMENTAL RESOURCE PERMITTING REQUIREMENTS OF THE DEPARTMENT OR A WATER MANAGEMENT DISTRICT AND THE GUIDELINES CONTAINED IN THE FLORIDA DEVELOPMENT MANUAL: A GUIDE TO SOUND LAND AND WATER MANAGEMENT (DEP. 1988) AND ANY SUBSEQUENT AMENDMENTS.

A. SEQUENCE OF MAJOR ACTIVITIES

FROSION PROTECTION DEVICES.

- INSTALL INLET PROTECTION AS SHOWN ON THE EROSION AND SEDIMENT (E&S) PLAN AND CONSTRUCTION DRAWING.
- 2. INSTALL SILT FENCE.
- 3. STABILIZE, MAINTAIN, AND REPLACE E&S AS DIRECTED BY THE ENGINEER.
- 4. PERFORM WEEKLY INSPECTION OF E&S AND AFTER EVERY 2" RAINFALL.
- 5. REMOVE ALL SEDIMENTS THAT HAVE MIGRATED OFF SITE AS DIRECTED BY THE ENGINEER.
 6. WHEN CONSTRUCTION ACTIVITY IS COMPLETE AND THE SITE IS STABILIZED, REMOVE

B. <u>EROSION AND SEDIMENT CONTROL CONSTRUCTION ACTIVITIES</u>

THE CONTRACTOR IS REQUIRED TO REVIEW THE SITE SPECIFIC EROSION CONTROL PLAN. THE CONTRACTOR MAY ALSO BE REQUIRED TO MODIFY THE PLAN OR MATERIALS TO ADAPT TO SEASONAL VARIATIONS OR SITE CONDITIONS. CONTRACTOR WILL COMPLY WITH E & S PLAN. ANY MODIFICATIONS TO THIS PLAN MUST BE SIGNED BY A PROFESSIONAL ENGINEER REPRESENTING THE CONTRACTOR. THE EROSION CONTROL DEVICES, DETAILS, AND NOTES APPLICABLE TO THESE ACTIVITIES ARE SPECIFIED IN THE PLANS. THE PROJECT ENGINEER IS RESPONSIBLE FOR DETERMINING IF ADDITIONAL CONTROLS ARE THE PROJECT ENGINEER MAY REQUIRE ADDITIONAL CONTROLS TO MEET STANDARDS AND REGULATIONS.

PERFORM DAILY INSPECTION OF EROSION AND SEDIMENT CONTROLS AFTER EVERY ½" RAINFALL

REMOVE ALL SEDIMENTS THAT HAVE MIGRATED OFF SITE AS DIRECTED BY THE ENGINEER

C: <u>STABILIZATION PRACTICES</u>

D:

DURING CONSTRUCTION THE CONTRACTOR WILL PROVIDE STABILIZATION FOR AREAS WHICH HAVE BEEN CLEARED AND NOT REWORKED WITHIN FOURTEEN (14) CALENDAR DAYS. THE CONTRACTOR MAY UTILIZE TEMPORARY SEEDING OR TEMPORARY SODDING IN ACCORDANCE WITH SECTION 570 OF THE "FDOT STANDARD SPECIFICATIONS FOR ROAD AND BRIDGE CONSTRUCTION".

TEMPORARY GRASSING PERMANENT SODDING OR SEEDING
PERMANENT SODDING OR SEEDING
PRESERVATION OF NATURAL RESOURCES
BUFFER ZONES
STRUCTURAL PRACTICES

	SYNTHETIC BALES (LF)	
	ARTIFICIAL COVERINGS/ ROLLED EROSION CONTROL PRODUCTS	(SY)
X	INLET PROTECTION SYSTEM (EA)	
	LITTER REMOVAL AND DISPOSAL (AC)	
	MOWING (AC)	
	SLOPE DRAINS (TEMPORARY)/ RUNOFF CONTROL STRUCTURES	(LF)
	SOIL TRACKING PREVENTION DEVICE (EA)	
	SEDIMENT BASINS/CONTAINMENT SYSTEMS (EA)	
	SEDIMENT BASIN/ CONTAINMENT SYSTEM CLEANOUT (EA)	
	FLOATING TURBIDITY BARRIER (LF)	
X	STAKED SILT FENCE (LF)	
	CHEMICAL TREATMENT - POWDERED (SY)	

E: <u>DESCRIPTION OF STORM WATER MANAGEMENT</u>

WHERE NO PROPOSED STORMWATER SYSTEMS EXIST STORMWATER WILL DISCHARGE INTO EXISTING SYSTEMS AND SWALES. PROPOSED STORMSEWER SHALL BE CONSTRUCTED DURING THE INITIAL PHASE AND BE USED DURING CONSTRUCTION. THE OUTFALL STRUCTURES ARE TO BE PROTECTED WHEN TEMPORARY SEDIMENT BASINS, CONTAINMENT SYSTEMS OR PERMANENT STORMWATER MANAGEMENT FACILITIES ARE USED FOR EROSION AND SEDIMENT CONTROL TO PREVENT DOWNSTREAM SEDIMENTATION.

CHEMICAL TREATMENT (FLOC LOGS, DRUMS OF PRODUCT) (EA)

F: SANITARY WASTE

FDOT STANDARD SPEC. FOR ROAD AND BRIDGE CONSTRUCTION" SECTION 7 — 6. "SANITARY PROVISIONS." "THE CONTRACTOR SHALL PROVIDE AND MAINTAIN, IN A NEAT AND SANITARY CONDITION, SUCH ACCOMMODATION FOR THE USE OF HIS EMPLOYEES AS ARE NECESSARY TO COMPLY WITH THE REQUIREMENTS AND REGULATIONS OF THE STATE AND LOCAL BOARDS OF HEALTH. COMMIT NO PUBLIC NUISANCE."

G: <u>HAZARDOUS WASTE</u>

THE CONTRACTOR WILL IMMEDIATELY NOTIFY THE CITY IN WRITING IF ANY HAZARDOUS WASTE MATERIAL IS ENCOUNTERED DURING SITE INVESTIGATION OR CONSTRUCTION.

THE CONTRACTOR WILL ALSO BE RESPONSIBLE FOR NOTIFYING THE FLORIDA DEPARTMENT OF ENVIRONMENTAL PROTECTION (FDEP) WITHIN 24 HOURS OF THE DISCOVERY

ALL HAZARDOUS WASTE MATERIALS, IF ENCOUNTERED, WILL BE DISPOSED OF IN THE MANNER SPECIFIED BY LOCAL, STATE, AND FEDERAL REGULATIONS. THE CONTRACTOR WILL BE RESPONSIBLE FOR SEEING THAT THESE PRACTICES ARE FOLLOWED.

IN CASE OF DISPOSING ANY HAZARDOUS WASTE MATERIAL FOLLOWING LOCAL, STATE, AND FEDERAL REGULATIONS, A COPY OF DISPOSAL MANIFEST HAS TO BE PROVIDED TO THE CITY IN TIMELY FASHION

PERMITTEE CERTIFICATION

I CERTIFY UNDER PENALTY OF LAW THAT THIS DOCUMENT AND ALL ATTACHMENTS WERE PREPARED UNDER MY DIRECTION OR SUPERVISION IN ACCORDANCE WITH A SYSTEM DESIGNED TO ASSURE THAT QUALIFIED PERSONNEL PROPERLY GATHERED AND EVALUATED THE INFORMATION SUBMITTED. BASED ON MY INQUIRY OF THE PERSON OR PERSONS WHO MANAGE THE SYSTEM, OR THOSE PERSONS DIRECTLY RESPONSIBLE FOR GATHERING THE INFORMATION, THE INFORMATION SUBMITTED IS, TO THE BEST OF MY KNOWLEDGE AND BELIEF, TRUE, ACCURATE, AND COMPLETE. I AM AWARE THAT THERE ARE SIGNIFICANT PENALTIES FOR SUBMITTING FALSE INFORMATION, INCLUDING POSSIBILITY OF FINE AND IMPRISONMENT FOR KNOWING VIOLATIONS.

NINA MABILLEAU	,				DAT	Œ
CITY OF TAMPA	TRANSPORTATION	AND	STORMWATER	SERVICES		

CONTRACTOR CERTIFICATION

I CERTIFY UNDER PENALTY OF LAW THAT I UNDERSTAND, AND SHALL COMPLY WITH , THE TERMS AND CONDITIONS OF THE STATE OF FLORIDA GENERIC PERMIT FOR STORMWATER DISCHARGE FROM LARGE AND SMALL CONSTRUCTION ACTIVITIES AND THIS STORMWATER POLLUTION PREVENTION PLAN PREPARED THEREUNDER.

GENERAL CONTRACTOR NAME & TITLE	DATE

COMPANY NAME

COMPANY STREET ADDRESS

CITY, STATE, ZIP CODE

A. WATER QUALITY MONITORING (MIXING ZONES)

THE WATER THAT WILL BE SAMPLED FOR STATE WATER QUALITY STANDARDS FOR CONSTRUCTION ACTIVITIES PROHIBIT A TURBIDITY INCREASE OF GREATER THAN 29 NTU'S ABOVE AMBIENT CONDITIONS AT THE COMPLIANCE LOCATION OF THE MIXING ZONES. TO MAINTAIN THIS STANDARD, TURBIDITY MONITORING SHALL OCCUR DURING ALL IN—WATER CONSTRUCTION ACTIVITIES AT EACH COMPLIANCE AND BACKGROUND STATION. THE FOLLOWING PROCEDURE SHALL BE USED:

FREQUENCY: TWICE A DAY, AT LEAST 4 HOURS APART DURING FREQUENCY OF ACTUAL CONSTRUCTION OPERATIONS

LOCATIONS: ALL STATIONS SHALL BE SAMPLED AT 2 FEET ABOVE LOCATIONS THE BOTTOM, AT MID—DEPTH, AND AT THE SURFACE, OR AS DIRECTED BY PERMITTING AGENCIES. IF WATER IS LESS THAN THREE FEET DEEP, ONLY MID—DEPTH SAMPLES ARE REQUIRED.

BACKGROUND: 500 FEET UP-CURRENT FROM THE CONSTRUCTION BACKGROUND ACTIVITY AND OUTSIDE OF ANY TURBIDITY PLUME FROM THE CONSTRUCTION ACTIVITY.

COMPLIANCE: 300 FEET DOWN CURRENT FROM THE CONSTRUCTION COMPLIANCE ACTIVITY WITHIN ANY VISIBLE TURBIDITY PLUME, OR AS DIRECTED BY PERMITTING AGENCIES.

METHOD: ALL SAMPLES SHALL BE COLLECTED WITH A KEMMERER, VAN DORN METHOD, OR SIMILAR SAMPLER WHICH IS DESIGNED TO COLLECT IN SITU WATER SAMPLES.

REPORTING: ALL MONITORING DATA SHALL BE SUBMITTED WITHIN ONE REPORTING WEEK OF ANALYSIS WITH DOCUMENTS CONTAINING THE FOLLOWING INFORMATION:

R E V I S I O N S DATE DESCRIPTION DATE DESCRIPTION

KISINGER CAMPO & ASSOCIATES CORP. 201 N FRANKLIN ST, SUITE 400, TAMPA, FL 33602 ENGINEER OF RECORD: CURT SPRUNGER, P.E. NO: 66524 CITY OF TAMPA
MOBILITY DEPARTMENT

COUNTY PROJECT DESIGN NO.

HILLSBOROUGH 21-C-00022

STORMWATER POLLUTION PREVENTION PLAN (1) SHEET NO.

22

Christian Tabares 8/2/2023 3:53:32 PM

- 2. DATES OF SAMPLING AND ANALYSIS
- 3. LOCATION OF SAMPLE (I.E., STATION AND WATER COLUMN LOCATION)
- 4. A STATEMENT DESCRIBING THE METHODS USED IN COLLECTION, HANDLING,
- 5. STORAGE, AND ANALYSIS OF THE SAMPLES
- 6. A MAP INDICATING THE SAMPLING LOCATIONS
- STATEMENT, BY THE INDIVIDUAL RESPONSIBLE FOR IMPLEMENTATION OF THE SAMPLING PROGRAM, CONCERNING THE AUTHENTICITY, PRECISION, LIMITS OF DETECTION AND ACCURACY OF DATA.

MONITORING REPORTS SHALL INCLUDE INFORMATION ON THE GENERAL ANTECEDENT WEATHER CONDITIONS.

IF MONITORING REVEALS VIOLATIONS OF THE STATE WATER QUALITY STANDARD FOR TURBIDITY, CONSTRUCTION ACTIVITIES SHALL CEASE IMMEDIATELY AND NOT RESUME UNTIL CORRECTIVE MEASURES HAVE BEEN TAKEN AND TURBIDITY HAS RETURNED TO ACCEPTABLE LEVELS. ANY SUCH OCCURRENCE SHALL ALSO BE IMMEDIATELY REPORTED TO THE REGULATORY AGENCIES. IN THE EVENT THAT STATE WATER QUALITY STANDARDS ARE NOT ATTAINED, THE CONTRACTOR SHALL IMPLEMENT A CONTINGENCY PLAN WHICH COMPLIES WITH THE PROJECT SWFWMD/FDEP ERP AND CITY OF TAMPA NPDES REQUIREMENTS AT NO ADDITIONAL COST TO THE COUNTY. ANY FINES SHALL BE RESPONSIBILITY OF THE CONTRACTORS.

K. APPROVED STATE, LOCAL PLANS, OR STORM WATER PERMITS

SWFWMD PERMIT EXEMPTION, FILE NUMBER 785609.

III. MAINTENANCE

A. ALL OF THE CONTROLS SHALL BE MAINTAINED AT ALL TIMES.

THE CONTRACTOR SHALL BE RESPONSIBLE FOR DAILY INSPECTION AND MAINTENANCE OF ALL PERMANENT AND TEMPORARY EROSION CONTROL DEVICES THROUGHOUT ALL CONSTRUCTION PHASES OF THE PROJECT.

B. INSPECTION

THE CITY INSPECTOR SHALL BE RESPONSIBLE FOR COMPLETING THE D.E.I. NPDES / SWPPP CONSTRUCTION INSPECTION REPORT AFTER ANY ½" RAINFALL OR WEEKLY, IF NO RAIN EVENT OCCURRED. IT IS THE CONTRACTOR'S RESPONSIBILITY TO MAINTAIN RAIN GAUGES ON THE PROJECT SITE AND RECORD WEEKLY RAIN FALL. THE CITY INSPECTOR SHALL ALSO COMPLETE THE CITY OF TAMPA D.E.I. NPDES COMPLIANCE CHECKLIST FOR CONSTRUCTION SITES.

C. <u>NON-STORM WATER DISCHARGES</u>

IT IS EXPECTED THAT THE FOLLOWING NON-STORM WATER DISCHARGES MAY OCCUR FROM THE SITE DURING THE CONSTRUCTION PERIOD:

- PAVEMENT WASH WATERS (WHERE NO SPILL OR LEAKS OF VEHICLE AND HAZARDOUS MATERIALS HAVE OCCURRED)
- UNCONTAMINATED GROUNDWATER FROM DE-WATERING ACTIVITIES

ALL NON-STORM WATER DISCHARGES WILL BE DIRECTED TO THE SEDIMENT BASIN PRIOR TO DISCHARGE OR AS DIRECTED BY THE ENGINEER. IF CONTAMINATED SOIL OR GROUNDWATER IS ENCOUNTERED, DEATERING SHOULD CEASE IMMEDIATELY AND THE ENGINEER WILL BE CONTACTED.

D. MATERIAL MANAGEMENT PRACTICES

THE FOLLOWING ARE THE MATERIAL HANDLING PRACTICES THAT WILL BE USED TO REDUCE THE RISK OF SPILLS OR OTHER ACCIDENTAL EXPOSURE OF MATERIALS AND SUBSTANCES TO STORM WATER RUNOFF:

1. THE FOLLOWING GOOD HOUSEKEEPING PRACTICES SHALL BE FOLLOWED ON—SITE DURING THE CONSTRUCTION PROJECT.

- STORE ONLY ENOUGH PRODUCT REQUIRED TO DO THE JOB ON SITE.
- ALL MATERIALS STORED ON SITE SHALL BE STORED IN A NEAT, ORDERLY MANNER IN THEIR ORIGINAL MANUFACTURER'S LABELED CONTAINERS UNDER A ROOF OR OTHER CONTAINED ENCLOSURE.
- SUBSTANCES SHALL NOT BE MIXED WITH ONE ANOTHER UNLESS RECOMMENDED BY THE MANUFACTURER.
- WHENEVER POSSIBLE, ALL OF A PRODUCT SHALL BE USED BEFORE DISPOSING OF THE CONTAINER. MANUFACTURERS' RECOMMENDATIONS FOR PROPER USE AND DISPOSAL SHALL BE FOLLOWED.
- THE SITE SUPERINTENDENT SHALL INSPECT DAILY TO ENSURE PROPER USE AND DISPOSAL OF MATERIALS ON—SITE.

2. THESE PRACTICES ARE USED TO REDUCE THE RISKS ASSOCIATED WITH HAZARDOUS MATERIALS.

- PRODUCTS WILL BE KEPT IN ORIGINAL CONTAINERS UNLESS THEY ARE NOT RE—SEALABLE.
- SECONDARY CONTAINMENT SHALL BE PROVIDED FOR ALL OPENED CONTAINERS. ORIGINAL LABELS AND MATERIAL SAFETY DATA SHALL BE KEPT ON—SITE ON THE CONSTRUCTION OFFICE TRAILER.
- IF SURPLUS PRODUCT MUST BE DISPOSED OF, MANUFACTURERS OR LOCAL STATE RECOMMENDED METHODS OF PROPER DISPOSAL SHALL BE FOLLOWED.
- THE CONTRACTOR MUST IDENTIFY A DESIGNATED FUEL TANK STORAGE AREA, AWAY FROM DRAINAGE STRUCTURES, PONDS, BASINS, AND WETLANDS, WITH SECONDARY CONTAINMENT (SPILL COLLECTION).

3. <u>CONCRETE TRUCKS</u>

- CONTRACTOR SHALL DESIGNATE AN AREA AWAY FROM DRAINAGE STRUCTURES, PONDS, BASINS, AND WETLANDS FOR DISCHARGE OF SURPLUS CONCRETE OR DRUM WASH WATER AND SHALL INSTALL A CONTAINMENT BERM AROUND THIS AREA TO PREVENT RUNOFF TO THE REMAINDER OF THE SITE.
- HARD DEBRIS SHALL BE DISPOSED OF BY CONTRACTOR UPON COMPLETION OF THE PROJECT.
- DISPOSAL OF CONCRETE SLURRY DIRECTLY INTO PUBLIC DRAINAGE SYSTEMS IS A VIOLATION OF THE "ILLICIT DISCHARGE" PROVISION.

4. SPILL CONTROL PRACTICES

IN ADDITION TO THE GOOD HOUSEKEEPING AND MATERIALS MANAGEMENT PRACTICES DISCUSSED IN THE PREVIOUS SECTIONS OF THIS PLAN, THE FOLLOWING PRACTICES WILL BE FOLLOWED FOR SPILL PREVENTION AND CLEANUP.

- MANUFACTURERS' RECOMMENDED METHODS FOR SPILL CLEANUP WILL BE CLEARLY POSTED AND SITE PERSONNEL WILL BE MADE AWARE OF THE PROCEDURES AND THE LOCATION OF THE INFORMATION CLEANUP SUPPLIES.
- ALL SPILLS WILL BE CLEANED UP IMMEDIATELY AFTER DISCOVERY.
- THE SPILL AREA WILL BE KEPT WELL VENTILATED AND PERSONNEL WILL WEAR APPROPRIATE PROTECTIVE CLOTHING TO PREVENT INJURY FROM CONTACT WITH A HAZARDOUS SUBSTANCE.

- SPILLS OF TOXIC OR HAZARDOUS MATERIAL WILL BE REPORTED TO THE APPROPRIATE STATE OR LOCAL GOVERNMENT AGENCY, REGARDLESS OF THE SIZE.
- THE SPILL PREVENTION PLAN WILL BE PREPARED BY THE CONTRACTOR AND KEPT IN THE CONSTRUCTION OFFICE TRAILER AND WILL INCLUDE MEASURES TO PREVENT THIS TYPE OF SPILL FROM REOCCURRING AND HOW TO CLEAN UP THE SPILL IF THERE ARE OTHERS. A DESCRIPTION OF THE SPILL, WHAT CAUSED IT, AND THE CLEANUP MEASURES WILL ALSO BE INCLUDED. ALL SPILLS AND RESPONSES WILL BE REPORTED TO THE APPROPRIATE AGENCY.
- THE SITE SUPERINTENDENT WILL BE THE SPILL PREVENTION AND CLEANUP COORDINATOR. HE WILL DESIGNATE OTHER SITE PERSONNEL WHO WILL RECEIVE SPILL PREVENTION AND CLEANUP TRAINING. THESE INDIVIDUALS WILL EACH BECOME RESPONSIBLE FOR A PARTICULAR PHASE OF PREVENTION AND CLEANUP. THE NAMES OF RESPONSIBLE SPILL PERSONNEL WILL BE POSTED IN THE MATERIAL STORAGE AREA AND IN THE OFFICE TRAILER ON SITE.
- USE AND CHARACTERISTICS OF FUEL OR CHEMICAL STORAGE TANK ON SITE SHALL COMPLY WITH ALL RELATED FEDERAL, STATE, AND LOCAL REGULATIONS. STORAGE TANKS MUST BE LOCATED AS FAR AS POSSIBLE FROM ANY DRAINAGE STRUCTURES, DITCHES, AND/OR SURFACE WATERS. IN ADDITION, THE CONTRACTOR MUST PROVIDE A SECONDARY CONTAINMENT WITH A LINER CHEMICALLY RESISTANT TO THE FUEL OR CHEMICAL STORED ON SITE. THE SECONDARY CONTAINMENT MUST BE SIZED TO CONTAIN MINIMUM OF ONE AND A HALF TIME THE TOTAL CAPACITY OF STORAGE TANK BEING USED. CONTRACTOR HAS TO PROVIDE A DAILY INSPECTION LOG FOR THE SECONDARY CONTAINMENT WITH INDICATION OF DATE, INSPECTORS NAME AND INSPECTION REPORT. FURTHERMORE, ANY CONTAMINATION HAS TO BE IMMEDIATELY CONTAINED AND THE COUNTY INSPECTOR MUST BE NOTIFIED OF THE NATURE AND EXTEND OF THE CONTAMINATION.

PERMITTEE CERTIFICATION

I CERTIFY UNDER PENALTY OF LAW THAT THIS DOCUMENT AND ALL ATTACHMENTS WERE PREPARED UNDER MY DIRECTION OR SUPERVISION IN ACCORDANCE WITH A SYSTEM DESIGNED TO ASSURE THAT QUALIFIED PERSONNEL PROPERLY GATHERED AND EVALUATED THE INFORMATION SUBMITTED. BASED ON MY INQUIRY OF THE PERSON OR PERSONS WHO MANAGE THE SYSTEM, OR THOSE PERSONS DIRECTLY RESPONSIBLE FOR GATHERING THE INFORMATION, THE INFORMATION SUBMITTED IS, TO THE BEST OF MY KNOWLEDGE AND BELIEF, TRUE, ACCURATE, AND COMPLETE. I AM AWARE THAT THERE ARE SIGNIFICANT PENALTIES FOR SUBMITTING FALSE INFORMATION, INCLUDING POSSIBILITY OF FINE AND IMPRISONMENT FOR KNOWING VIOLATIONS.

NINA	MABILLEAU,	E.I.				Ī	DATE
CITY	OF TAMPA	TRANSPORTATION	AND	STORMWATER	SERVICES		

CONTRACTOR CERTIFICATION

I CERTIFY UNDER PENALTY OF LAW THAT I UNDERSTAND, AND SHALL COMPLY WITH , THE TERMS AND CONDITIONS OF THE STATE OF FLORIDA GENERIC PERMIT FOR STORMWATER DISCHARGE FROM LARGE AND SMALL CONSTRUCTION ACTIVITIES AND THIS STORMWATER POLLUTION PREVENTION PLAN PREPARED THEREUNDER.

GENERAL CONTRACTOR NAME & TITLE	DATE
COMPANY NAME	
COMPANY STREET ADDRESS	
COMPANT STREET ADDRESS	
CITY, STATE, ZIP CODE	

R E V I S I O N S

DATE DESCRIPTION DATE DESCRIPTION

KISINGER CAMPO & ASSOCIATES CORP. 201 N FRANKLIN ST, SUITE 400, TAMPA, FL 33602 ENGINEER OF RECORD: CURT SPRUNGER, P.E. NO: 66524 CITY OF TAMPA
MOBILITY DEPARTMENT

ROAD NO

COUNTY PROJECT DESIGN NO.

HILLSBOROUGH 21-C-00022

STORMWATER POLLUTION PREVENTION PLAN (2) SHEET NO.

23

Christian Tabares 8/2/2023 3:53:33 PM

TEMPORARY TRAFFIC CONTROL PLAN NOTES

- THE SUPERVISOR OR FOREMAN CONTROLLING THE WORK ON THE PROJECT MUST HAVE A WORK ZONE TRAFFIC CONTROL SAFETY CERTIFICATION OR TRAFFIC SUPERVISOR CERTIFICATION FROM THE FLORIDA DEPARTMENT OF TRANSPORTATION. THE CERTIFIED SUPERVISOR SHALL BE ON THE PROJECT SITE AT ALL TIMES DURING CONSTRUCTION ACTIVITIES.
- ALL EXISTING WARNING, GUIDE, AND REGULATORY SIGNS SHALL BE MAINTAINED AT ALL TIMES. SIGNS SHALL BE RELOCATED. REMOVED, OR COVERED FOR EACH TRAFFIC PATTERN PHASE, AS APPROVED BY THE ENGINEER.
- ALL LANE TAPERS AND MAINTAINED LANE LINES ADJACENT TO CONSTRUCTION AREAS SHALL BE DELINEATED WITH TYPE I OR II BARRICADES, VERTICAL PANELS, TEMPORARY DRUMS OR TEMPORARY LOW PROFILE BARRIER AS APPROVED BY THE ENGINEER.
- 4. THE EXISTING SPEED LIMIT SHALL BE MAINTAINED AT ALL TIMES, UNLESS OTHERWISE NOTED IN THE PLANS.
- 5. THE CONTRACTOR SHALL NOTIFY THE ENGINEER A MINIMUM OF 7 DAYS IN ADVANCE OF ANY LANE CLOSURES.
- AT THE DISCRETION OF THE THE ENGINEER. ANY TEMPORARY LANE CLOSURE CAUSING EXTENDED TRAFFIC CONGESTION (5 MINUTE DELAY) SHALL BE OPENED UNTIL TRAFFIC HAS RETURNED TO AN ACCEPTABLE FLOW AS DETERMINED BY THE ENGINEER.
- PROVIDE A TEMPORARY TRAFFIC CONTROL PLAN, PREPARED BY A FDOT ADVANCED TRAFFIC CONTROL CERTIFIED PROFESSIONAL.
- THE CITY OF TAMPA PARKING DIVISION SHALL BE NOTIFIED A MINIMUM OF 7 DAYS IN ADVANCE OF ANY PARKING SPACE CLOSURE. PHONE: (813) 274-8179
- 9. THE HILLSBOROUGH AREA REGIONAL TRANSIT AUTHORITY (HART) PROJECT MANAGER SHALL BE NOTIFIED A MINIMUM OF 7 DAYS IN ADVANCE OF PERFORMING ANY LANE CLOSURE OR DETOUR AS WELL AS ANY WORK AFFECTING HART BUS STOPS. PHONE: (813) 384-6438 EMAIL: RODRIGUEZD@GOHART.ORG
- 10. THE UNIVERSITY OF TAMPA SENIOR PROJECT MANAGER FOR DESIGN AND CONSTRUCTION SERVICES SHALL BE CONTACTED FOR CONSTRUCTION COORDINATION OF THE UNIVERSITY OF TAMPA ACCESS POINTS.
- 11. PORTABLE CHANGEABLE (VARIABLE) MESSAGE SIGNS (PCMS) SHALL BE PLACED 500 FT. IN ADVANCE OF THE WORK ZONE FOR A PERIOD OF SEVEN DAYS PRIOR TO THE FIRST DAY OF ROADWAY CONSTRUCTION. MESSAGES SHOULD READ:

MESSAGE 2 MESSAGE 1 NUCCIO **BEGINS** PKWYBEGIN DATE CONST MESSAGE 1 MESSAGE 2 E 12TH REGINS AV E BEGIN DATE CONST MESSAGE 1 MESSAGE 2 N 15TH BEGINS BEGIN DATE CONST

TWO WEEKS PRIOR TO WEEKDAY LANE CLOSURES, THE MESSAGE FOR THE PCMS SHALL READ (UNLESS OTHERWISE DIRECTED BY THE ENGINEER):

DESCRIPTION

MESSAGE 1

EXPECT LANE CLOSURE

REVISIONS

DESCRIPTION

DATE

TWO WEEKS PRIOR TO WEEKEND LANE CLOSURES, THE MESSAGE FOR THE PCMS SHALL READ (UNLESS OTHERWISE DIRECTED BY THE ENGINEER):

MESSAGE 1

MESSAGE 2

WEEKEND IANE CLOSURE

FRI PM MON AM

PHASE I NOTES:

THE INTENT OF THIS PHASE IS TO CONSTRUCT DRAINAGE, SIGNALIZATION AND ROADSIDE IMPROVEMENTS ALONG N 15TH

- PLACE ADVANCE WARNING TRAFFIC CONTROL DEVICES AS SHOWN IN THE ADVANCED WARNING LAYOUT DETAIL AND AS SHOWN IN STANDARD PLANS FOR ROAD CONSTRUCTION (102 SERIES).
- 2. USE STANDARD PLANS 102-613, 102-615, 102-660 TO CONSTRUCT THE PROPOSED DRAINAGE, CURB, SIDEWALK, DRIVEWAYS AND SIGNALIZATION. EXCEPT THE PROPOSED CYCLE TRACK SEPARATOR AND BICYCLE SIGNALS TO BE PLACED ON THE SEPARATOR.

PHASE II NOTES:

THE INTENT OF THIS PHASE IS TO MILL AND RESURFACE THE ROADWAY AND CONSTRUCT THE CYCLE TRACK SEPARATOR.

- 1. USE STANDARD PLANS 102-613, 102-615, 102-620, 102-625 AND 102-628 TO MILL AND RESURFACE THE PAVEMENT BETWEEN THE NORTHERN CURB LINE AND THE NORTHERN EDGE OF THE PROPOSED CYCLE TRACK SEPARATOR, THE PAVING OPERATION SHALL BE PERFORMED PER THE FINAL LANE CONFIGURATION. LEVEL THE JOINTS BETWEEN ALL UNMILLED PAVEMENT AND THE RESURFACED PAVEMENT TO ELIMINATE THE DIFFERENCE IN ELEVATION.
- 2. PLACE TEMPORARY LANE PAVEMENT MARKINGS IN THE EXISTING CONFIGURATION. PLACE CROSSWALK AND STOP BAR MARKINGS IN THE FINAL CONFIGURATION.

PERFORM THE FOLLOWING WORK IN TWO-BLOCK SEGMENTS AT A TIME:

- 3. PERMANENTLY CLOSE THE EXISTING OUTSIDE TRAVEL LANE AND ADJACENT PARKING LANE. PLACE TEMPORARY 6" WHITE PAVEMENT MARKINGS ALONG THE NORTHERN EDGE OF THE EXISTING CENTER LANE.
- 4. USE STANDARD PLANS 102-613, 102-615, 102-620, 102-625 AND 102-628 TO MILL THE PAVEMENT BETWEEN THE SOUTHERN CURB LINE AND THE EDGE OF THE PROPOSED CYCLE TRACK SEPARATOR. LEVEL THE JOINTS BETWEEN ALL UNMILLED PAVEMENT AND THE RESURFACED PAVEMENT TO ELIMINATE THE DIFFERENCE IN ELEVATION.
- 5. USE STANDARD PLAN 102-613 TO SAW CUT AND REMOVE THE EXISTING PAVEMENT AND ANY BRICK BASE IN THE AREA OF THE CYCLE TRACK SEPARATOR. CONSTRUCT THE PROPOSED SEPARATOR CURB LINE AND PLACE THE PROPOSED BICYCLE SIGNAL HEADS UNTIL THE CYCLE TRACK OPENS.
- 6. RESURFACE THE MILLED PAVEMENT USING STANDARD PLANS 102-613, 102-615, 102-620 AND 102-625.
- 7. PLACE TEMPORARY CROSSWALK AND STOP BAR PAVEMENT MARKINGS IN THE FINAL CONFIGURATION
- 8. PLACE FINAL PAVEMENT MARKINGS (THERMO).

KISINGER CAMPO & ASSOCIATES CORP.

201 N FRANKLIN ST, SUITE 400,

TAMPA, FL 33602

ENGINEER OF RECORD FATHY ABDALLA, P.E. NO: 63914

- 9. UNCOVER BICYCLE SIGNAL HEADS AND SHIFT BICYCLE TRAFFIC TO CYCLE TRACK.
- 10. UPON COMPLETION OF ALL OTHER CONSTRUCTION, REMOVE EXISTING PAVEMENT MARKINGS AS CALLED OUT ON PLANS AND INSTALL FINAL PAVEMENT MARKINGS AND SIGNS AND REMOVE TEMPORARY TRAFFIC CONTROL DEVICES.


CITY OF TAMPA MOBILITY DEPARTMENT PROJECT DESIGN NO. ROAD NO COUNTY HILLSBOROUGH 21-C-00022

TRAFFIC CONTROL PLAN - (1)

SHEET

24

Christian Tabares 8/2/2023 3:53:41 PM

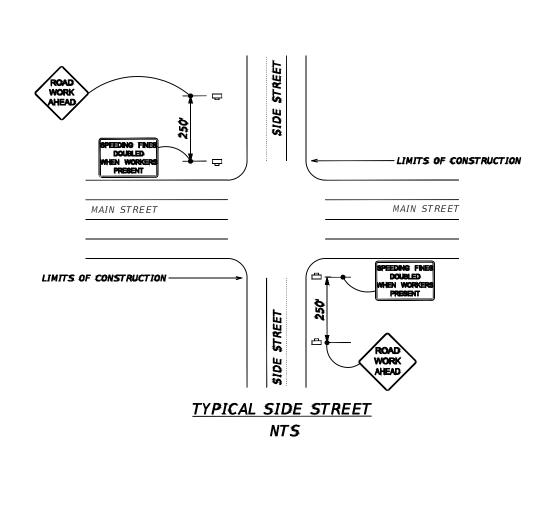

→ LANE IDENTIFICATION AND DIRECTION OF TRAFFIC

₩ORK ZONE SIGN


PORTABLE CHANGEABLE (VARIABLE) MESSAGE SIGNS SIGNS (SEE TTC GENERAL NOTES FOR MORE INFORMATION)


R E V I S I O N S			CITY OF TAMPA					
DATE	DESCRIPTION	DATE	DESCRIPTION	KISINGER CAMPO & ASSOCIATES CORP. 201 N FRANKLIN ST, SUITE 400,		MOBILITY DEPARTMENT		
				TAMPA, FL 33602 ENGINEER OF RECORD:	ROAD NO.	COUNTY	PROJECT DESIGN NO.	
				FATHY ABDALLA, P.E. NO: 63914		HILLSBOROUGH	21-C-00022	


TRAFFIC CONTROL PLAN - (2)

SHEET NO.

Christian Tabares 8/2/2023 4:11:36 PM

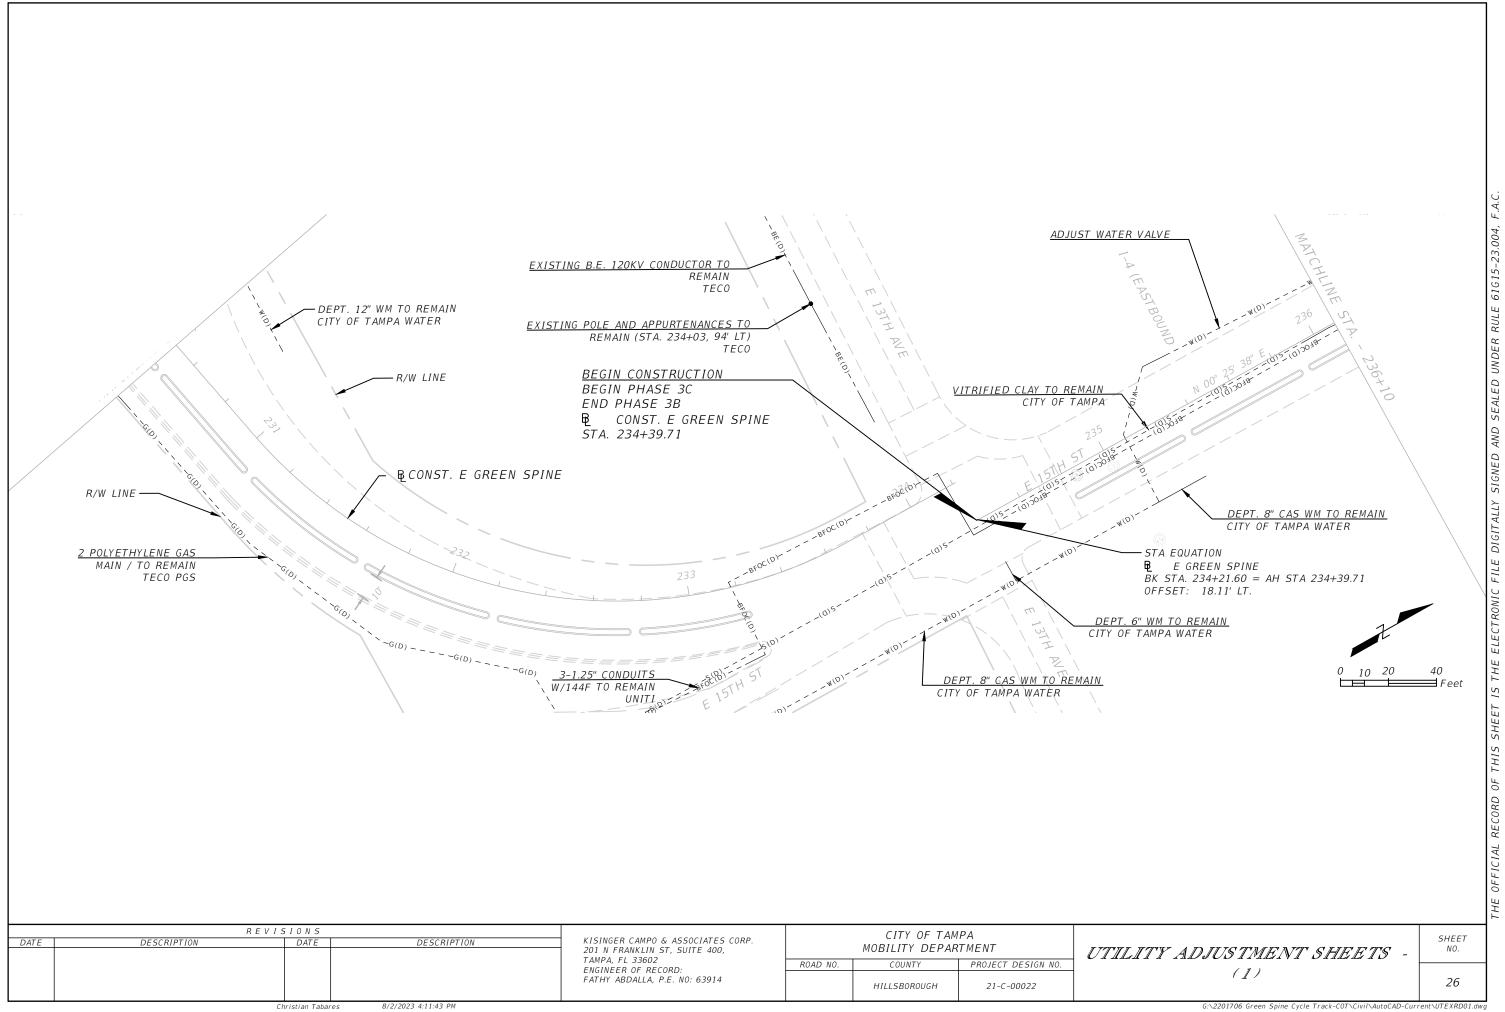

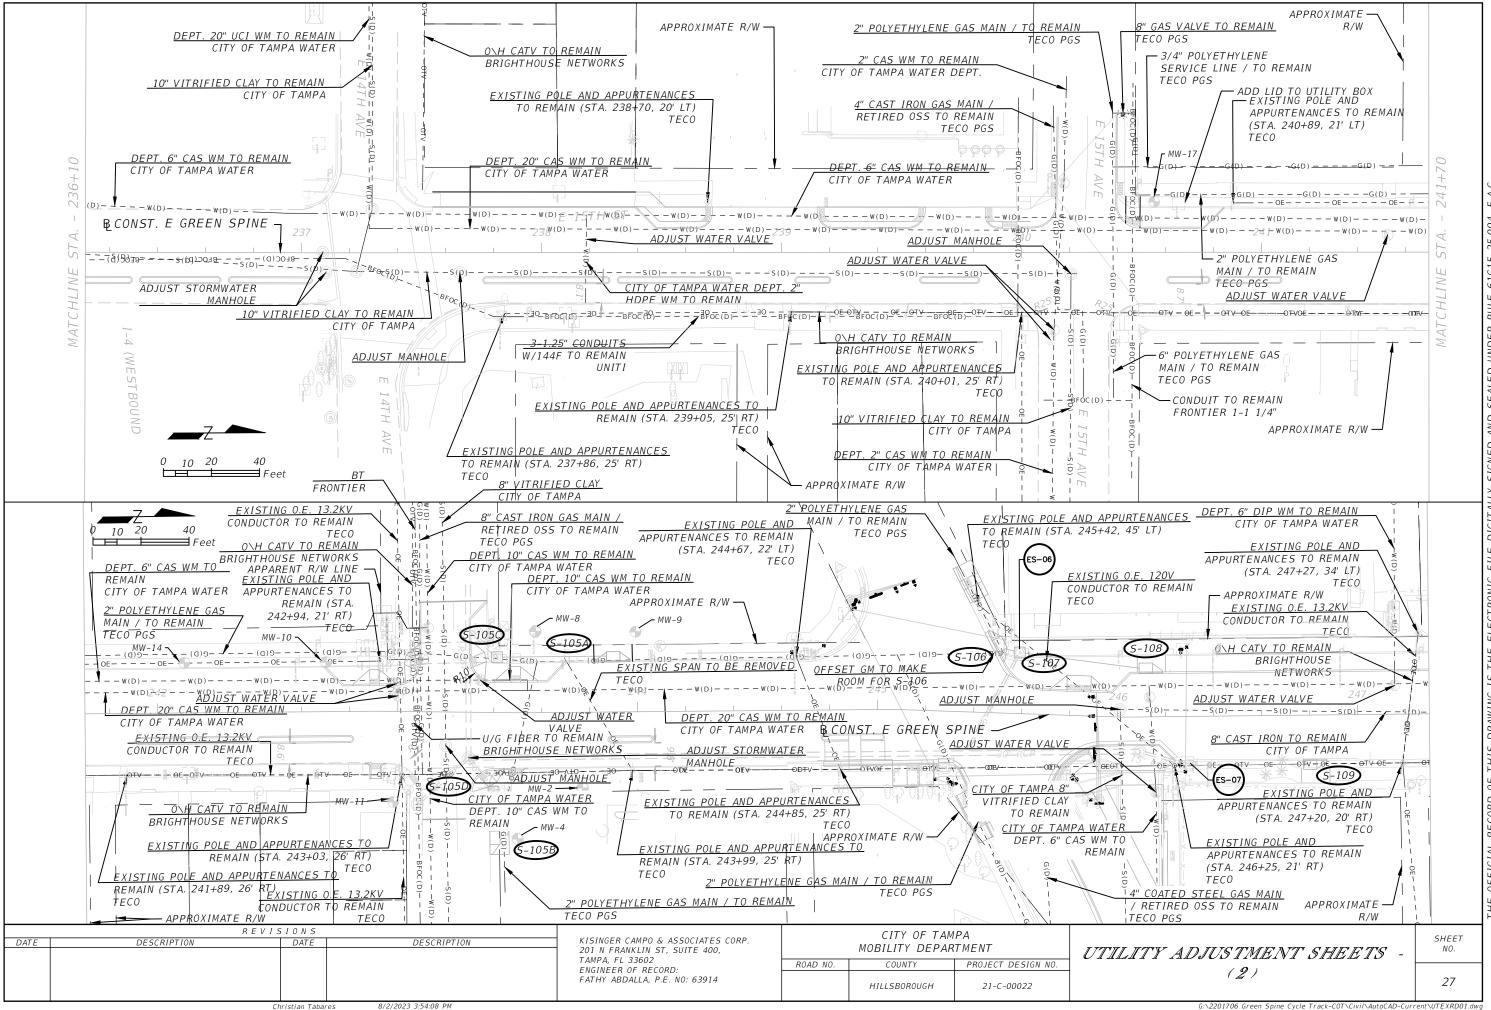

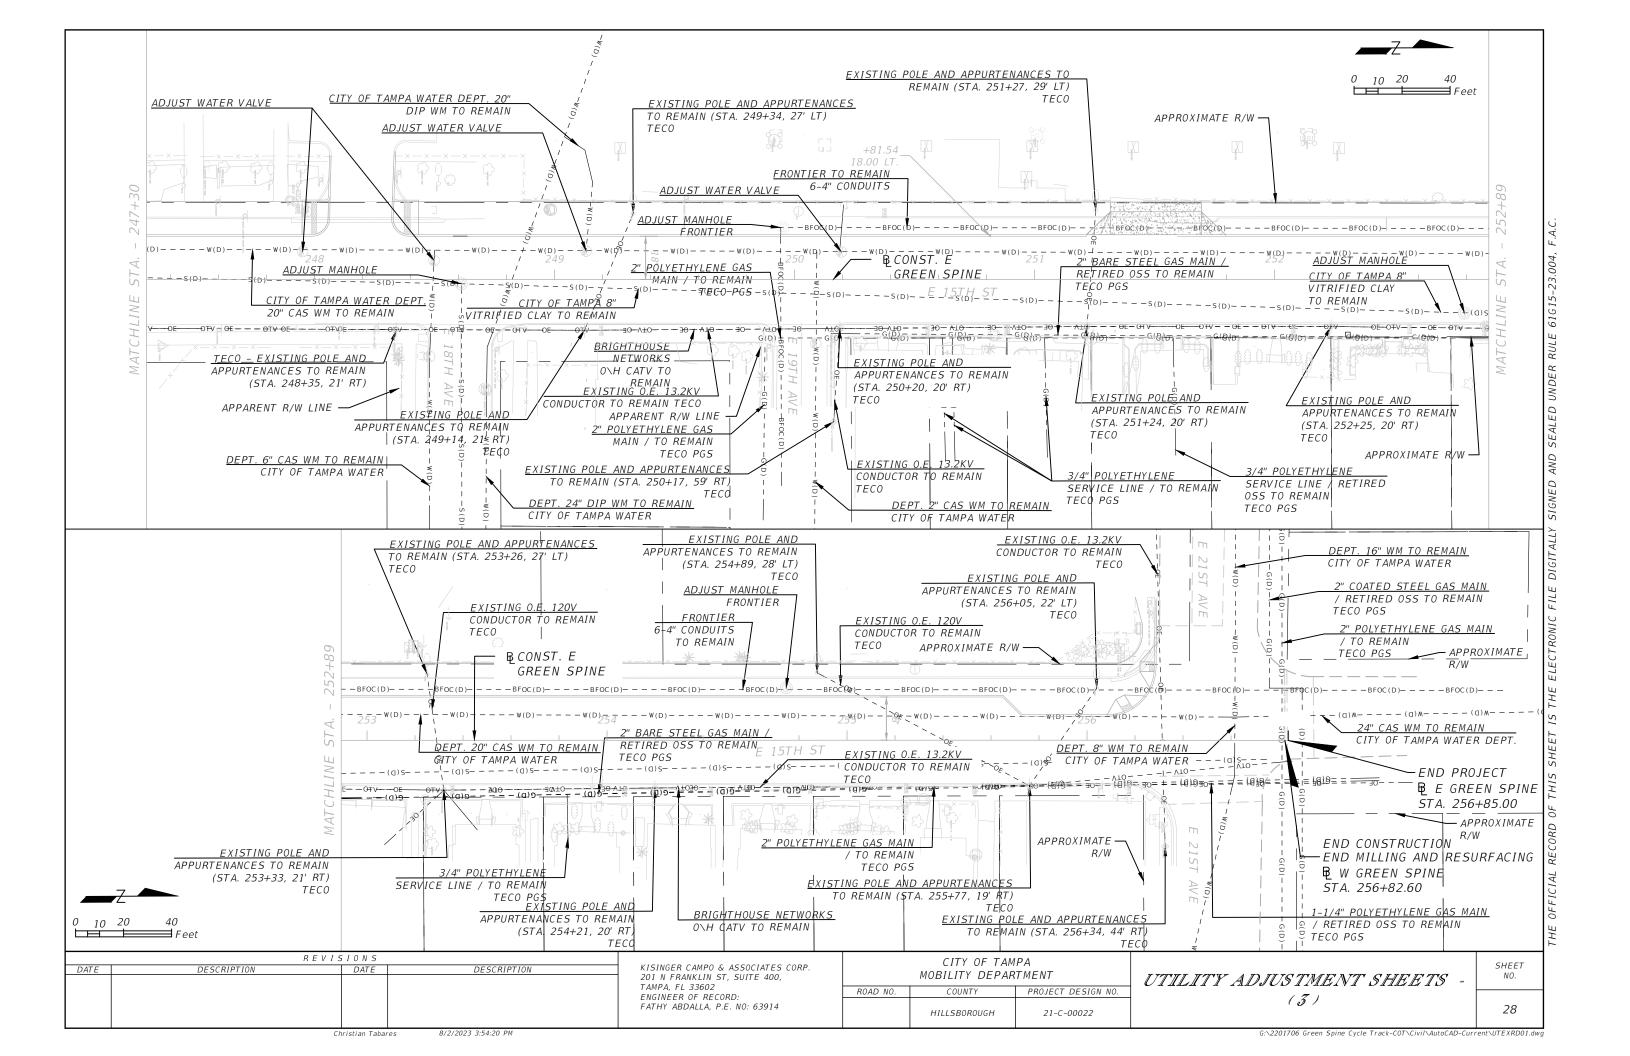

	SUMMARY	OF LU	JMP S	SUM ITEMS	
PAY ITEM NO.	PAY ITEM DESCRIPTION	QUAN P	ITITY F	- DESIGN NOTES	CONSTRUCTION REMARKS
0101 1	MOBILIZATION	1			
0102 1	MOBILIZATION OF TRAFFIC	1			
0110 1 1	CLEARING AND GRUBBING	1			

PAY ITEM NOTES

0526 1

CONTACT THE CITY OF TAMPA TRANSPORTATION DEPARTMENT TO COORDINATE USE OF BRICK PAVERS AVAILABLE WITHIN THE CITY'S STOCKYARD. IF THERE ARE NO AVAILABLE BRICK PAVERS FROM THE CITY'S STOCKYARD COMPLETE THE FOLLOWING PRIOR TO PURCHASING NEW BRICK PAVERS:

- OBTAIN SAMPLES OF BRICK PAVERS
- PROVIDE SAMPLES OF BRICK PAVERS TO THE CITY OF TAMPA TRANSPORTATION DEPARTMENT FOR THEIR APPROVAL AS PART OF THE SHOP DRAWING REVIEW PROCESS CONTRACT 19-C-00019 GREEN SPINE CYCLE TRACK FDOT LAP (PG. SP-46) AFTER THE CITY OF TAMPA TRANSPORTATION DEPARTMENT APPROVES THE BRICK PAVER SAMPLES, PROCEED WITH PURCHASE OF NEW PAVERS.

0527 2

ALL DETECTABLE WARNINGS ARE TO BE THE STANDARD ADA 'PLASTIC' MAT TRUNCATED DOMES (RED COLORED) ON CONCRETE ADA RAMPS. SUBMIT SAMPLE OF DETECTABLE WARNING MATERIAL WITH SHOP DRAWING TO THE CITY FOR APPROVAL PRIOR TO INSTALLATION).

520-7-

GRANITE CURB, RESET - INCLUDES COST OF LABOR AND MATERIALS REQUIRED FOR RESETTING THE CURB.

646-1-11

PAINT PEDESTAL, POLE AND BACK OF SIGN ASSEMBLIES BLACK (FEDERAL STANDARD NO. 17038). PAYMENT FOR PAINTING THESE ELEMENTS IS TO BE INCLUDED WITHIN THIS PAY ITEM.

700-1-50

PAINT POLE AND BACK OF SIGN ASSEMBLIES BLACK (FEDERAL STANDARD NO. 17038). PAYMENT FOR PAINTING THESE ELEMENTS IS TO BE INCLUDED WITHIN THIS PAY ITEM.

	R	EVISIONS		
DATE	DESCRIPTION	DATE	DESCRIPTION	

KISINGER CAMPO & ASSOCIATES CORP. 201 N FRANKLIN ST, SUITE 400, TAMPA, FL 33602 ENGINEER OF RECORD: FATHY ABDALLA, P.E. NO: 63914

MOBILITY DEPARTMENT

ROAD NO. COUNTY PROJECT DESIGN NO.

HILLSBOROUGH 21-C-00022

CITY OF TAMPA

SUMMARY OF QUANTITIES

G:\2201706 Green Spine Cycle Track-COT\Civil\AutoCAD-Current\SUMQRD01 3C.dwg

INDEX OF SUMMARY OF QUANTITIES

SUMMARY OF MISCELLANEOUS DRAINAGE ITEMS

SUMMARY OF UTILITY ADJUSTMENTS

SUMMARY OF PERFORMANCE TURF

SUMMARY OF SIDEWALK & DETECTABLE WARNINGS

SUMMARY OF EROSION AND SEDIMENT CONTROL DEVICES

SUMMARY OF CLEARING AND GRUBBING & REMOVAL ITEMS

SUMMARY OF CURB & GUTTER AND/OR TRAFFIC SEPARATORS

SHEET DESCRIPTION

SUMMARY OF EARTHWORK

SUMMARY OF PAVEMENT

SUMMARY OF LUMP SUM ITEMS

SHEET NO.

SQ-1

SQ-2

SQ-3

SQ-4

SQ-5

SQ-6,7

SQ-8,9

SQ-10

SHEET NO.

SQ1

Christian Tabares 8/2/2023 3:54:24 PM

HE DEFICIAL RECORD OF THIS SHEET IS THE ELECTRONIC FILE DIGITALLY SIGNED AND

LOCAT I	ON			ICIAL RINGS	SEDIN BARR		PREVE	RACKING INTION ICE		LET CCTION STEM	DECTOR	CONSTRUCTION	
		SIDE	010	14 1	0104 10 3 LF		0 3 0104 15 EA		0104 18 EA		DESIGN NOTES	CONSTRUCTION REMARKS	
STA. TO	STA.		5	Y							1		
				F	Р	F	Р	F	Р	F			
246+25.51 to	246+27.01	RT .				175.0							
234+64.39		LT.							1				
234+81.90		RT .							1				
237+42.09		LT.							1				
243+10.88		RT .							1				
243+37 .86		RT .							1				
243+91.99		LT.							1				
245+29 . 18		RT .							1				
245+46 . 53		LT.							1				
246+14.46		LT.							1				
246+28.74		RT .							1				
246+82.82		RT .							1				
256+27 . 17		RT .							1				
256+32.14		LT.							1				
	SU	B-TOTAL:			175.0				13				
		TOTAL:			175.0				13				

R E V I S I O N S												
DATE	DESCRIPTION	DATE	DESCRIPTION									

CITY OF TAMPA
MOBILITY DEPARTMENT

ROAD NO. COUNTY PROJECT DESIGN NO.

HILLSBOROUGH 21-C-00022

SUMMARY OF QUANTITIES

SHEET NO.

Christian Tabares 8/2/2023 3:54:25 PM

PAY ITEM NO.	PAY ITEM DESCRIPTION	LOCATION	SIDE	AREA ID	UNITS		RY UNITS (IF P SUM)	TOTAL		DESIGN NOTES CONSTRUCTION REMARKS
		STA. TO STA.	1			AREA (AC)	LENGTH (LF)	Р	F	
0110 4 10	REMOVAL OF EXIST. CONCRETE				SY			985.0		
		237+51.15 to 238+71.20	LT.		9					EXIST. CURB REMOVAL
		239+15.07 to 239+59.92	LT.		3					EXIST. CURB REMOVAL
		239+84.92 to 240+14.33	LT.		5					EXIST. CURB REMOVAL
		240+39.19 to 241+84.51	LT.		6					EXIST. CURB REMOVAL
		242+69.18 to 243+09.42	LT.		3					EXIST. CURB REMOVAL
		243+36.56 to 243+70.55	LT.		4					EXIST. CURB REMOVAL
		243+38.74 to 243+53.72	LT.		3					EXIST. CURB REMOVAL
		244+77.35 to 245+51.07	RT.		20					EXIST. CURB REMOVAL
		245+45.31 to 256+28.35	LT.		762					EXIST. SIDEWALK REMOVAL
		245+45.31 to 256+28.35	LT.		83					EXIST. CURB REMOVAL
		245+77.33 to 246+01.90	RT.		80					EXIST. ISLAND
		246+17.90 to 246+25.90	RT.		7					CURB RAMP REMOVAL

	SUMMARY OF EARTHWORK											
PAY ITEM NO. PAY ITEM DESCRIPTION CY DESIGN CONSTRUCTION												
FAI ITEM NO.	FAI IILM DESCRIFTION	Р	F	NOTES	REMARKS							
0120 6	EMBANKMENT	419.0										
	TOTAL	419.0										

NOTE: EARTHWORK HAS BEEN CALCULATED USING THE METHOD OF AVERAGE END AREA BASE OPTION.

	REVI	SIONS	
DATE	DESCRIPTION	DATE	DESCRIPTION

KISINGER CAMPO & ASSOCIATES CORP. 201 N FRANKLIN ST, SUITE 400, TAMPA, FL 33602 ENGINEER OF RECORD: FATHY ABDALLA, P.E. NO: 63914

CITY OF TAMPA MOBILITY DEPARTMENT ROAD NO. COUNTY PROJECT DESIGN NO. HILLSB0R0UGH 21-C-00022

SUMMARY OF QUANTITIES

SHEET NO.

8/2/2023 3:54:25 PM Christian Tabares

PAY ITEM		LOCATION STA. TO STA.			SIDE	AREA		QUAN	TITY	TOT	$^{\Gamma}AL$	DESIGN	CONSTRUCT I ON
NO.	PAY ITEM DESCRIPTION					ID	UNIT	Р	F	Р	F	NOTES	REMARKS
327 70 6	Milling Exist Asph Pavt, 1.5" Avg Depth	234+78.64	t o	237+12.52	LT./RT.		SY	868.0		9,288.0			
		237+54.18	t o	256+28.47	LT./RT.		SY	8,420.0					
0337 7 83	ASPHALT CONCRETE FRICTION COURSE, TRAFFIC C, FC-12.5, PG 76-22	234+78.64	t o	237+12.52	LT./RT.		TN	72.0		768.0		BUS STOP SLOPED PAVEMENT INCLUDED	
		237+54.18	t o	256+28.47	LT./RT.		TN	696.0					
0526 1A	Red Brick Pavers, Furnish and Install	234+82.00	t o	235+31.00	RT .		SY	11.3		115.0			
		235+37.00	t o	235+87.00	RT.		SY	11.5					
		235+93.00	t o	236+28.00	RT .		SY	8.5					
		236+34.00	t o	236+65.00	RT .		SY	7.5					
		236+71.00	t o	237+03.00	RT.		SY	7.5					
		237+77.00	t o	238+27.00	RT.		SY	11.5					
		238+33.00	t o	238+78.00	RT.		SY	10.5					
		239+07.00	t o	239+19.00	RT.		SY	3.5					
		239+59.00	t o	239+81.00	RT .		SY	5.3					
		240+62.00	t o	240+77.00	RT.		SY	3.7					
		240+83.00	t o	241+07.00	RT .		SY	5.8					
		241+92.00	to	242+37.00	RT.		SY	10.4					
		242+43.00	t o	242+80.00	RT.		SY	8.4					
		243+89.00	t o	244+05.00	RT .		SY	4.0					
		244+77 . 85	t o	245+01.23	RT.		SY	5.6					

	REVISIONS												
DATE	DESCRIPTION	DATE	DESCRIPTION										

CITY OF TAMPA
MOBILITY DEPARTMENT

ROAD NO. COUNTY PROJECT DESIGN NO.

HILLSBOROUGH 21-C-00022

SUMMARY OF QUANTITIES

SHEET NO.

SQ4

Christian Tabares 8/2/2023 3:54:25 PM

	SUMMARY OF MISCELLANEOUS DRAINAGE ITEMS												
PAY ITEM	PAY ITEM DESCRIPTION	LOCATION		UNIT			NTITY TOT		DESIGN	CONSTRUCTION			
NO.	NO.				Р	F	P F		NOTES	REMARKS			
435 - 100 - 2	INLET SPECIAL DRAINAGE GRATE	238+60.00	RT .	LF	32.7		181.4						
435 - 100 - 2	INLET SPECIAL DRAINAGE GRATE	239+40.00	LT.	LF	44.8								
435 - 100 - 2	INLET SPECIAL DRAINAGE GRATE	240+00.00	LT.	LF	29.2								
435 - 100 - 2	INLET SPECIAL DRAINAGE GRATE	240+60.00	LT.	LF	45.3								
435 - 100 - 2	INLET SPECIAL DRAINAGE GRATE	244+90.35	RT .	LF	29.4								

	REVIS	5 I O N S	
DATE	DESCRIPTION	DATE	DESCRIPTION
		rictian Taha	ros 8/2/2023 3:54:26 PM

CITY OF TAMPA
MOBILITY DEPARTMENT

ROAD NO. COUNTY PROJECT DESIGN NO.

HILLSBOROUGH 21-C-00022

SUMMARY OF QUANTITIES

SHEET NO.

SQ5

				EPARA	TORS										
PAY		LOG	CAT	ION	SIDE			(QUANT ITY			ТО	ΓΔΙ	DECICN	CONCTRUCTION
ITEM NO.	PAY ITEM DESCRIPTION	STA.	STA. TO STA.			UNIT	GROSS LENGTH		CTIONS	NET L	ENGTH			DESIGN NOTES	CONSTRUCTION REMARKS
							LLINGTII	TYPE	LENGTH	Р	F	P	F		
0520 1 10	Concrete Curb & Gutter, Type F	244+77.35	to	245+51.34	RT .	LF	74.0			95.0		325.0			
		246+16.27	t o	246+24.79	RT .	LF	8.5			230.0					
0520 2 4	Concrete Curb & Gutter, Type D	234+80.00	to	235+87.00	RT .	LF	108.0			108.0		2410.0			
		235+37.00	to	235+87.00	RT.	LF	110.0			110.0					
		235+93.00	to	236+28.00	RT.	LF	80.0			80.0					
		236+34.00	to	236+65.00	RT.	LF	72.0			72.0					
		236+71.00	to	237+03.00	RT.	LF	74.0			74.0					
		237+77.00	to	238+27.00	RT.	LF	110.0			110.0					
		238+33.00	to	238+78.00	RT .	LF	100.0			100.0					
		238+67.45	to	238+71.20	LT.	LF	3.7			11.0					
		239+07.00	to	239+19.00	RT .	LF	34.0			34.0					
		239+15.07	to	239+18.80	LT.	LF	3.7			10.0					
		239+55.73	to	239+59.92	LT.	LF	4.2			11.0					
		239+59.00	to	239+81.00	RT .	LF	54.0			54.0					
		239+84.92	to	240+00.94	RT .	LF	16.0			23.0					
		240+39.19	to	240+52.73	LT.	LF	13.6			32.0					
		240+62.00	to	240+77.00	RT.	LF	40.0			40.0					
		240+83.00	to	241+07.00	RT.	LF	58.0			58.0					
		241+92.00	to	242+37.00	RT.	LF	100.0			100.0					
		242+43.00	to	242+80.00	RT.	LF	84.0			84.0					
		242+69.18	to	243+09.42	LT.	LF	58.0			58.0					
		243+36.56	to	243+70.55	LT.	LF	77.0			77.0					
		243+38.74	to	243+53.72	RT .	LF	15.0			44.0					
		243+89.00	to	244+05.00	RT .	LF	42.0			42.0					
		244+74.85	to	245+06.74	RT .	LF	32.0			32.0					
		244+77.85	to	245+01.23	RT .	LF	57.0			57.0					
		245+56.78	to	248+06.89	LT.	LF	251.0			251.0					
		248+33.13	to	251+21.53	LT.	LF	289.0			289.0					
		251+79.53	to	256+27.78	LT.	LF	449.0			449.0					

	REVISIONS												
DATE	DESCRIPTION	DATE	DESCRIPTION										

CITY OF TAMPA
MOBILITY DEPARTMENT

ROAD NO. COUNTY PROJECT DESIGN NO.

HILLSBOROUGH 21-C-00022

SUMMARY OF QUANTITIES

SHEET NO.

*5*Q6

Christian Tabares 8/2/2023 3:54:26 PM

		_	SU	1MAR)	Y OF	CURB 8	§ GUTTE	R AND,	OR TRAI	FFIC SI	EPARAT	ORS			_
PAY		LOCATION						(QUANT ITY			T.0.T			
ITEM NO.	PAY ITEM DESCRIPTION	STA. TO STA.			SIDE	UNIT	GROSS	DEDU	CTIONS	NET LE	ENGTH	TOTAL		DESIGN NOTES	CONSTRUCTION REMARKS
		3771.	, 6 3, 71.				LENGTH	TYPE	LENGTH	Р	F	Р	P F		
0520 7 1	Granite Curb, Furnish and Install	237+57.79	to 238+67	. 45	LT.	LF	110.0			110.0		193.0			
		239+18.80	t o 239+55	.73	LT.	LF	37.0			37.0					
		240+00.94 to 240+14.33		. 33	LT.	LF	14.0			14.0					
		240+52.73	to 240+84	. 51	LT .	LF	32.0			32.0					
0520 7 2	Granite Curb, Reset	237+57.79	to 238+38	. 53	LT.	LF	81.0			81.0		235.0			
		238+38.53	to 238+71	. 20	LT.	LF	33.0			33.0					
		239+15.07	to 239+59	. 92	LT.	LF	45.0			45.0					
		239+84.92	to 240+14	. 33	LT.	LF	30.0			30.0					
		240+39.19	to 240+84	. 51	LT.	LF	46.0			46.0					

	REVIS	5 I O N S	
DATE	DESCRIPTION	DATE	DESCRIPTION

CITY OF TAMPA
MOBILITY DEPARTMENT

ROAD NO. COUNTY PROJECT DESIGN NO.

HILLSBOROUGH 21-C-00022

SUMMARY OF QUANTITIES

SHEET NO.

Christian Tabares 8/2/2023 3:54:26 PM

				Sl	JMMARY (OF SIDEWA	ALK & PA	WERS,	ARCHITE	CTURAL, ROADWAY	
LOCAT	I ON			CONC SI		CONC SIL			CTABLE IINGS		
		SIDE	AREA	0522	1	0522	2	052	7 2	DESIGN	CONSTRUCT I ON
			ID	SY	,	SY.	,	9	SF	NOTES	REMARKS
STA. TO	STA.			Р	F	Р	F	Р	F		
237+57.79 to	238+71.20	LT.		79.0							
239+15.07 to	239+59.92	LT.		20.0							
239+84.92 to	240+14.33	LT.		9.0							
240+42.23 to	240+49.23	LT.		9.0							
242+69.18 to	243+09.42	LT.		31.0							
242+88.15 to	242+93.70	LT.		4.0							
243+29.33 to	243+70.50	LT.		43.0							
243+38.74 to	243+52.42	LT.		33.0							
245+79.49 to	246+19.96	LT.		61.0							
245+06.74 to	245+23.86	LT.		16.0							
245+33.72 to	243+51.34	LT.		20.0							
245+29.51 to	245+44.46	LT.		15.0							
245+79.49 to	245+79.49	LT.				15.0					
245+45.07 to		LT.				421.45					
248+33.13 to	256+30.35	LT.				1,259.0					
238+71.00		LT.						8.3			
239+15.30		LT.						9.3			
239+59.80		LT.						9.6			
239+85.00		LT.						9.0			
239+90.50		LT.						12.0			
240+14.00		LT.						11.7			
240+39+50		LT.						10.5			
240+49.00		LT.						13.2			
242+91.00		LT.						8.0			
242+91.00		RT .						8.3			
243+07.00		RT .						8.0			
243+07.00		LT.						8.0			
243+29.50		RT .						8.3			
243+53.00		LT.						8.0			
243+53.00		LT.						10.0			
243+28.50		RT .						20.0			
243+51.00		RT .						8.0			
			SUB-TOTAL:	340.0		1,696.0		187.1			
			TOTAL:	340.0		1,696.0		357.0			

CITY OF TAMPA MOBILITY DEPARTMENT

PROJECT DESIGN NO.

21-C-00022

COUNTY

HILLSB0R0UGH

ROAD NO.

Christian Tabares 8/2/2023 3:54:26 PM

<u>DESCRIP</u>TION

REVISIONS

DATE

DESCRIPTION

DATE

SUMMARY OF QUANTITIES

SHEET NO.

SQ8

				S	UMMARY	OF SIDE	VALK & PA	AVERS, A	RCHITEC	TURAL, ROADWAY	
LOC	AT I ON			CONC 51			IDEWALK 5"	DETEC WARN			
		SIDE	AREA	0522	2 1	052	2 2	0527	2	DESIGN	CONSTRUCTION
CT A	TO CTA		ID	S	Υ	9	5Y	S	F	NOTES	REMARKS
SIA.	TO STA.			Р	F	Р	F	Р	F		
245+10.00		RT .						8.0			
245+43.00		RT .						20.0			
245+80.00		RT.						48.3			
245+85.00		LT.						27.3			
245+36.00		LT.						34.3			
248+00.00		LT.						8.0			
248+40.00		LT.						8.0			
256+17.00		LT.						8.0			
256+27.00		LT.						8.0			
-	SUB-TOTAL:							170.0			
			TOTAL:					357.0			

	REVIS	5 I O N S	
DATE	DESCRIPTION	DATE	DESCRIPTION

CITY OF TAMPA MOBILITY DEPARTMENT ROAD NO. COUNTY PROJECT DESIGN NO. HILLSB0R0UGH 21-C-00022

SUMMARY OF QUANTITIES

SHEET NO.

			SUMI	MARY OF	UTIL	LITY	ADJUS	STMEN	ΤS	
PAY ITEM	PAY ITEM DESCRIPTION	LOCATION	SIDE	UNIT	QUAN	IT ITY	TO	TAL	DESIGN	CONSTRUCTION
NO.		STA.			Р	F	Р	F	NOTES	REMARKS
425 - 5	MANHOLE, ADJUST	137+08.79	BL	EA	1		8			
425 - 5	MANHOLE, ADJUST	137+10.00	RT	EA	1					
425 - 5	MANHOLE, ADJUST	240+20.56	RT	EA	1					
425 - 5	MANHOLE, ADJUST	243+20.42	RT	EA	1					
425 - 5	MANHOLE, ADJUST	243+29.70	RT	EA	1					
425 - 5	MANHOLE, ADJUST	246+01.26	LT	EA	1					
425 - 5	MANHOLE, ADJUST	248+61.11	RT	EA	1					
425-5	MANHOLE, ADJUST	252+79.32	RT	EA	1					
9910	ADJUST VALVE BOX (HEIGHT)	PROJECT LIMITS	LT./RT.	EA	15		15			

							SU	IMMARY (OF PERF	ORMANCE	TURF	
LOCATION		ON			(LF)	LF)	PERFORMANCE TURF (SOD)		PLAS EROSIO	STIC ON MAT		
		SIDE	AREA	H) НТОІМ	0570	0570 1 2		1 11	DESIGN	CONSTRUCTION	
STA. TO STA.		CTA		I D		LENGT	SY		SY		NOTES	REMARKS
SIA.	IU SIA.						Р	F	Р	F		
238+38.53	to	238+71.20	LT.				9.0					
239+16.70	to	239+57.74	LT.				11.0					
239+86.22	to	239+91.97	LT.				2.0					
239+97.97	to	240+10.79	LT.				3.0					
246+18.16	to	246+23.51	RT.				407.0					
					S	UB-TOTAL:	432.0					
		·		·		TOTAL:	432.0					·

	REVIS	5 I O N S	
DATE	DESCRIPTION	DATE	DESCRIPTION

CITY OF TAMPA
MOBILITY DEPARTMENT

ROAD NO. COUNTY PROJECT DESIGN NO.

HILLSBOROUGH 21-C-00022

SUMMARY OF QUANTITIES

SHEET NO.

Christian Tabares 8/2/2023 3:54:27 PM

CITY OF TAMPA MOBILITY DEPARTMENT

CONTRACT PLANS

FINANCIAL PROJECT ID 439476-4-58-02

INDEX OF LANDSCAPE PLANS

SHEET NO. SHEET DESCRIPTION

LD-1 KEY SHEET

LD-2 SUMMARY OF PAY ITEMS

TABULATION OF QUANTITIES AND PLANT SCHEDULE LD-3

LD-4 TECHNICAL MAINTENANCE PLAN

LD-5 PROJECT LAYOUT

LD-6 GENERAL NOTES

LD-7 TO LD-8 HARDSCAPE PLANS


LD-9 TO LD-12 HARDSCAPE DETAILS


LD-13 TO LD-14 PLANTING PLANS

LD-15 TO LD-18 PLANTING DETAILS

E/W GREEN SPINE CYCLE TRACK -PH. 3C FROM 13TH AVE. TO 21ST. AVE.

LANDSCAPING PLANS

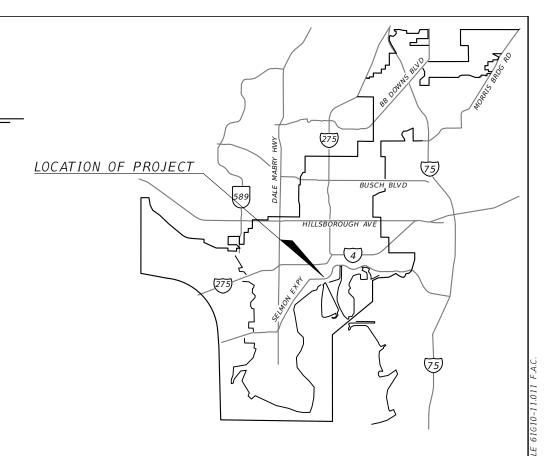

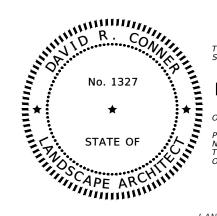

FINAL SUBMITTAL

February 2023

THIS ITEM HAS BEEN DIGITALLY SIGNED AND SEALED BY:

David R Conner Date: 2023.02.07 09:53:10-05'00'

ON THE DATE ADJACENT TO THE SEAL

LANDSCAPE ARCHITECT OF RECORD:

PRINTED COPIES OF THIS DOCUMENT ARE NOT CONSIDERED SIGNED AND SEALED, AND THE SIGNATURE MUST BE VERIFIED ON ANY ELECTRONIC COPIES.

R.L.A. NO.: 1327

DAVID CONNER

DAVID CONNER + ASSOCIATES

LANDSCAPE PLANS

100 EAST MADISON STREET, STE 200 TAMPA, FL, 33602

813-258-1997

CONTRACT NO.: 21-C-00022

VENDOR NO.: 59-3421586

CERTIFICATE OF AUTHORIZATION NO.: LC0000319

CITY OF TAMPA PROJECT MANAGER:

NINA S. MABILLEAU E.I.

CONSTRUCTION CONTRACT NO.	FISCAL YEAR	SHEET NO.	
21-C-00022	23	LD-1	

15TH ST FROM 13TH AVE TO 21ST AVE

PAY ITEM NO.	DESCRIPTION	UNIT	FINAL
520-2-4	CONCRETE CURB, TYPE D	LF	160
580-1-1	LANDSCAPE COMPLETE (SMALL PLANTS)	LS	1
580-1-2	LANDSCAPE COMPLETE (LARGE PLANTS)	LS	1
COT-101	PAVERS, ARCHITECTURAL, SIDEWALK	SY	87
COT-102	PRE-EMERGENT HERBICIDE	SY	142
COT-103	FURNISHINGS	LS	1

PERFORMANCE TURF IS INCLUDED AND PAID FOR IN THE ROADWAY PLANS PAY ITEMS.

	REVI	SIONS		DAVID R. CONNER, RLA		CITY OF TAM	ΙΡΔ
DATE		LA0001327 DAVID CONNER + ASSOCIATES		MOBILITY DEPAR			
		100 E. MADISON ST, SUITE 200	ROAD NO.	COUNTY	PROJECT DESIGN NO		
				TAMPA, FL 33602 CERT. OF AUTHORIZATION LC0000319		HILLSBOROUGH	21-C-00022

SUMMARY OF PAY ITEMS

SHEET NO.

LD-2

nd 2/6/2023 5:15:59 PM

. RECORD OF THIS SHEET IS THE ELECTRONIC FILE DIGITALLY SIGNED AND S

LANDSCAPE TABULATION OF QUANTITIES / PLANT SCHEDULE

15TH ST FROM 13TH AVE TO 21ST AVE

PAY ITEM	CVIII	DOT ANAGAL NAME	COMMON NAME	INSTALLED	MAXIMUM	CDACING	DEMARKS	.,,,,,=		SHEET	NUMBER			TOTAL THIS		RAND OT AL
NO .	SYM	BOTANICAL NAME	COMMON NAME	SIZE	MAINTAINED SIZE	SPACING	REMARKS	UNIT	LD-7 /	LD - 13	LD-8 ,	/ LD-14	SH	EET	'0	IAL
									PLAN	FINAL	PLAN	FINAL	PLAN	FINAL	PLAN	FINA
520 - 2 - 4		CONCRETE CURB, TYPE D						LF	144		16		160		160	
		LANDSCARE COMPLETE (SMALL PLANTS)														
580 - 1 - 1	ZAM DIIM	LANDSCAPE COMPLETE (SMALL PLANTS) ZAMIA PUMILA	COONT I E	3 GALLON	18" Ht.	36 O.C.		LS EA	138		17		1 155		1	
	ZAM TOM	ZAMTA TOMTLA	COONTIL	J GALLON	10 110.	30 0.0.		LA	130		17		133			
580 - 1 - 2		LANDSCAPE COMPLETE (LARGE PLANTS)						L S					1		1	
	SAB PAL	SABAL PALMETTO	SABAL PALM	B&B			14' CT. HT.; MAINTAIN A MIN 8' VERTICAL CLEARANCE OVER SIDEWALKS; REGENERATED ROOT	EA	3		2		5			
	QUE CAT	QUERCUS VIRGINIANA 'CATHEDRAL'	CATHERDAL LIVE OAK	B&B			6 CAL; 20' HT X 10' SP; RPG TREES WITH SPREADING CHARACTER AND MINIMAL INTERAL GROWTH. NO TIP PRUNING. NO OPEN WOUNDS. 7' CLEAR TRUNK	EA	3				3			
		PREPARED SOIL LAYER						5Y	126		16		142			
		BIO BARRIER						LF	68				68			
COT - 101		PAVERS, ARCHITECTURAL, SIDEWALK						SY	69		18		87		87	
COT - 102		PRE-EMERGENT HERBICIDE						SY	126		16		142		142	
COT - 103		FURNISHINGS						L S							1	
		BENCH							1		1		2			
		BICYCLE RACK							2				2			
		BIKE MAINTENANCE STATION							1				1			
		LITTER RECEPTACLE							1		1		2			
		PASPALUM NOTATUM 'ARGENTINE'	BAHAI GRASS	SOD			PERFORMANCE TURF IS PROV PERFORMANCE TURF QUANTIT							MS .		tennas danamatahahahahahah

SUMMARY OF PAY ITEMS

520-2-4, CONCRETE CURB, TYPE D

CONCRETE CURB SHALL BE MODIFIED PER HARDSCAPE DETAIL SHEET LD-9

580-1-1, LANDSCAPE COMPLETE, SMALL PLANTS INCLUDES:

- 1. PREPARATION OF PLANTING BEDS INCLUDING EXCAVATION OF EXISTING SOIL OR TURF AS DESCRIBED IN THE PLANS AND SPECIAL DETAILS.
- 2. COLLECTION AND APPROVAL OF PROPOSED PLANTS BY ENGINEER PRIOR TO DELIVERY TO THE PROJECT SITE.
- DELIVERY AND HOLDING OF PLANTS IN PREPARATION OF INSTALLATION.
- INSTALLATION OF PLANTS INCLUDING EXCAVATION OF SOILS FOR PLANTING, INCORPORATION OF SOIL AMENDMENTS, FERTILIZATION, PLACEMENT AND BACKFILLING OF SOIL, PLACEMENT OF MULCH AND ANY OTHER REQUIREMENTS COMMON TO THE WORK OR AS DESCRIBED IN THE SPECIFICATIONS.
- 5. 90 DAY ESTABLISHMENT WATERING AND MAINTENANCE PER PLANT ESTABLISHMENT PLAN.

580-1-2, LANDSCAPE COMPLETE, LARGE PLANTS INCLUDES:

- 1. COLLECTION AND APPROVAL OF PROPOSED PLANTS BY ENGINEER PRIOR TO DELIVERY TO THE PROJECT SITE.
- DELIVERY AND HOLDING OF PLANTS IN PREPARATION OF INSTALLATION
- 3. INSTALLATION AND STAKING OF PLANTS AS CITY OF TAMPA STANDARDS OR AS DESCRIBED IN THE SPECIAL DETAILS
- 4. ORGANIC MULCH APPLIED AROUND THE BASE OF CANOPY TREES AND SHRUBS AS

INDICATED ON PLANS LD-13 AND LD-14

- 5. SABLE PALM CHARACTER PALMS (SPC)
 - a. CHARACTER PALMS WILL BE SELECTED AND TAGGED BY THE ENGINEER PRIOR TO DELIVERY TO SITE.
- 6. PREPARED SOIL LAYER
 - a. PREPARED SOIL LAYER SHALL BE A FINISH SOIL LAYER
 - b. THE DEPTH OF THE FINISH SOIL SHALL BE PER PLANTING DETAILS NOTED IN LD-15 TO LD-18. THE AREA (CY) OF SOIL INCLUDE THE AVERAGE DEPTH OF SOIL AS DETERMINED BY THE HEIGHTS OF PLANTING AREAS.
- 7. BIO BARRIER
- a. TYPAR: 24"
- b. REFER TO HARDSCAPE DETAIL ON LD-10 FOR INSTALLATION
- 8. 90 DAY ESTABLISHMENT WATERING AND MAINTENANCE PER PLANT ESTABLISHMENT PLAN.

COT-101, PAVERS, ARCHITECTURAL SIDEWALK

- 1. CONTACT THE CITY OF TAMPA TRANSPORTATION DEPARTMENT TO COORDINATE USE OF BRICK PAVERS AVAILABLE WITHIN THE CITY'S STOCKYARD. IF THERE ARE NO AVAILABLE BRICK PAVERS FROM THE CITY'S STOCKYARD, COMPLETE THE FOLLOWING PRIOR TO PURCHASING NEW BRICK PAVERS:
- 1.1. OBTAIN SAMPLES OF BRICK PAVERS
- PROVIDE SAMPLES OF BRICK PAVERS TO THE CITY OF TAMPA TRANSPORTATION DEPARTMENT FOR THEIR APPROVAL AS PART OF THE SHOP DRAWING REVIEW PROCESS CONTRACT 21-C-00022 GREEN SPINE CYCLE TRACK - FDOT LAP (PG. SP-46)

1.3. AFTER THE CITY OF TAMPA TRANSPORTATION DEPARTMENT APPROVES THE BRICK PAVER SAMPLES, PROCEED WITH PURCHASE OF NEW PAVERS.

COT-102. PRE-EMERGENT HERBICIDE

- 1. PRE-EMERGENT HERBICIDE: RONSTAR G. HERBICIDE, 50LB BAG
- 2. APPLY PRIOR TO MULCHING
- 3. APPLY AT TREE RING OF EACH TREE
- 4. APPLY AT RATES RECOMMENDED BY THE MANUFACTURER WITH THE AREAS OF NEW PLANTING BEDS

COT-103, FURNISHINGS

- 1. BENCH: VICTOR STANLEY; CLASSIC SERIES; MODEL NO. CR-138; 6'; COLOR: BLACK: INTERMEDIATE ARMRESTS (CENTER)
- 2. BIKE RACK: FAIR WEATHER SITE FURNISHINGS: MODEL NO. B-1500 (SURFACE MOUNT), COLOR: BLACK
- 3. BIKE MAINTENANCE STATION WITH AIR PUMP: THE PARK CATALOG: ITEM NO.: 509-2001-134; COLOR: BLACK
- 4. LITTER RECEPTACLE: VICTOR STANLEY; IRONSITES COLLECTION; MODEL NO. SD-42; 36 GALLON; COLOR: BLACK - POWDERCOAT

	R E V I .	SIONS		DAVID R. CONNER, RLA		CITY OF TAM	I D A
DATE	DESCRIPTION	DATE	DESCRIPTION	LA0001327 DAVID CONNER + ASSOCIATES		MOBILITY DEPAR	
				100 E. MADISON ST, SUITE 200	ROAD NO.	COUNTY	PROJECT DESIGN NO
				TAMPA, FL 33602 CERT. OF AUTHORIZATION LC0000319		HILLSBOROUGH	21-C-00022

TABULATION OF QUANTITIES AND PLANT SCHEDULE

LD-3

2/6/2023 5:16:04 PM

WATER APPLICATION	RATES
(FOR NON-IRRIGATED AREAS)	
TREES AND PALMS	SATURATE TO 3' DEPTH. FLOOD TREE
TURF	REFER TO ROADWAY SPECIFICATIONS
SMALL PLANTS	WATER EACH PLANT BY HAND. PROVIDE 2 GALLONS WATER PER PLANT
NOTE:	
CONTRACTOR IS RESPONS	IBLE FOR WATER SOURCE AS PART OF PAY ITEM.


FERTILIZER APPLICATION RATES									
	FERTILIZER PER DETAILS AND MANF. SPECIFICATIONS SHALL BE APPLIED AT TIME OF PLANTING AND ONCE ANNUALLY.								
,	FERTILIZER PER DETAILS AND MANF. SPECIFICATIONS SHALL BE APPLIED AT TIME OF PLANTING AND ONCE ANNUALLY.								

R E V I S I O N S DATE DESCRIPTION DATE DESCRIPTION				DAVID R. CONNER, RLA		CITY OF TAM	
				——— LA0001327 DAVID CONNER + ASSOCIATES		MOBILITY DEPAR	
				100 E. MADISON ST, SUITE 200	ROAD NO.	COUNTY	PROJECT DESIGN NO
				TAMPA, FL 33602 CERT. OF AUTHORIZATION LC0000319		HILLSBOROUGH	21-C-00022

PLANT ESTABLISHMENT PERIOD SHEET NO.

LD-4

001 COT Green Spine Cvcle Track\DESIGN\PRODUCTION\ACAD\BA:

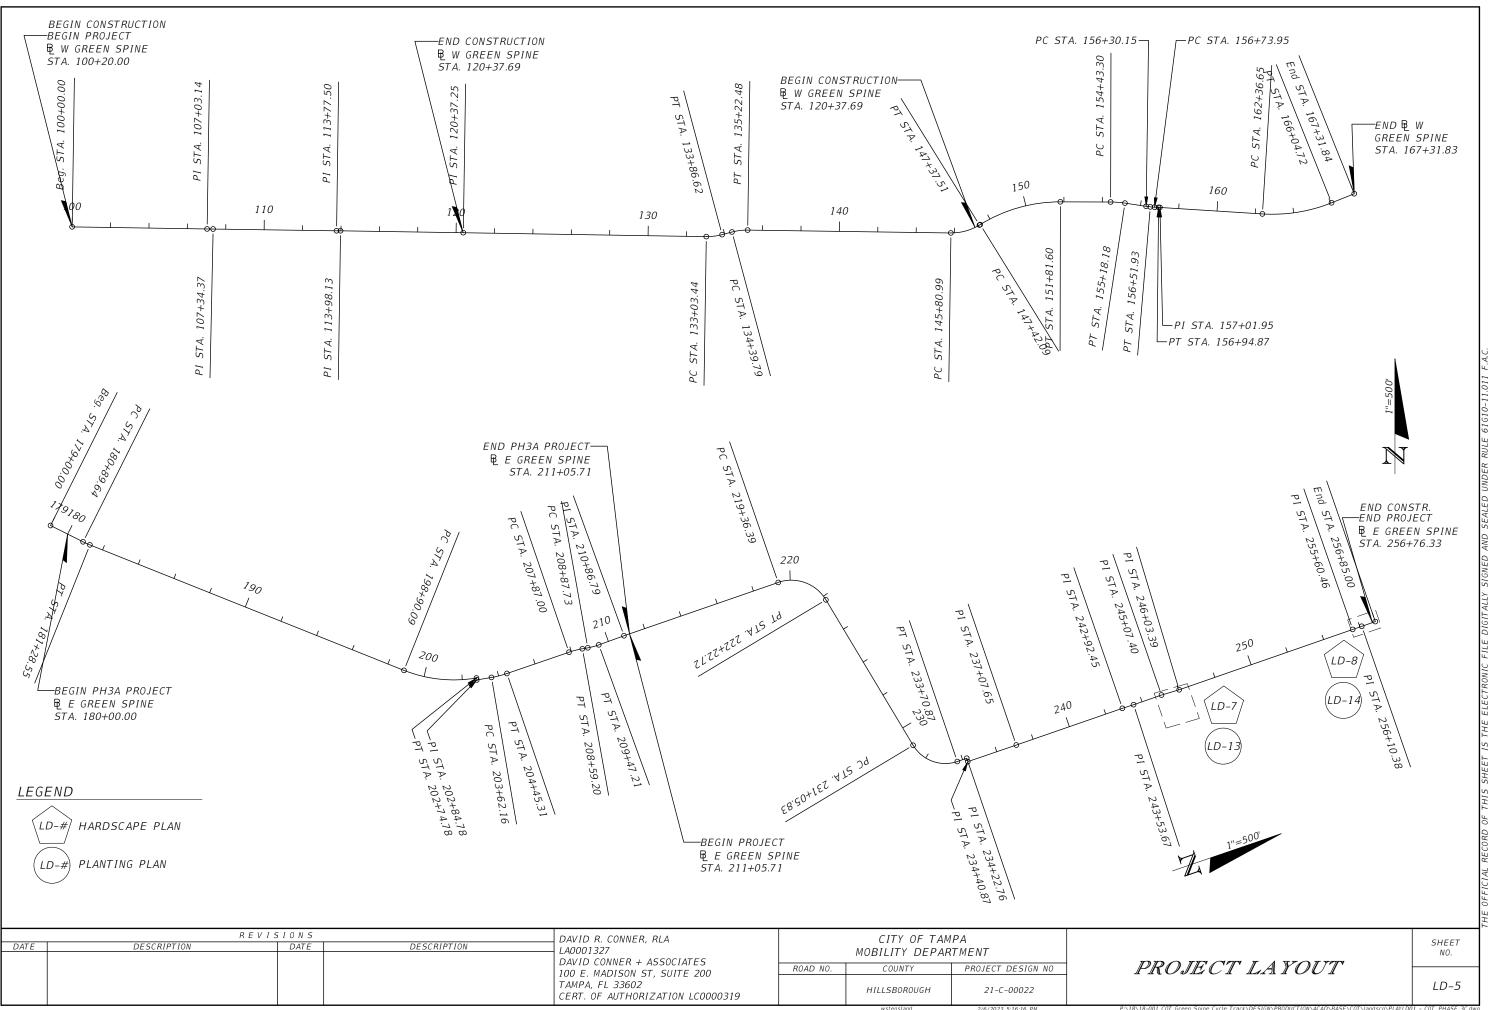

LANDSCAPING

- THE BASELINE SHOWN IN THE PLANS IS FOR INFORMATION PURPOSE ONLY. THE BASELINE IS REFERENCED FROM PROJECT NO. 439476-1-58-01.
- PERFORMANCE TURF INDICATED ON SHEETS LD-13 TO BE INCLUDED IN CIVIL PAY ITEM FOR PERFORMANCE SOD.
- INSTALL SMALL PLANT ROOTBALLS A MINIMUM OF 2 FEET FROM UNDERGROUND UTILITIES.
- DO NOT INSTALL LANDSCAPE MATERIALS THAT BLOCK TRAFFIC CONTROL SIGNS OR DEPARTMENT'S INFORMATIONAL OR LOGO SIGNS. ALL LANDSCAPE AREAS SHALL BE MAINTAINED TO PRESERVE VISIBILITY OF TRAFFIC CONTROL DEVICES AND SIGNS. RESET SIGNS DISTURBED DURING CONSTRUCTION TO CURRENT STANDARDS FOR HEIGHT, OFFSET, AND METHOD OF INSTALLATION AT THE CONTRACTOR'S EXPENSE.
- SCHEDULE ALL ON-SITE PLANT DELIVERIES TO OCCUR ON MONDAY THROUGH FRIDAY ONLY UNLESS APPROVED BY THE ENGINEER IN ADVANCE. ENSURE THAT PLANT MATERIAL IS DELIVERED UNDAMAGED FROM TRANSPORTATION OR DIGGING OPERATIONS. THE ENGINEER MAY REJECT MATERIAL THAT HAS BEEN DAMAGED OR RENDERED UNACCEPTABLE DUE TO RELOCATION OR TRANSPORTATION FROM THE POINT OF ORIGIN. REPLACE DAMAGED PLANT MATERIAL AT NO ADDITIONAL EXPENSE TO THE DEPARTMENT.
- 6. "WATER IN" TREES AND PALMS LEAVING NO AIR POCKETS. FILL ANY AIR POCKETS WITH SOIL AND KEEP GRADE WITHIN TREE RING EVEN AND SMOOTH. MAINTAIN EROSION FREE TREE RINGS AND REPAIR AS NECESSARY PER PLANING DETAILS. WATER SOURCE AND APPLICATION OF WATER FOR THE SUCCESSFUL TRANSPLANT, ESTABLISHMENT, AND SURVIVAL OF PLANTS IS THE RESPONISBILITY OF THE CONTRACTOR AT NO ADDITIONAL EXPENSE TO THE CITY.
- DURING PLANTING, APPLY A SLOW/CONTROLLED RELEASE 8-2-12+4 MG PALM FERTILIZER THAT INCLUDES IRON, MANGANESE AND BORON AS MINOR ELEMENTS. DISTRIBUTE THE FERTILIZER EVENLY OVER THE TOP OF THE PLANTING HOLE WITHIN THE SOIL RING AT A RATE SPECIFIED IN THE MANUFACTURER'S RECOMMENDED LABEL DIRECTIONS.
- TRIMMING OF PALMS WILL BE LIMITED TO DEAD/BROWN FRONDS AND ANY LOOSELY ATTACHED DANGLING FRONDS, FRUITS, AND PETIOLES OR SPATHES UNLESS OTHERWISE DIRECTED BY THE ENGINEER.
- MULCH MATERIAL SHALL EITHER INORGANIC (SHELL ROCK) OR ORGANIC (SHREDDED HARDWOOD) MULCH AS INDICATED ON THE PLANS AND PLACED THROUGHOUT ALL NEW PLANTING BEDS. MULCH SHALL COVER ALL EXPOSED SOIL WITHIN BEDS TO COMPRESSED DEPTH OF 3". DO NOT PLACE MULCH AGAINST TRUNK OF PLANTS OR TREES. DO NOT MULCH PERFORMANCE TURF.
- 10. THE ESTABLISHMENT PERIOD SHALL BE 90 DAYS FROM THE DATE OF FINAL ACCEPTANCE OF THE INSTALLATION OF THE TOTAL PROJECT.
- 11. ALL LANDSCAPE MATERIAL SHALL BE INSTALLED AND MAINTAINED AT ALL TIMES IN ACCORDANCE WITH THE FDOT STANDARDS INDEX 580 AS WELL AS ALL OTHER APPLICABLE CITY OF TAMPA STANDARDS. APPLY THE MORE STRINGENT STANDARDS WHERE CONFLICT OCCURS.
- 12. PROCEDURE (TOPIC NO, 850-000-015-I OF 01/01/2014), "ALL CONTRACTORS AND/OR PERMITTEE'S WHO CONTRACT THE APPLICATION OF FERTILIZER SHALL ENSURE THEY ARE LICENSED COMMERCIAL APPLICATORS WHO HAVE BEEN TRAINED THROUGH THE GREEN INDUSTRY BMP PROGRAM, AND HAVE OBTAINED A LIMITED CERTIFICATION FOR URBAN LANDSCAPE COMMERCIAL FERTILIZER APPLICATION UNDER SECTION 482.1562,F.S. WITH A CURRENT COPY OF THE LICENSE ON FILE.

13. THE EXISTING SIDEWALKS SHALL REMAIN AVAILABLE FOR SAFE USE THROUGHOUT THE PROJECT WITH ONLY PERIODIC CLOSURES AS APPROVED BY ENGINEER.

ROOT REGENERATED PALM REQUIREMENTS

- 1. ALL SABAL PALMS SHALL BE ROOT REGENERATED AND MEET THE FOLLOWING CRITERIA.
 - a. PALMS SHALL HAVE BEEN DUG AND REPLANTED IN CONTAINERS LOCATED WITHIN A NURSERY SPECIALIZING IN REGENERATED ROOT PALM TREE PRODUCTION.
 - b. PALM TREES SHALL HAVE BEEN PLANTED IN CONTAINERS AND HELD IN A NURSERY ENVIRONMENT FOR A MINIMUM OF 6 MONTHS. PRIOR TO DELIVERY TO THE PROJECT, ROOTBALL SHALL BE CONTAINED IN A STRETCH WRAP OR EQUIVALENT, FORMING A SOLID DURABLE ROOTBALL.
 - c. PRIOR TO DELIVERY TO THE PROJECT, PALMS ROOTS SHALL DEMONSTRATE SIGNIFICANT VISIBLE NEW REGENERATED ROOTS AT THE PERIMETER OF THE ROOT BALL.
 - d. PALM TREES SHALL DEMONSTRATE NEW GROWTH IN THE CANOPY INCLUDING FULLY EXTENDED AND OPEN FRONDS.
 - e. ALL PALM TREE LOADS SHALL BE TARPED TO PREVENT WIND DAMAGE DURING DELIVERY.
 - f. ALL PALM TREES SHALL BE INJECTED WITH 'TREE SAVER' (OXYTETRACYCLINE HYDROCHLORIDE 39% ACTIVE INGREDIENTS), A MINIMUM OF 1X PRIOR TO TRANSPLANTING, AND 1X - 90 DAYS AFTER TRANSPLANTING. PROVIDE RECEIPTS TO ENGINEER.

SITE GRADING

- AFTER ALL UTILITIES HAVE BEEN LOCATED, STAKE OUT THE SITE IMPROVEMENTS FOR FIELD INSPECTION BY THE ENGINEER.
- 2. TWO WEEKS PRIOR TO COMMENCEMENT OF GRADING WORK. APPLY ON-SELECTIVE HERBICIDE THROUGHOUT THE LIMITS OF GRADING WORK.
- 3. SHAPE SOILS TO FORM LANDSCAPE AREAS INDICATED.
- USE IMPORTED SOIL SIMILAR IN COMPOSITION AND PERFORMANCE (ESPECIALLY RELATIVE TO DRAINAGE/PERCOLATION) TO THE IN-SITU MATERIAL AND MEET THE REQUIREMENTS OF SPECIFICATION SECTION 162-1.1 -FINISHED SOIL LAYER.
- 5. PROPERLY DISPOSE OF ANY EXCESS SOIL.
- 6. EXISTING TOPOGRAPHIC SURVEY INFORMATION INDICATED ON THESE PLANS WAS PREPARED BY OTHERS UNDER A PREVIOUS CONTRACT AND IS PROVIDED FOR REFERENCE ONLY ON THIS PROJECT.
- CONFIRM EXISTING ELEVATIONS ON SITE PRIOR TO BEGINNING ANY EXCAVATION OR GRADING WORK. ANY DEVIATIONS FROM THE PLANS SHALL BE APPROVED BY THE ENGINEER IN ADVANCE.

UTILITY

- 1. IN THE EVENT A DIRECT UTILITIES CONFLICT DOES ARISE. THE PROPOSED PLANTING CAN BE MOVED WITH PRIOR APPROVAL OF THE ENGINEER.
- 2. USE EXTREME CAUTION WHEN EXCAVATING, INSTALLING, BACKFILLING AND COMPACTING AROUND EXISTING UTILITIES.

DESIGN SPEEDS						
SEGMENT	DESIGN SPEED	POSTED SPEED				
PHASE 3C (13TH AVE. TO 17TH AVE.)	30 MPH	25 MPH				

LEGEND



EXISTING TREE



CONTROL JOINT ISOLATION JOINT



PAVERS



LITTER RECEPTACLE



BENCH

REVISIONS DAVID R. CONNER, RLA DATE DESCRIPTION DESCRIPTION DATE Ι ΔΩΩΩ1327 DAVID CONNER + ASSOCIATES ROAD NO 100 E. MADISON ST, SUITE 200 TAMPA, FL 33602 CERT. OF AUTHORIZATION LC0000319

CITY OF TAMPA COUNTY

HILLSBOROUGH


MOBILITY DEPARTMENT


PROJECT DESIGN NO 21-C-00022


GENERAL NOTES


SHEET


LD-6

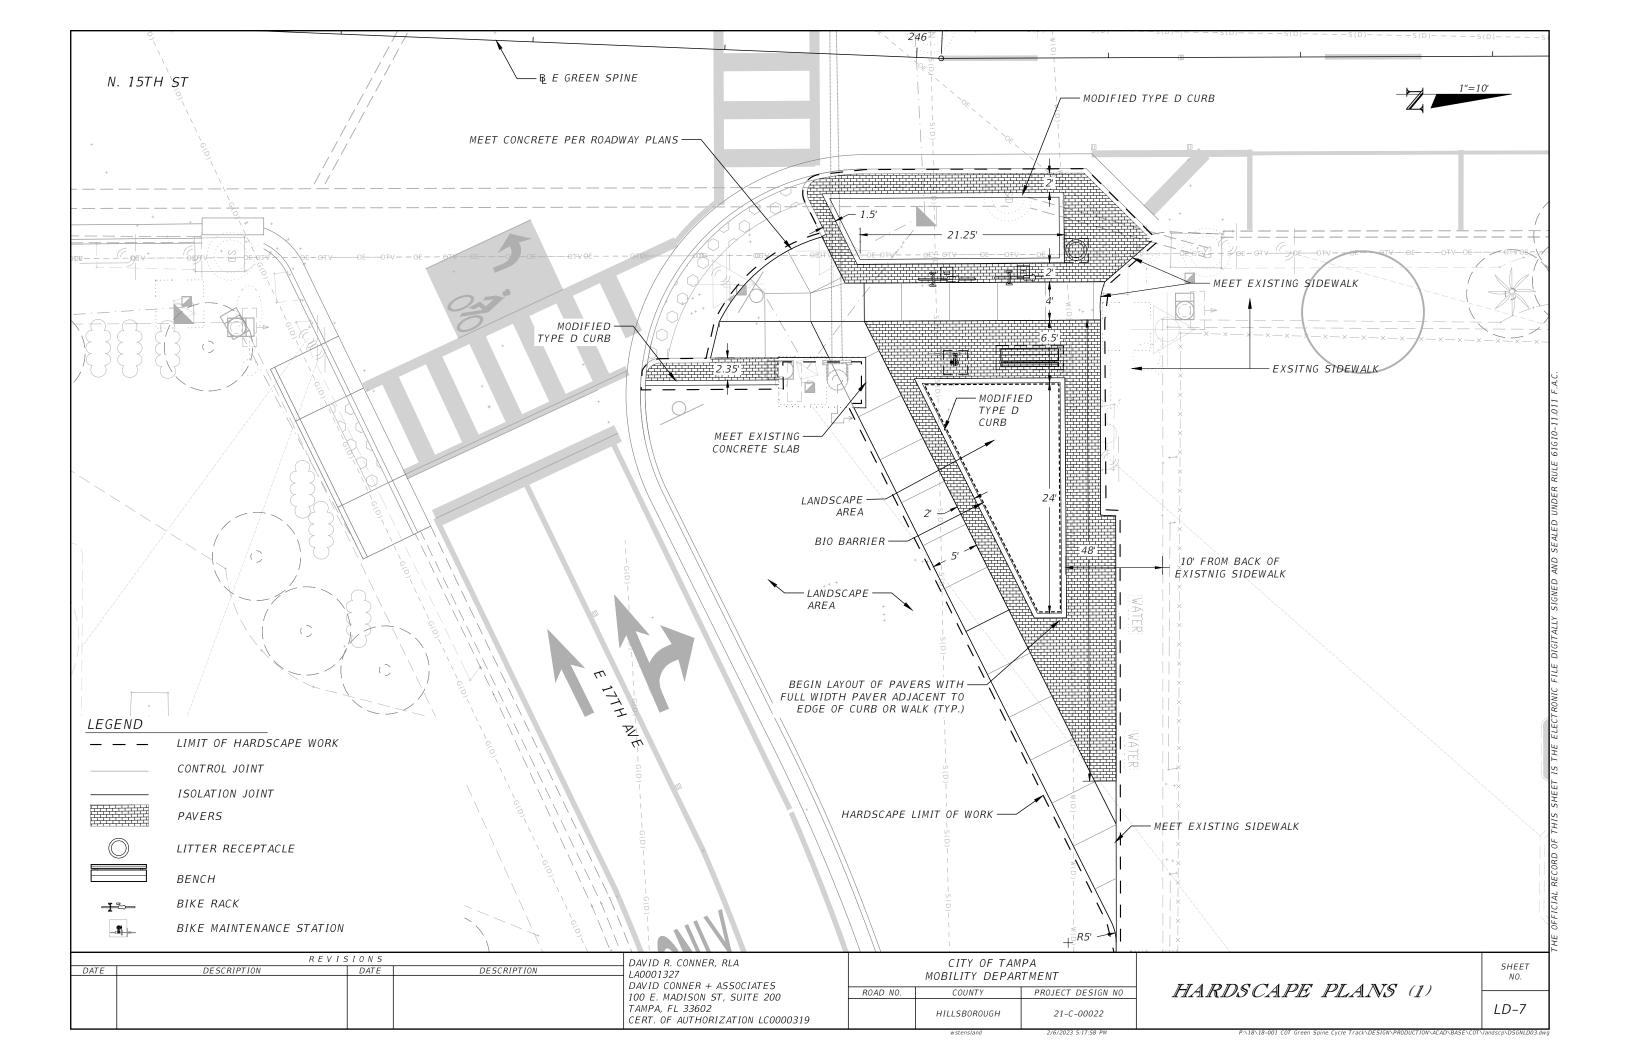

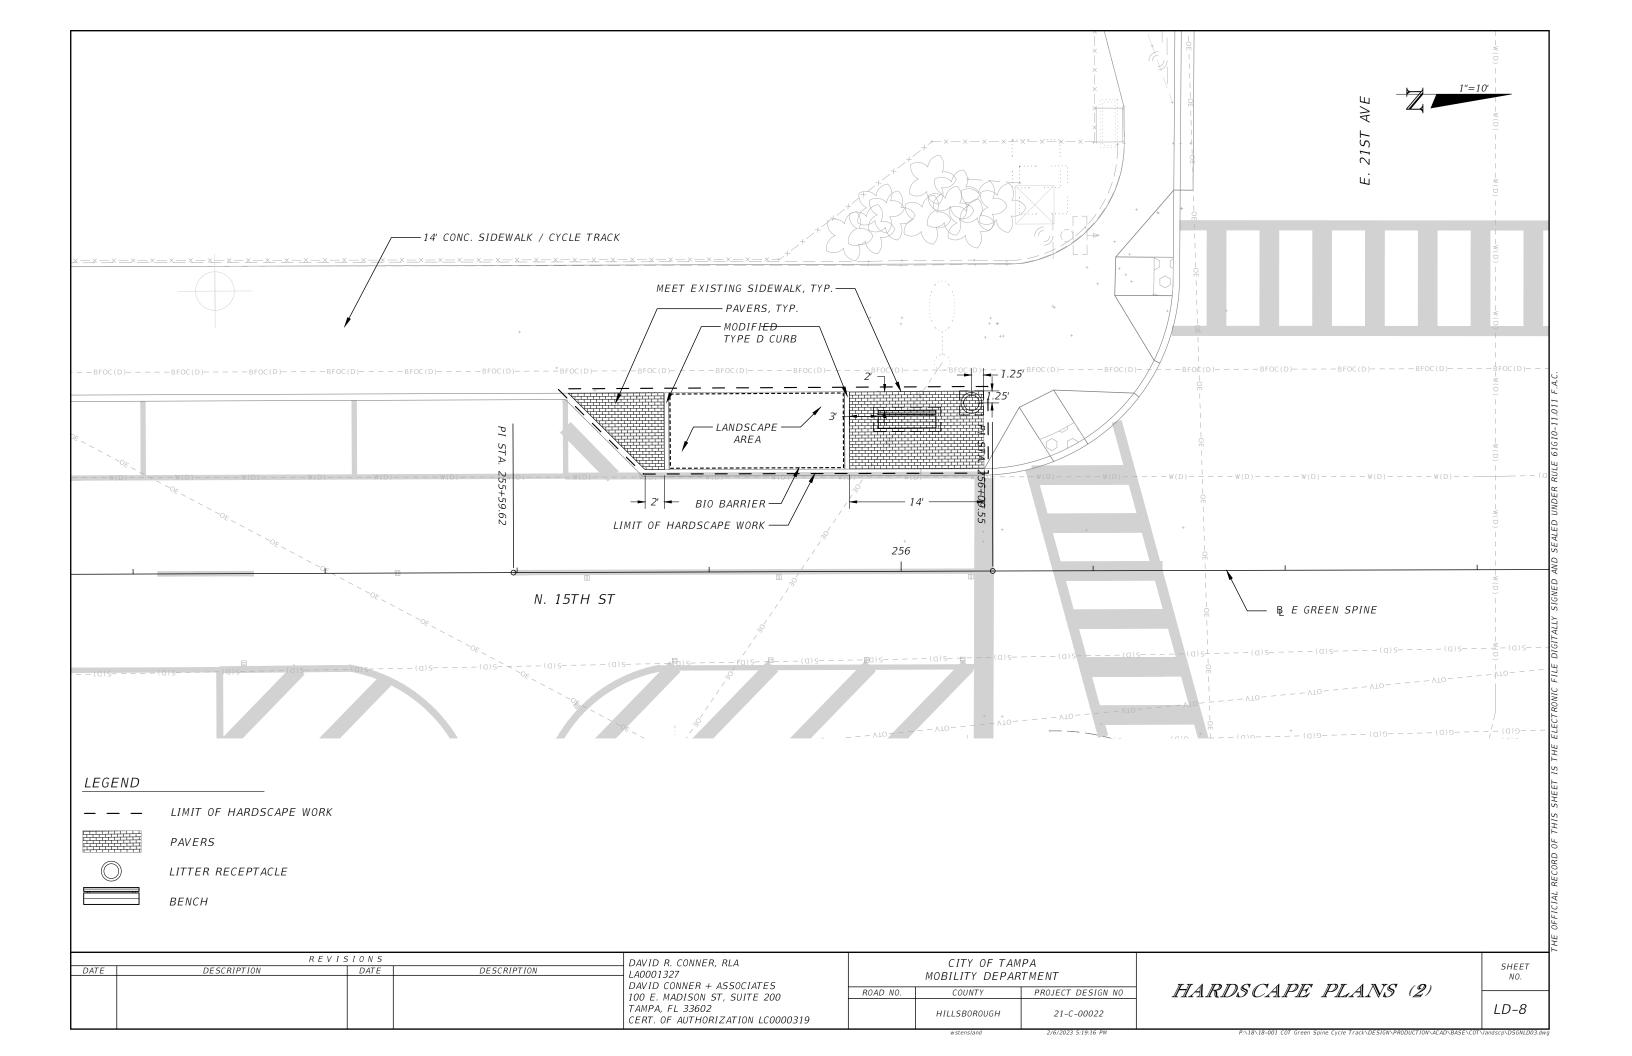

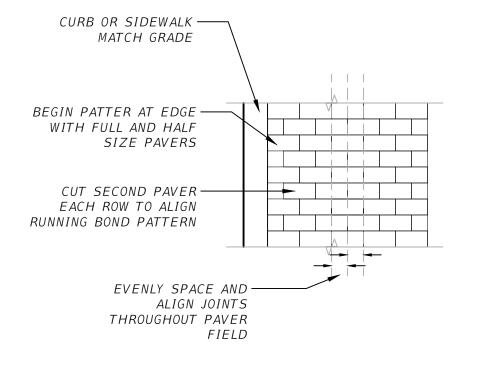

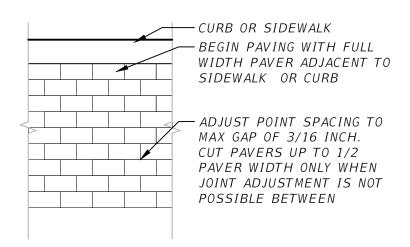

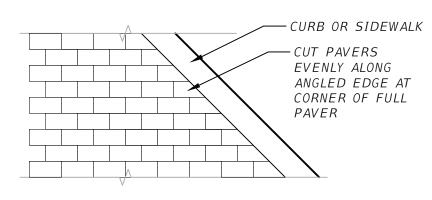

PERPENDICULAR TO CURB OR SIDEWALK

PARALLEL TO CURB OR SIDEWALK

PAVING AT MISALIGNED EDGE

(1)

DATE

UNIT PAVING PATTERN - RUNNING BOND

1/2'' = 1'-0''

DESCRIPTION

REVISIONS

DAVID R. CONNER, RLA
LA0001327
DAVID CONNER + ASSOCIATES
100 E. MADISON ST, SUITE 200
TAMPA, FL 33602
CERT. OF AUTHORIZATION LC0000319

CITY OF T
MOBILITY DEF
ROAD NO. COUNTY
HILLSBOROUGH

CITY OF TAMPA
MOBILITY DEPARTMENT

COUNTY PROJECT DESIGN NO HARDS CAPE

21-C-00022


HARDSCAPE DETAILS (1)

SHEET NO.

DCA-GR-29

LD-9

nsland 2/6/2023 5:19.

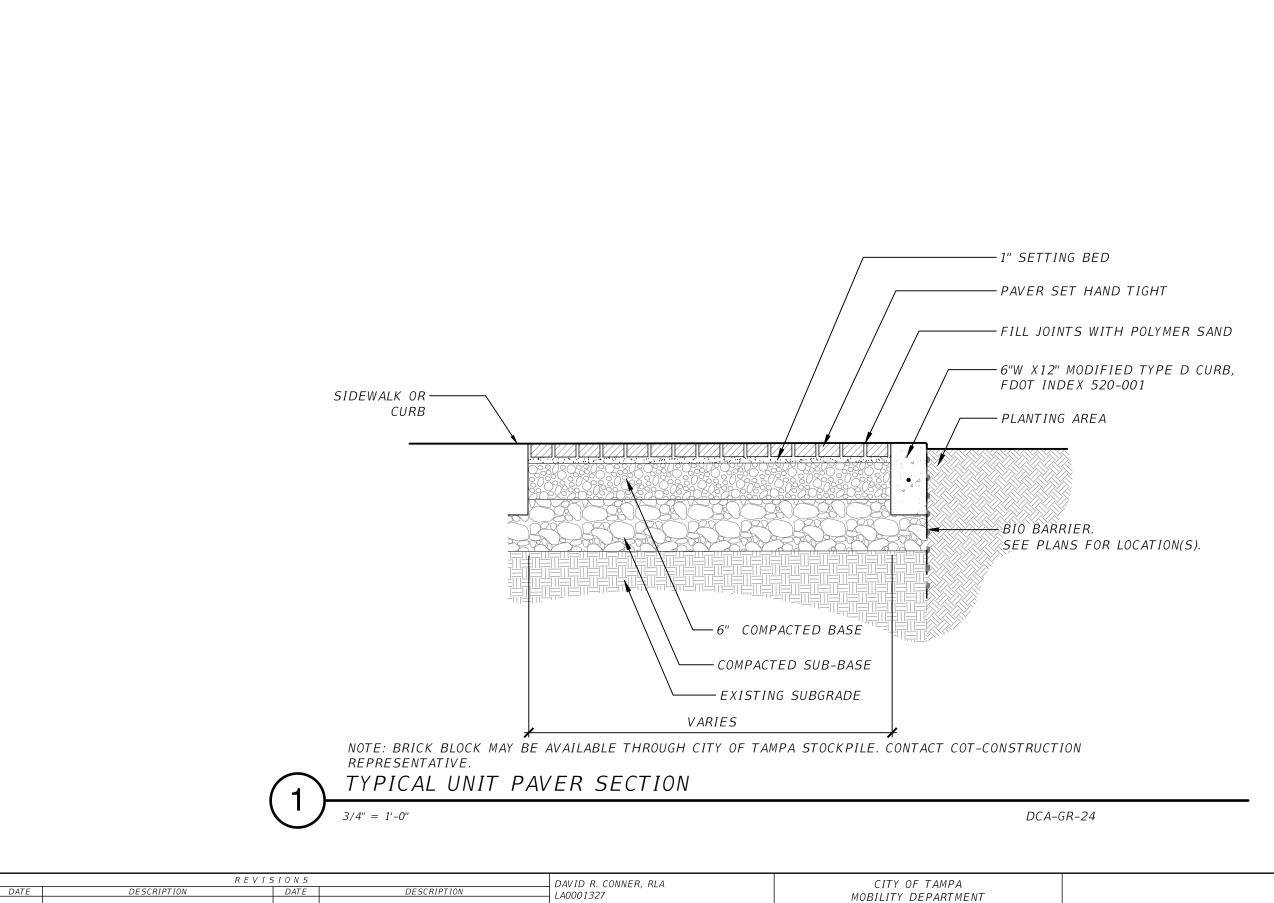

DAVID CONNER + ASSOCIATES

TAMPA, FL 33602

100 E. MADISON ST, SUITE 200

CERT. OF AUTHORIZATION LC0000319

PROJECT DESIGN NO HAT

HARDS CAPE DETAILS (2)

SHEET NO.


LD-10


vstensland 2/6/2023 5:19:23

COUNTY

HILLSB0R0UGH

ROAD NO.

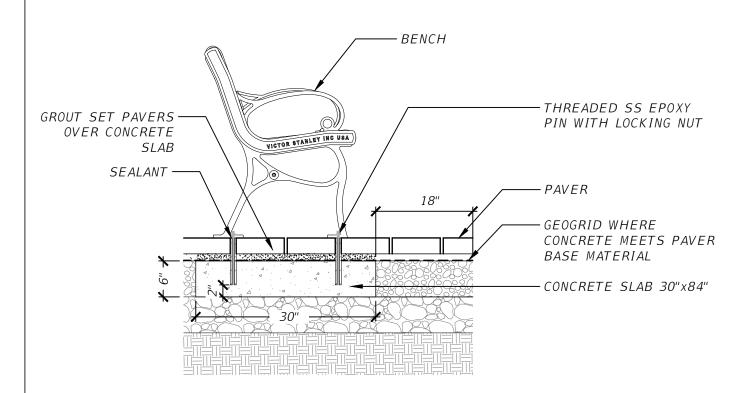

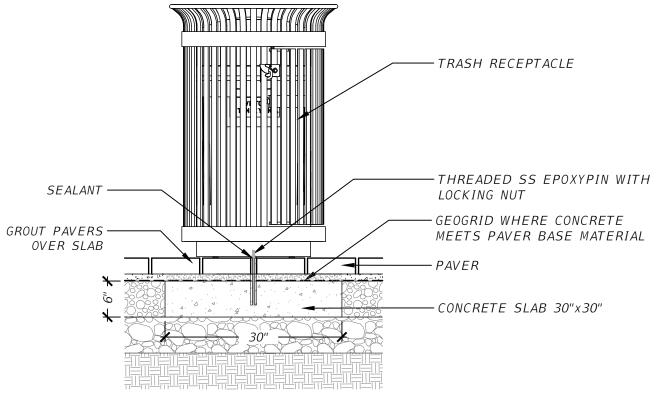

BENCH MOUNTING DETAIL

3/4" = 1'-0"

DCA-GR-32

2) TRASH RECEPTACLE MOUNTING DETAIL

3/4" = 1'-0"

	REVIS	IONS						$\overline{}$
DATE	DESCRIPTION	DATE	DESCRIPTION	DAVID R. CONNER, RLA LAO001327		CITY OF TAM MOBILITY DEPAR		
				DAVID CONNER + ASSOCIATES				_
				100 E. MADISON ST, SUITE 200	ROAD NO.	COUNTY	PROJECT DESIGN NO	_
				TAMPA, FL 33602 CERT. OF AUTHORIZATION LC0000319		HILLSB0R0UGH	21-C-00022	


HARDSCAPE DETAILS (3)


DCA-GR-31

SHEET NO.

LD-11

ensland 2/6/2023 5:19:2

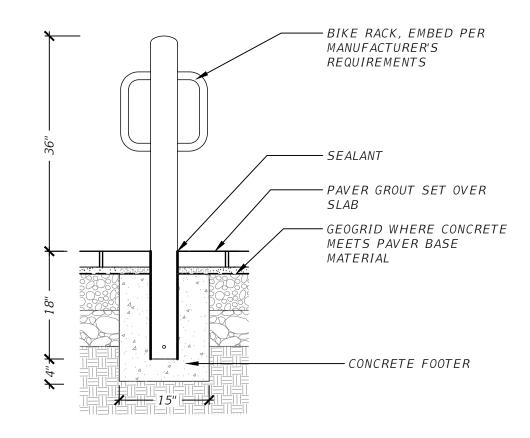

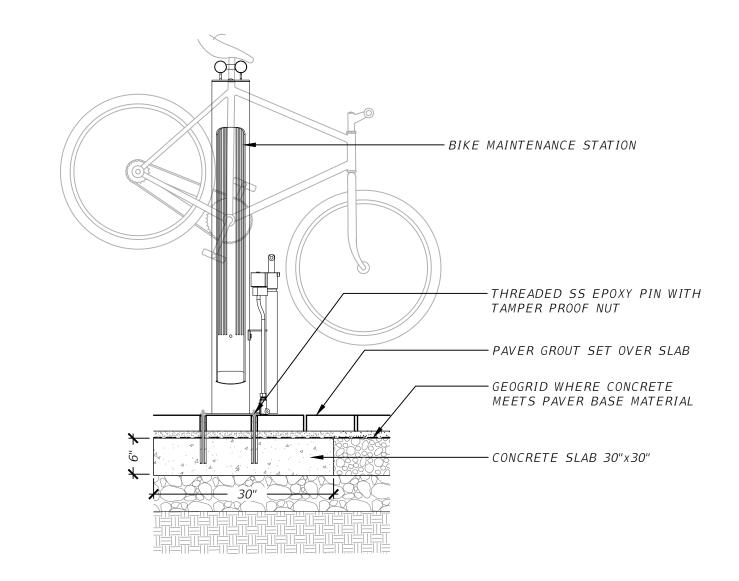

> BIKE RACK MOUNTING DETAIL

3/4'' = 1'-0''

BIKE MAINTENANCE STATION MOUNTING DETAIL

3/4" = 1'-0"

DCA-GR-33

	REV	ISIONS		DAVID R. CONNER, RLA		
DATE	DESCRIPTION	DATE	DESCRIPTION	LA0001327		
				DAVID CONNER + ASSOCIATES		
				100 E. MADISON ST, SUITE 200	ROAD NO.	L
				TAMPA, FL 33602		
				CERT. OF AUTHORIZATION LC0000319		


	CITY OF TAM MOBILITY DEPAR	
ROAD NO.	COUNTY	PROJECT DESIGN NO
	HILLSBOROUGH	21-C-00022


HARDSCAPE DETAILS (4)


SHEET NO.


LD-12


stensland 2/6/2023 5:1

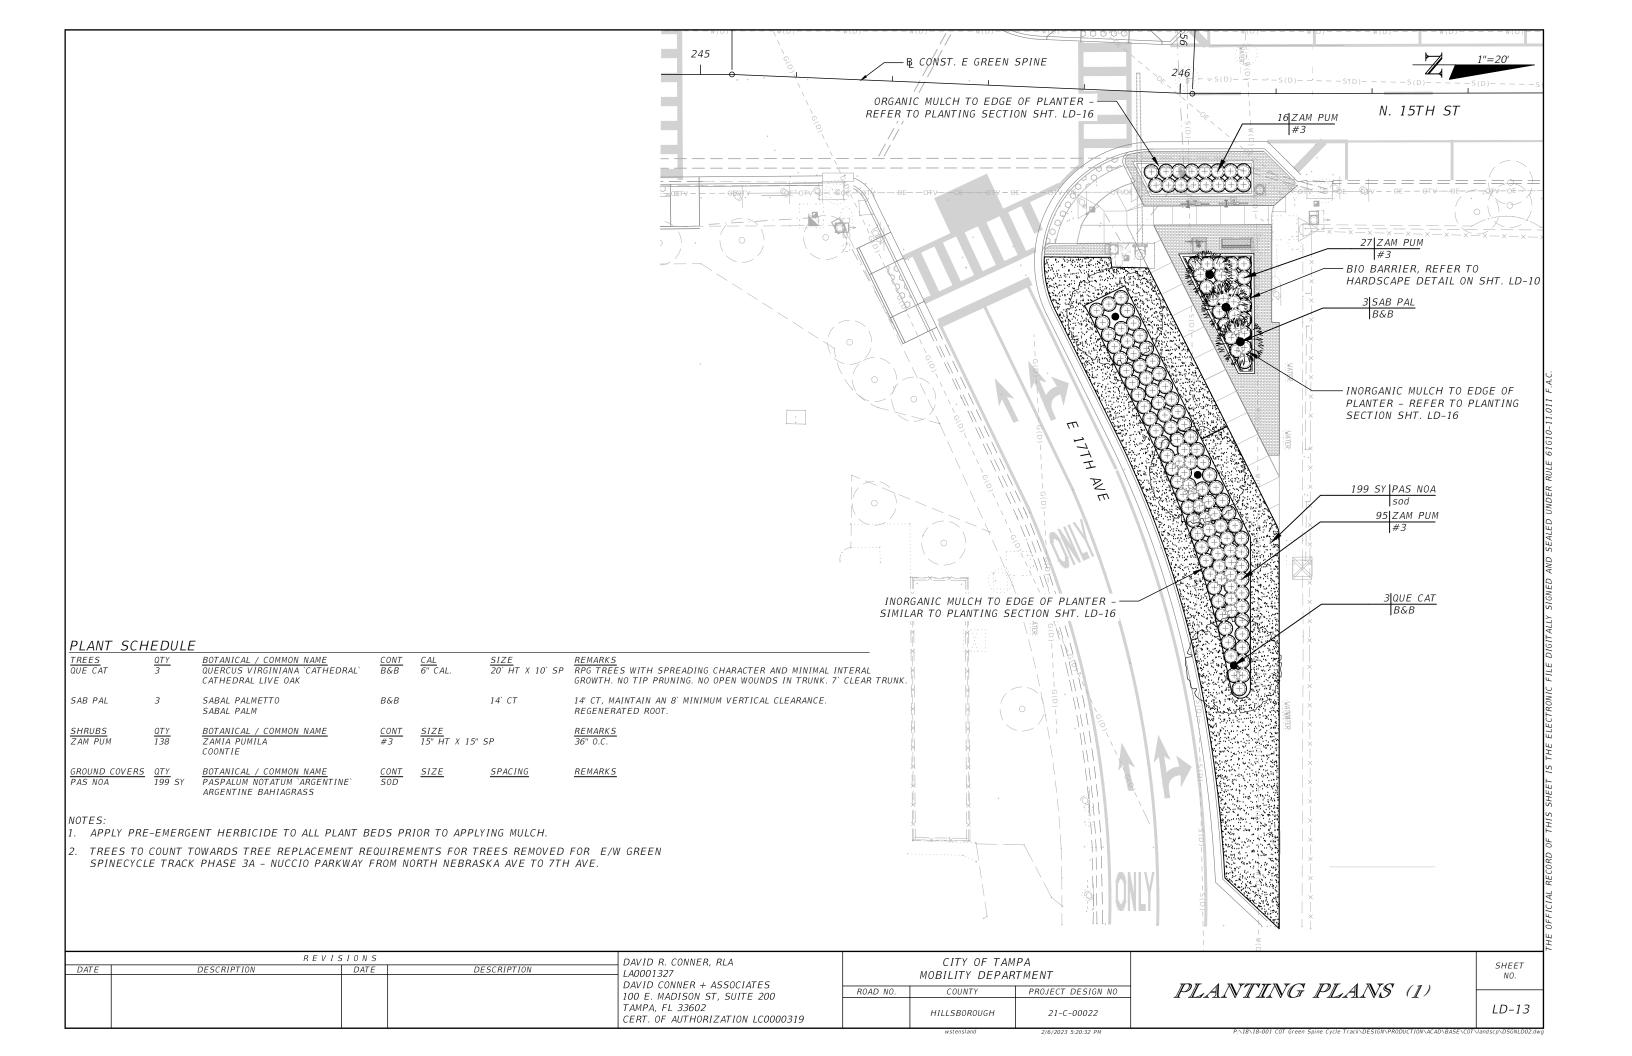

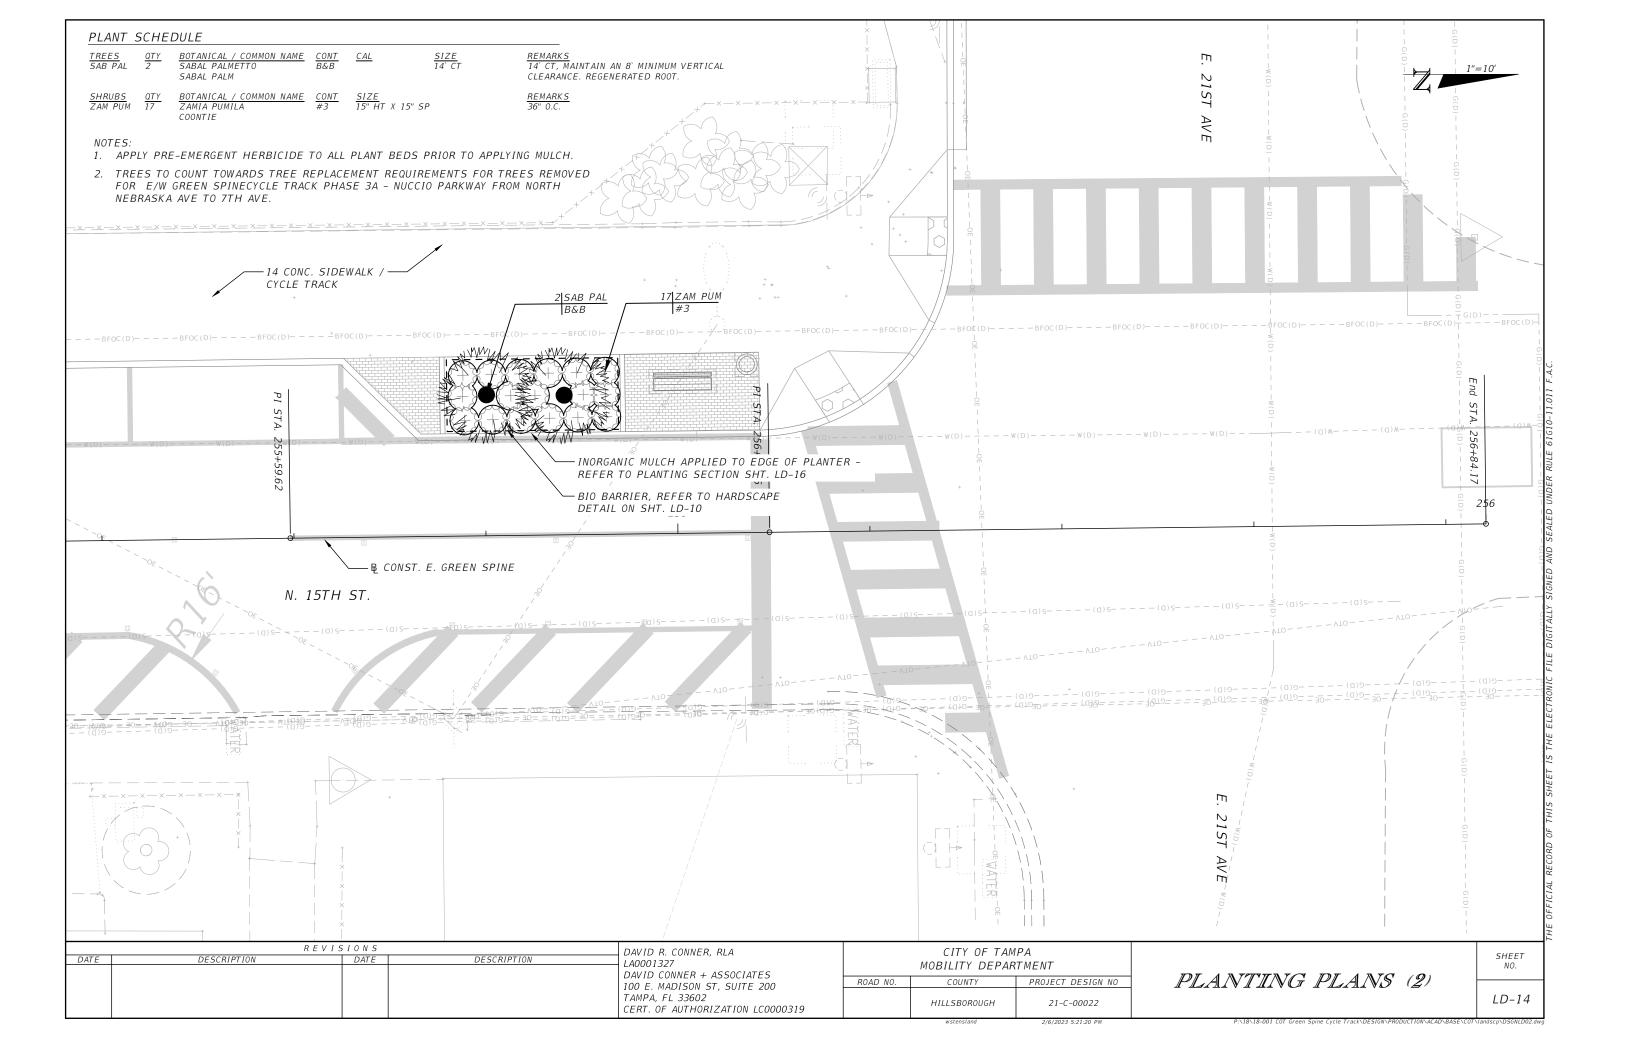

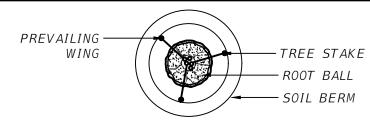

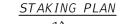

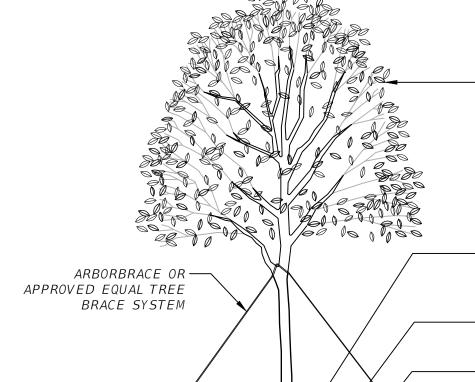

- DO NOT HEAVILY PRUNE THE TREE AT PLANTING. PRUNE ONLY CROSSOVER LIMBS,
CO-DOMINANT LEADERS, AND BROKEN OR DEAD BRANCHES. SOME INTERIOR TWIGS AND
LATERAL BRANCHES MAY BE PRUNED AS WELL. DO NOT REMOVE THE TERMINAL BUDS OF
BRANCHES THAT EXTEND TO THE EDGE OF THE CROWN. ALL TREES SHALL BE FREE OF OPEN
WOUNDS AND WOUNDS SCARS IN THE CLEAR TRUNK AREA

REMOVE BURLAP FROM TOP AND TOP 3" PERIMETER OF ROOT BALL. REMOVE ALL STRAPS AND SYNTHETIC BURLAP COMPLETELY. CUT AND REMOVE WIRE BASKET A MIN. DEPT OF 4" BELOW TOP OF ROOT BALL.

FILL SOIL RING WITH 2"-3" DEPTH MULCH. DO NOT ALLOW MULCH TO BE PLACED AGAINST THE TRUNK

ROUND-TOPPED SOIL BERM 4" X 8" WIDE ABOVE ROOT BALL SURFACE CONSTRUCTED AROUND ROOT BALL. BERM SHALL BEGIN AT ROOT BALL PERIPHERY

-TIME-RELEASE FERTILIZER. PROVIDE TABLET IN QUANITITY RECOMMENDED BY MANUFACTURER FOR SIZE OF TREE.

PLANTING SOIL MIX PER SPECIFICATION BLENDED ONSITE WITH NATIVE SOIL AT 1:2 RATIO (PLANTING SOIL: NATIVE SOIL). LIGHTLY TAMP SOIL AROUND THE ROOT BALL TO REMOVE AIR POCKETS. DO NOT OVER COMPACT. WHEN THE PLANT HOLE HAS BEEN BACKFILLED WATER JET THE PLANTING SOIL TO REMOVE ANY REMAINING AIR POCKETS AND STABALIZE THE ROOTBALL. FILL PLANT RING WITH WATER TO TOP OF PERIMETER SOIL RING AND ALLOW TO PERCOLATE INTO THE SOIL.

-SLOPE SIDES OF SOIL

-EXISTING SOIL

-PLACE TREE ON UNDISTRURBED BOTTOM OF PIT. WHERE POOR DRAINAGE OR UNDERGROUND WATER IS SUSPECTED CONTACT LANDSCAPE ARCHITECT PRIOR TO INSTALLATION.

NOTES:

1) PULL MULCH AWAY FROM TRUNK OF TREE. NO MORE THAN 1" OF MULCH ON TOP OF ROOT BALL. 2) APPLY PRE-EMERENT HERMICIDE TO ALL PLANTING BEDS PRIOR TO APPLYING MULCH.



LARGE TREE PLANTING

1/4'' = 1'-0''


	REVIS	5 I O N S		DAVID R. CONNER, RLA		CITY OF TAM	ΙΡΔ
DATE	DESCRIPTION	DATE	DESCRIPTION	LA0001327 DAVID CONNER + ASSOCIATES		MOBILITY DEPAR	
				DAVID CONNER + ASSOCIATES 100 E. MADISON ST, SUITE 200	ROAD NO.	COUNTY	PROJECT DESIGN NO
				TAMPA, FL 33602 CERT. OF AUTHORIZATION LC0000319		HILLSBOROUGH	21-C-00022

PLANTING DETAILS (1)

SHEET NO.

LD-15

nd 2/6/2023 5:21.

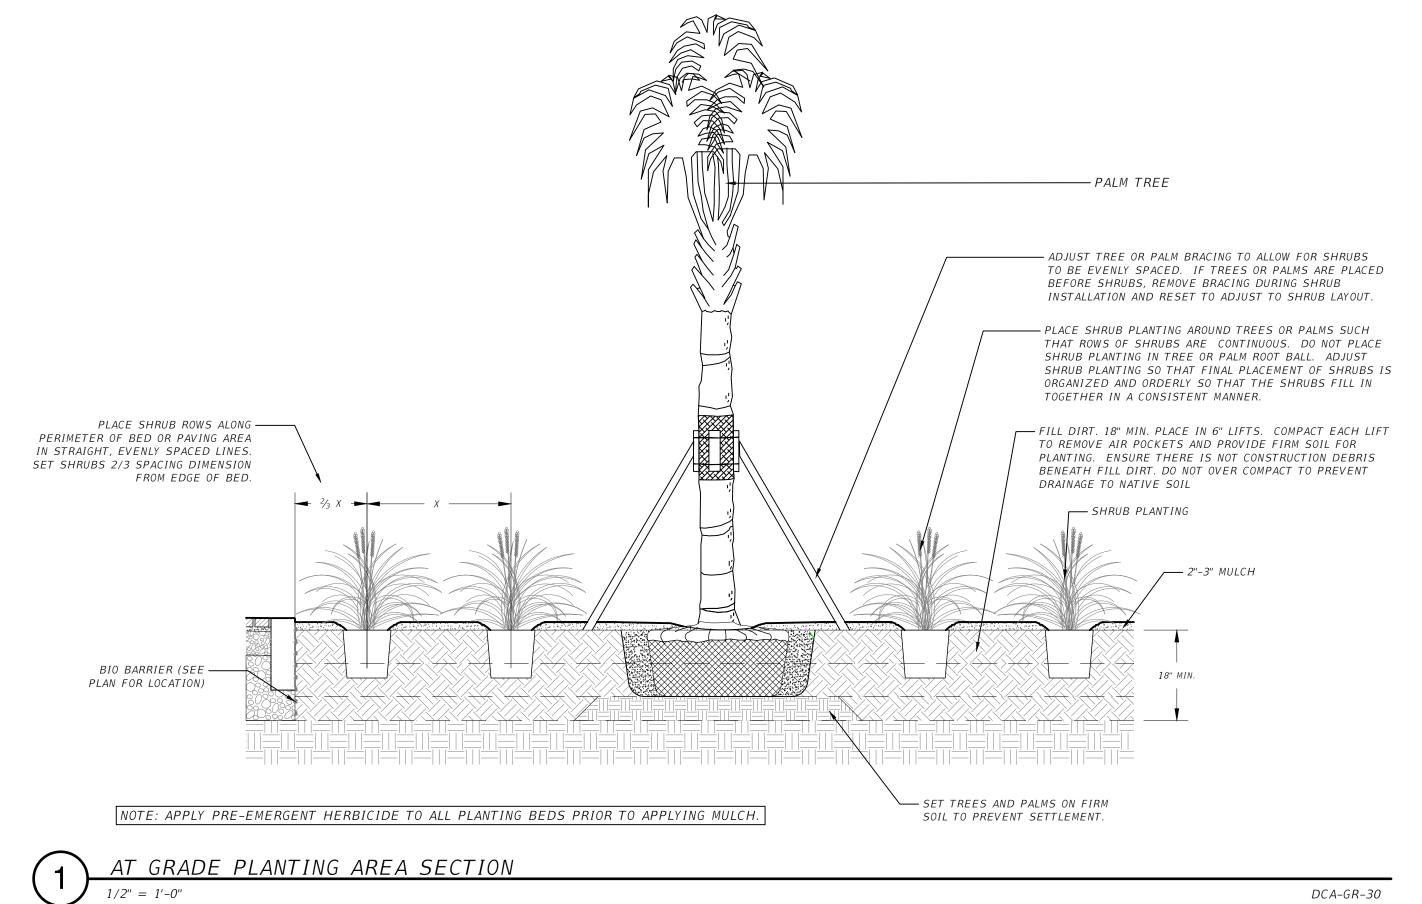


•	7	1	\neg	UNADL		1/ \ L /\	JLCI.	LOIV
/			1/2" =	= 1'-0"				

DATE	DESCRIPTION REVI	DATE	TAMPA, FL 33602 CERT. OF AUTHORIZATION LC0000319 HILLSBOROUGH 21-C-00022					
				100 E. MADISON ST, SUITE 200 TAMPA, FL 33602	ROAD NO.			PLANTING DETAILS (2)
				CERT. OF AUTHORIZATION LC0000319		wetoneland	2/5/2022 5:21:27 DM	BA 19 19 001 COT Cropp Spins Curls Track) DESIGNA BRODUCTIONA ACAD PASS COTA Landres N.D.

SHEET

LD-16

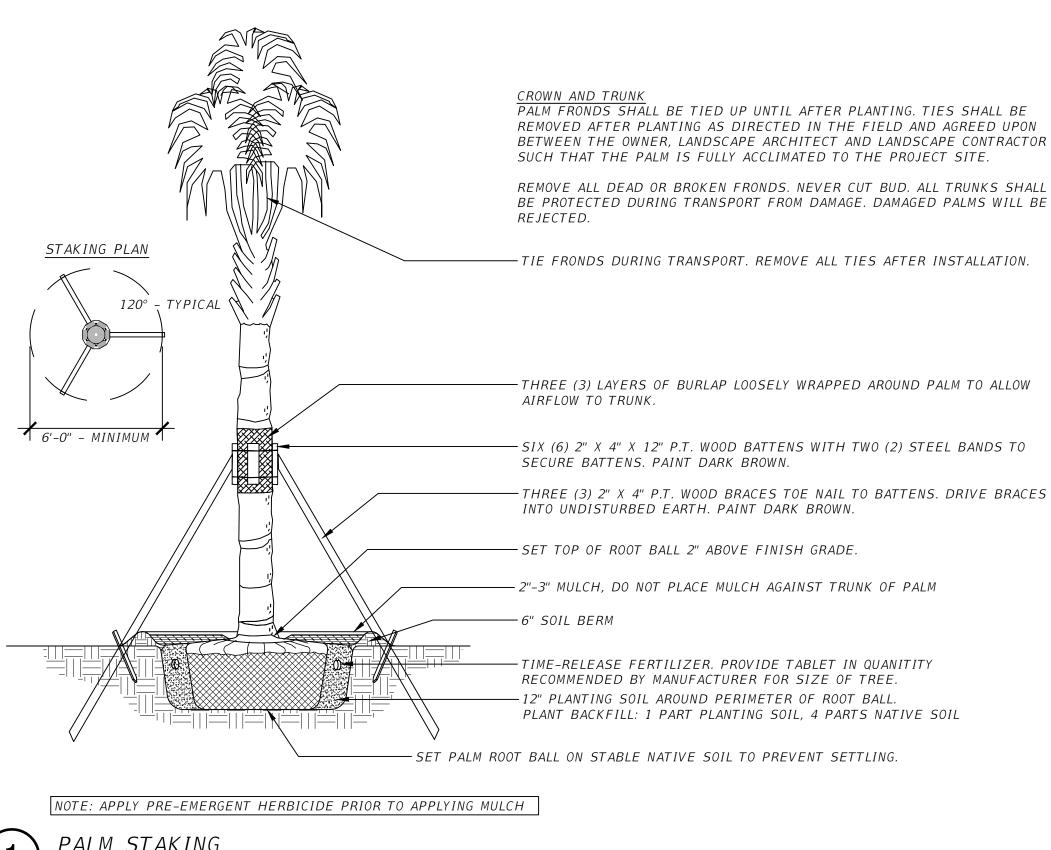



PALM STAKING

1/2'' = 1'-0''

REVISIONS DAVID R. CONNER, RLA DESCRIPTION DESCRIPTION LA0001327 DAVID CONNER + ASSOCIATES ROAD 100 E. MADISON ST, SUITE 200 TAMPA, FL 33602 CERT. OF AUTHORIZATION LC0000319


	MOBILITY DEPAR	
D NO.	COUNTY	PROJECT DESIGN NO
	LITTI CROBOLICII	21 C 00022

PLANTING DETAILS (3)

SHEET

LD-17

003293-25

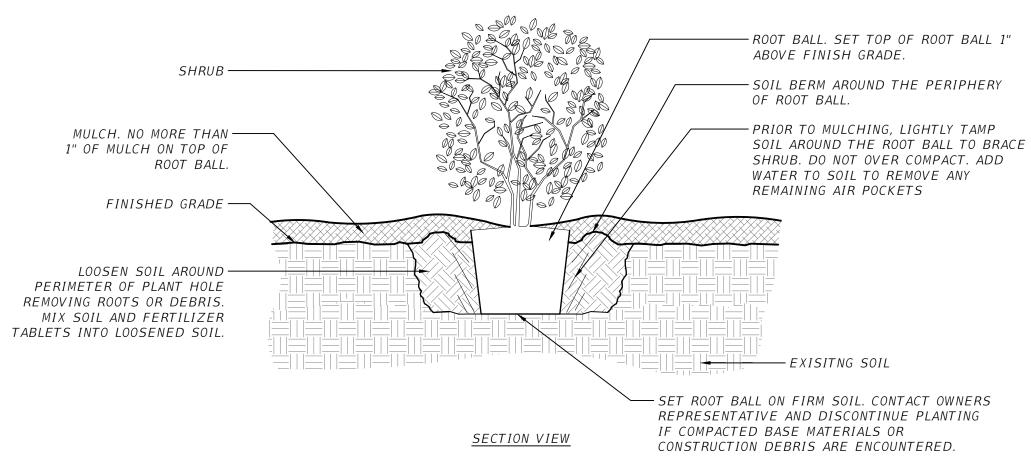

NOTE: APPLY PRE-EMERGENT HERBICIDE PRIOR TO APPLYING MULCH

SHRUB - MODIFIED SOIL

DCA-GR-06

	REVI	SIONS		DAVID R. CONNER, RLA		CITY OF TAM	ΙΡΔ		CUEET
DATE	DESCRIPTION	DATE	DESCRIPTION	LA0001327 DAVID CONNER + ASSOCIATES		MOBILITY DEPAR			SHEET NO.
				100 E. MADISON ST, SUITE 200	ROAD NO.	COUNTY	PROJECT DESIGN NO	PLANTING DETAILS (4)	
				TAMPA, FL 33602 CERT. OF AUTHORIZATION LC0000319		HILLSBOROUGH	21-C-00022		LD-18

P:\18\18=001 COT Green Spine Cycle Track\DESIGN\PRODUCTION\ACAD\BASE\COT\landscp\DETLLD01_PHASE 3C.dwg

CITY OF TAMPA MOBILITY DEPARTMENT

CONTRACT PLANS

LOCATION OF PROJECT

INDEX OF SIGNING AND PAVEMENT MARKING *PLANS*

KEY SHEET

SHEET DESCRIPTION

MARKING DETAILS

GENERAL NOTES

TABULATION OF QUANTITIES SIGNING AND PAVEMENT

SIGNING AND MARKING PLANS

SHEET NO.

5-1

5-2


5-3

5-4

S-5 THRU S-9

FINANCIAL PROJECT ID 439476-4-58-01 (FEDERAL FUNDS)

E/W GREEN SPINE CYCLE TRACK -PH. 3C FROM 13TH AVE. TO 21ST AVE.

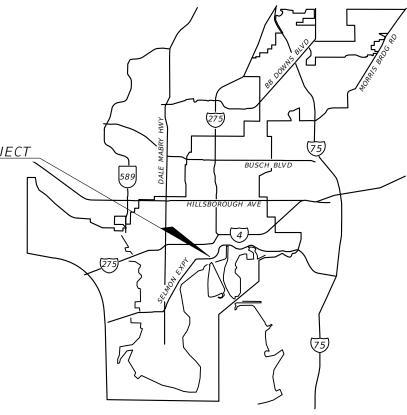

SIGNING AND PAVEMENT MARKING PLANS

FINAL SUBMITTAL FEBRUARY 2023

No.63

THIS ITEM HAS BEEN DIGITALLY SIGNED AND SEALED BY

ON THE DATE ADJACENT TO THE SEAL

PRINTED COPIES OF THIS DOCUMENT ARE NOT CONSIDERED SIGNED AND SEALED AND THE SIGNATURE MUST BE VERIFIED ON ANY ELECTRONIC COPIES.


KISINGER CAMPO & ASSOCIATES CORP. 201 N FRANKLIN ST, SUITE 400, TAMPA, FL 33602 FATHY ABDALLA, P.E. NO. 63914

CITY OF TAMPA PROJECT MANAGER:

NINA S. MABILLEAU E.I.

CONSTRUCTION	FISCAL	SHEET
CONTRACT NO.	YEAR	NO.
21-C-00022	23	S-1

PAY ITEM NO.		7,1202,11101	UF	QUAI	VT IT I E.	5														
ITEM			SHEET NUMBERS											TOTAL			AND			
NO.	DESCRIPTION	l	UNIT 15TH STREET FROM 13TH AVE TO 21ST STREET										THIS SHEET		TOT					
			Ì	5 - 5	5	S - 6	5	S-7	S	- <i>8</i>	5	. 9								
			-		FINAL P				IAL PLAN	ı			PLAN	FINAL P	LAN	FINAL	PLAN	FINAL	PLAN	FINAL
23 - 1 - 3	PATTERNED PAVEMENT, INCLUDING GREEN BIKE LANES		SY			70		58									128			
54-2-21	RECTANGULAR RAPID FLASHING BEACON, FURNISH & INSTALL- SOLAR POWERED, COMPLETE SIGN ASSEMBLY- SIN	NGLE DIRECTION	AS			2											2			
0 - 1 - 11	SINGLE POST SIGN, F&I GROUND MOUNT, UP TO 12 SF		AS	1		6		2	1								10			
) - 1 - 12	SINGLE POST SIGN, F&I GROUND MOUNT, 12-20 SF		AS					1									1			
- 1 - 18	SINGLE POST SIGN, F&I GROUND MOUNT, IN-STREET FLEXIBLE POST SIGN		AS	1		4		3									8			
	SINGLE POST SIGN, RELOCATE		AS					4	2								6			
	SINGLE POST SIGN, REMOVE		AS			2		5	1								8			
	DELINEATOR, FLEXIBLE HIGH VISABILITY MEDIAN PAINTED PAVEMENT MARKINGS, FINAL SURFACE		EA	1		9		5									15			
			LS	2				30	50								00			
	RAISED PAVEMENT MARKER, TYPE B		EA	2		8		30	50							-	90			
	PAINTED PAVEMENT MARKINGS, STANDARD, WHITE, SOLID, 6"		GM		- 0	. 123		0.185	0.227		0.127						0.662			
*	PAINTED PAVEMENT MARKINGS, STANDARD, WHITE, SOLID FOR INTERCHANGE AND URBAN ISLAND, 8"		GM		0	.003		0.003	0.069		0.040						0.115			
*	PAINTED PAVEMENT MARKINGS, STANDARD, WHITE, SOLID FOR CROSSWALK AND ROUNDABOUT, 12"		LF			68		510			174						752			
*	PAINTED PAVEMENT MARKINGS, STANDARD, WHITE, SOLID FOR DIAGONAL OR CHEVRON, 18"		LF					9	182		116						307			
*	PAINTED PAVEMENT MARKINGS, STANDARD, WHITE, SOLID FOR STOP LINE OR CROSSWALK, 24"		LF	4		119		617	38		188						966			
*	PAINTED PAVEMENT MARKINGS, STANDARD, WHITE, SKIP, 10-30 OR 3-9 SKIP, 6" WIDE		GM	0.023	C	. 106		0.045			0.061						0.235			
*	PAINTED PAVEMENT MARKINGS, STANDARD, WHITE, 2-4 DOTTED GUIDELINE, 6"		GM		(. 151		0.104									0.255			
*	PAINTED PAVEMENT MARKINGS, STANDARD, WHITE, MESSAGE OR SYMBOL		EA	2		8		10									20			
	PAINTED PAVEMENT MARKINGS, STANDARD, WHITE, ARROWS		EA	2		8		11									21			
						0.40			0.022		0.000					-				
	PAINTED PAVEMENT MARKINGS, STANDARD, YELLOW, SOLID, 6"		GM	0.028	- 1	.049		0.077	0.032		0.008						0.194			
	PAINTED PAVEMENT MARKINGS, STANDARD, YELLOW, SOLID FOR DIAGONAL OR CHEVRON, 18"		LF	138		288		42									468			
*	PAINTED PAVEMENT MARKINGS, STANDARD, YELLOW, SKIP, 6"		GM	0.018	0	.059		0.045									0.122			
	PAINTED PAVEMENT MARKINGS, STANDARD, YELLOW, ISLAND NOSE		SF	4		25		15									44			
11-123	THERMOPLASTIC, STANDARD, WHITE, SOLID, 12" FOR CROSSWALK AND ROUNDABOUT		LF			68		510			174						752			
11-124	THERMOPLASTIC, STANDARD, WHITE, SOLID, 18" FOR DIAGONALS AND CHEVRONS		LF					9	182		116						307			
- 11 - 125	THERMOPLASTIC, STANDARD, WHITE, SOLID, 24" FOR STOP LINE AND CROSSWALK		LF	4		119		107	38		28						294			
11-141	THERMOPLASTIC, STANDARD, WHITE, 2-4 DOTTED GUIDELINE/ 6-10 GAP EXTENSION, 6"		GM		(. 151		0.104									0.255			
	THERMOPLASTIC, STANDARD, WHITE, MESSAGE OR SYMBOL		EA					3									3			
	THERMOPLASTIC, STANDARD, WHITE, ARROW		EA	2		8		11									21			
	THERMOPLASTIC, STANDARD, YELLOW, SOLID, 18" FOR DIAGONAL OR CHEVRON		LF	138		288		42									468			
	THERMOPLASTIC, PREFORMED, WHITE, SOLID, 24" FOR CROSSWALK THERMOPLASTIC, PREFORMED, WHITE, SYMBOL (BIKE)		LF					510			160						670			
	THERMOPLASTIC, PREFORMED, WHITE, SYMBOL (BIKE) THERMOPLASTIC, STANDARD-OTHER SURFACES, WHITE, SOLID, 6"		EA GM	2		. 123		0.185	0.227		0.127					+	0.662			
	THERMOPLASTIC, STANDARD-OTHER SURFACES, WHITE, SOLID, 6 THERMOPLASTIC, STANDARD-OTHER SURFACES, WHITE, SOLID, 8"		GM GM			.003		0.003	0.227		0.127					-	0.002			
	THERMOPLASTIC, OTHER SURFACES, WHITE, SKIP, 6".10-30 SKIP OR 3-9 LANE DROP		GM	0.023		. 106		0.045	0.003		0.040						0.113			
	THERMOPLASTIC, STANDARD-OTHER SURFACES, YELLOW, SOLID, 6"		GM	0.028		.049		0.077	0.032		0.008						0.194			
	THERMOPLASTIC, STANDARD-OTHER SURFACES, YELLOW, SOLID, 8"		GM					0.003	1.002								0.003			
	THERMOPLASTIC, STANDARD-OTHER SURFACES, YELLOW, SKIP, 6", 3-9 SKIP			0.018																

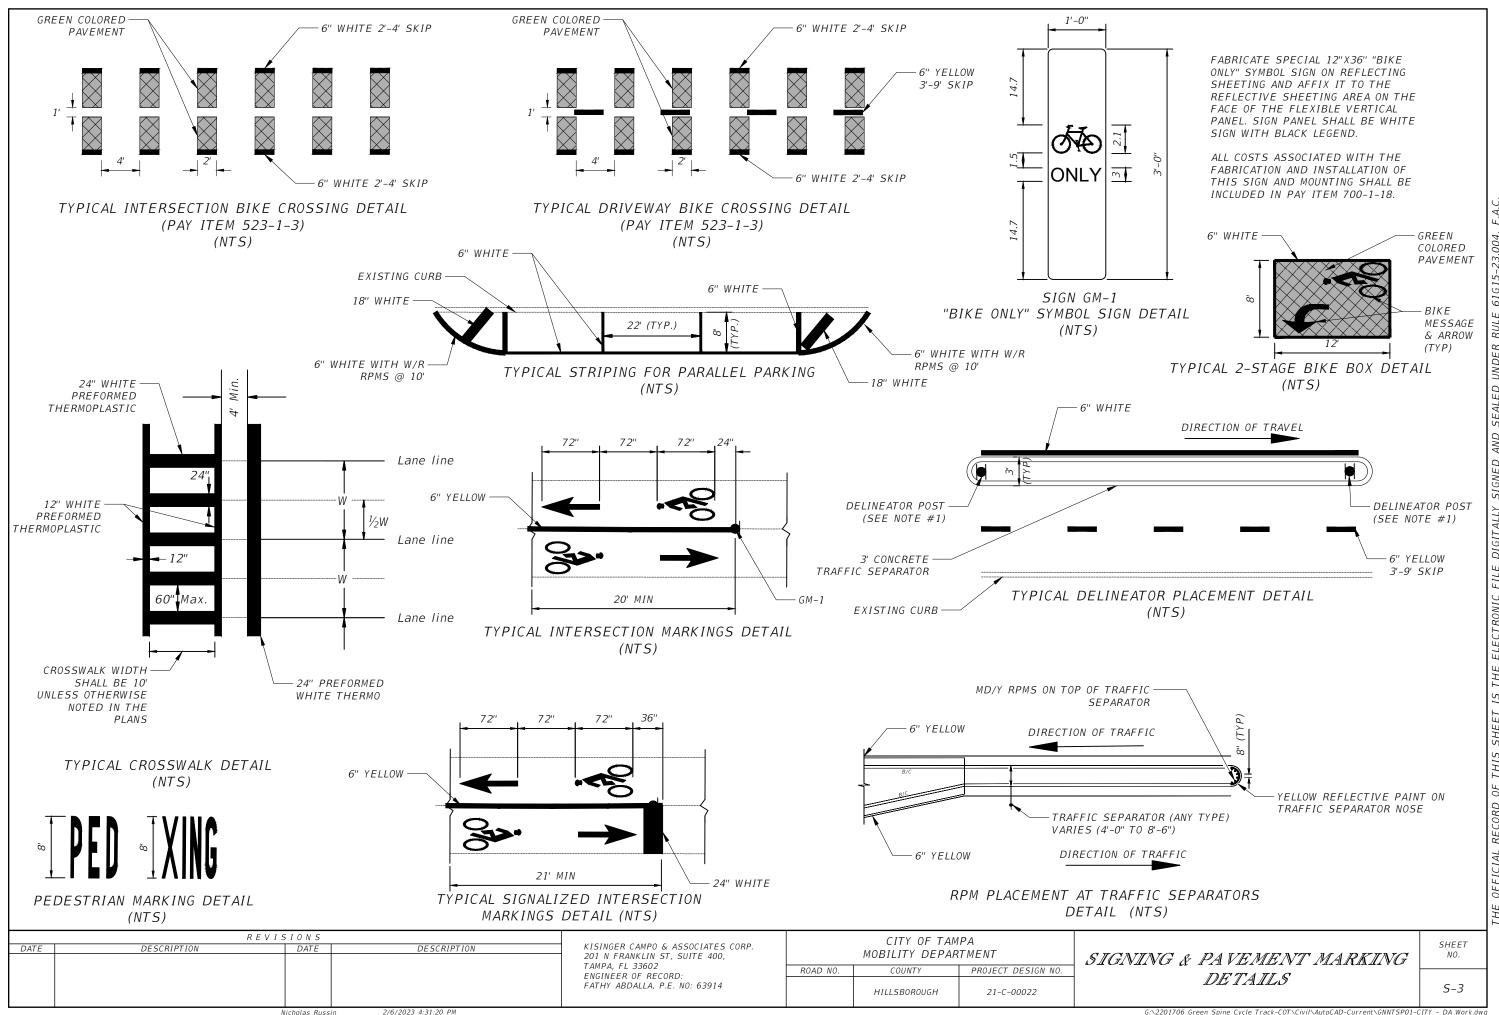

GENERAL NOTES:

- 1. USE YELLOW RETRO-REFLECTIVE SHEETING ON BOTH SIDES OF THE DELINEATOR. INSTALL THE POST SO THAT THE TOP IS 4' ABOVE THE GRADE AT THE EDGE OF THE PAVEMENT.
- 2. ALL PEDESTRIAN/BICYCLE WARNING SHALL BE IN ACCORDANCE WITH THE MUTCD, SECT. 1A-12, COLOR CODE "F"-FLUORESCENT YELLOW-GREEN.
- 3. PAVEMENT MARKINGS ON ASPHALT PAVEMENT SHALL BE STANDARD THERMOPLASTIC EXCEPT FOR BICYCLE MARKINGS AND SPECIAL EMPHASIS CROSSWALKS. USE PREFORMED THERMOPLASTIC FOR BICYCLE MARKINGS AND SPECIAL EMPHASIS CROSSWALKS.
- 4. UNLESS OTHERWISE NOTED ON PLAN SHEETS, ALL PROPOSED CROSSWALKS ACROSS MAIN STREETS SHALL BE 10' IN WIDTH AND ALL CROSSWALKS ACROSS SIDE STREETS SHALL BE 6' IN WIDTH. MEASUREMENTS SHALL BE FROM INSIDE TO INSIDE OF 12" STRIPES.
- 5. PAY ITEM FOOT NOTE 710-90 SHALL INCLUDE ALL PAVEMENT MARKINGS APPLICATIONS NEEDED BEFORE APPLYING THE THERMOPLASTIC APPLICATION.
- 6. ALL BRICK STREETS AND GRANITE CURBS SHALL BE RETAINED AND PRESERVED IN PLACE.

	REVIS	5 I O N S	
DATE	DESCRIPTION	DATE	DESCRIPTION


KISINGER CAMPO & ASSOCIATES CORP. 201 N FRANKLIN ST, SUITE 400, TAMPA, FL 33602 ENGINEER OF RECORD: FATHY ABDALLA, P.E. NO: 63914


CITY OF TAMPA MOBILITY DEPARTMENT PROJECT DESIGN NO. ROAD NO. COUNTY HILLSBOROUGH 21-C-00022


GENERAL NOTES


SHEET


5-4

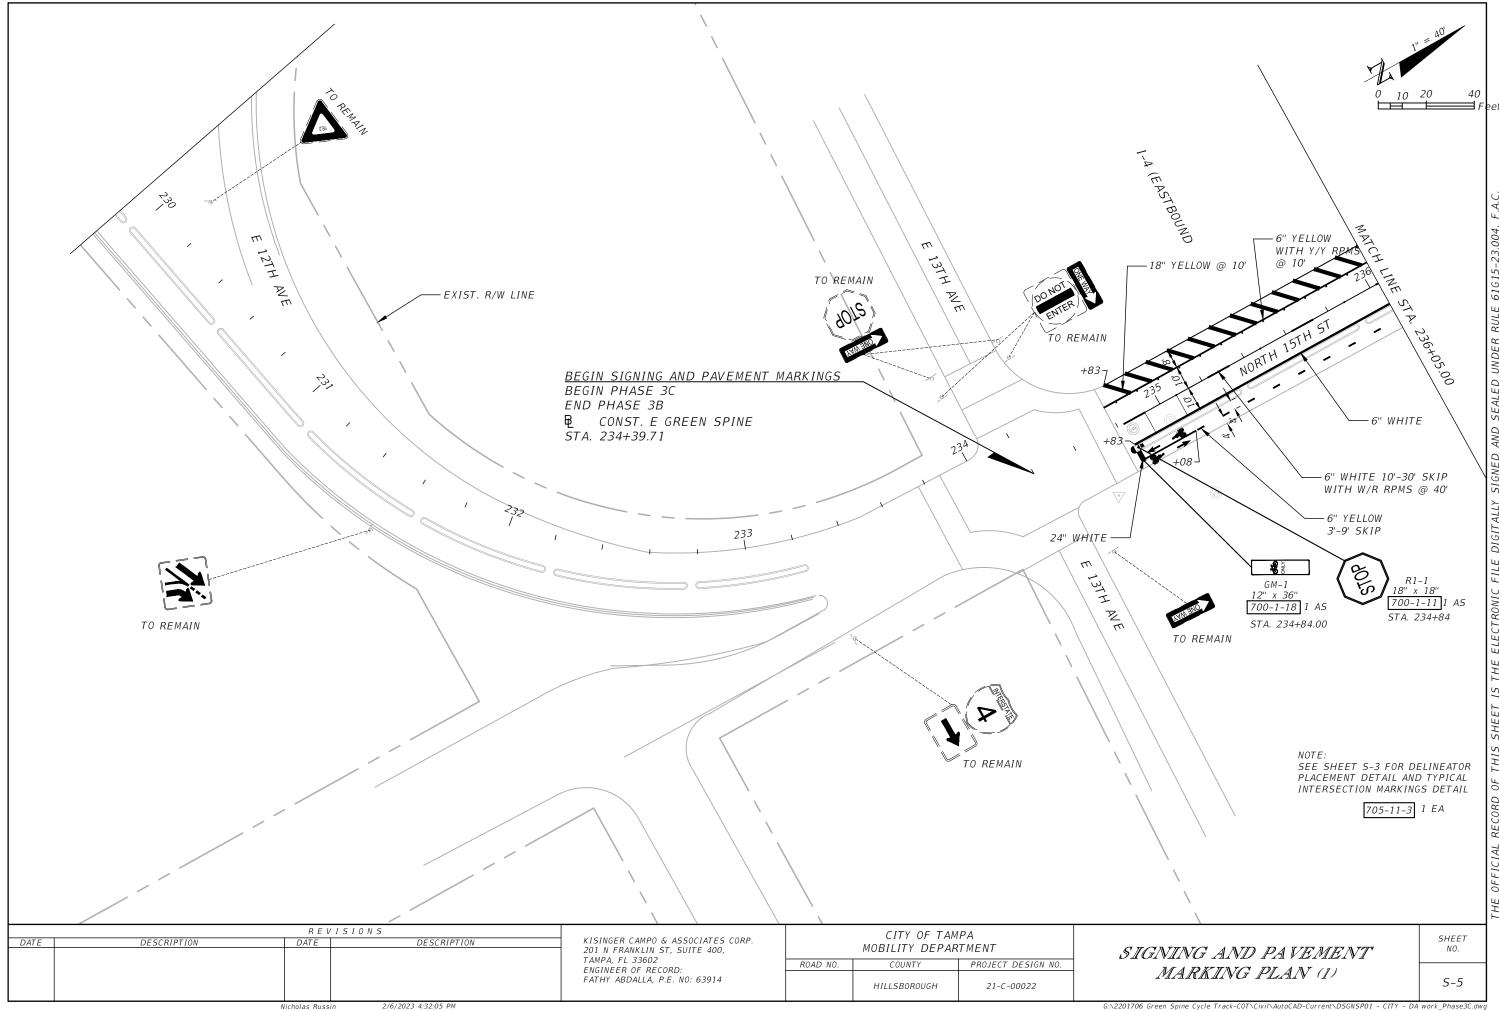

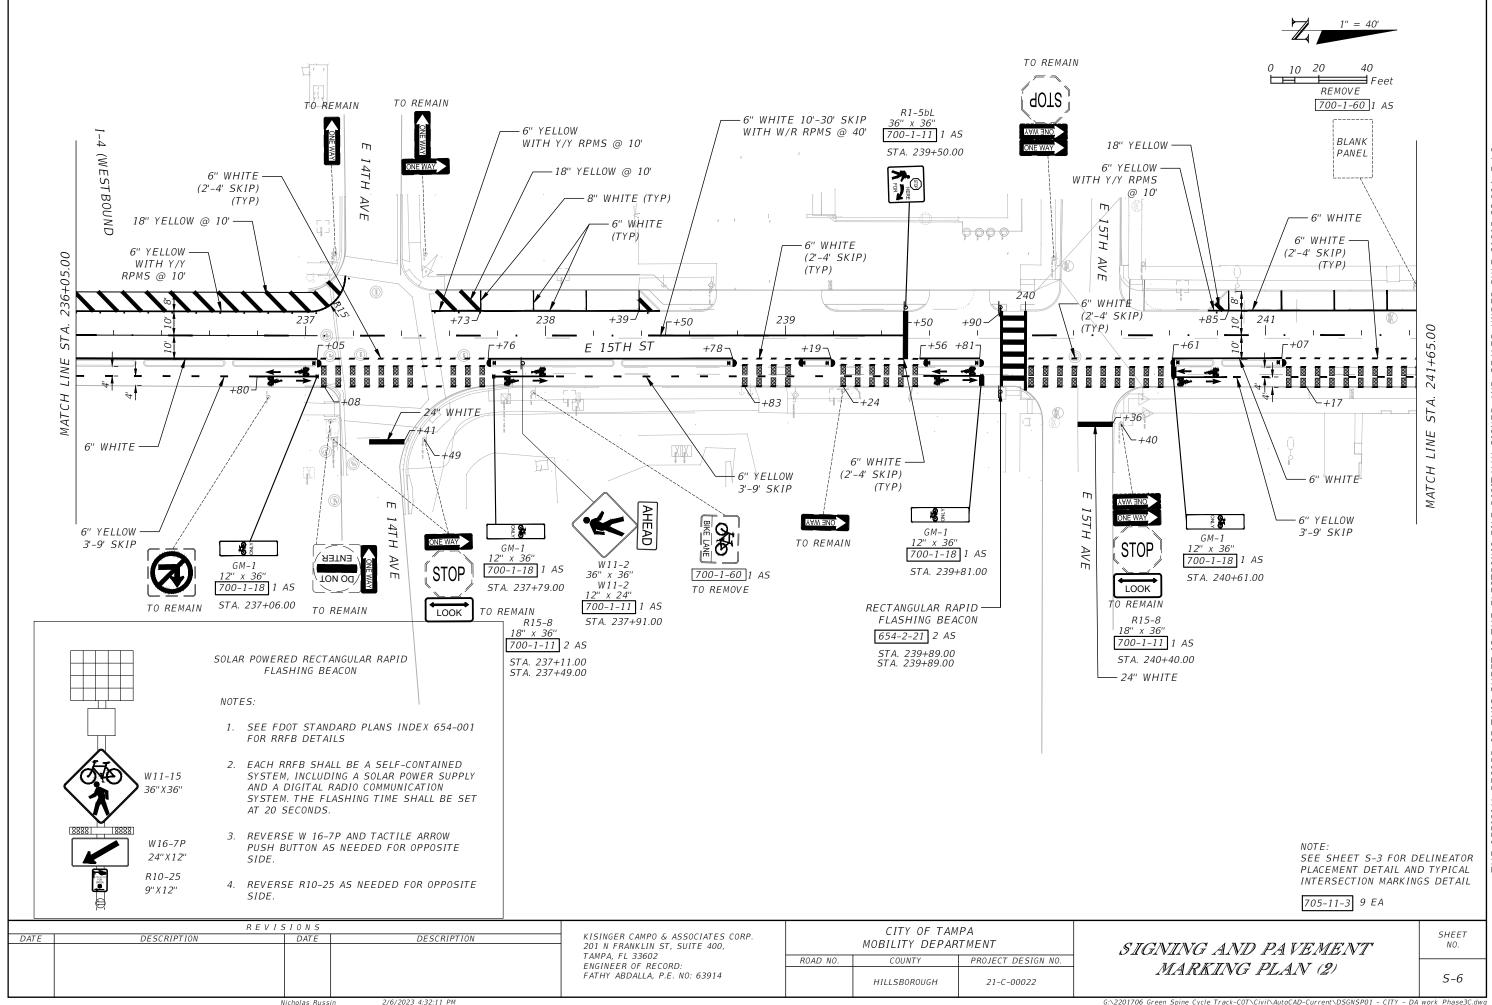

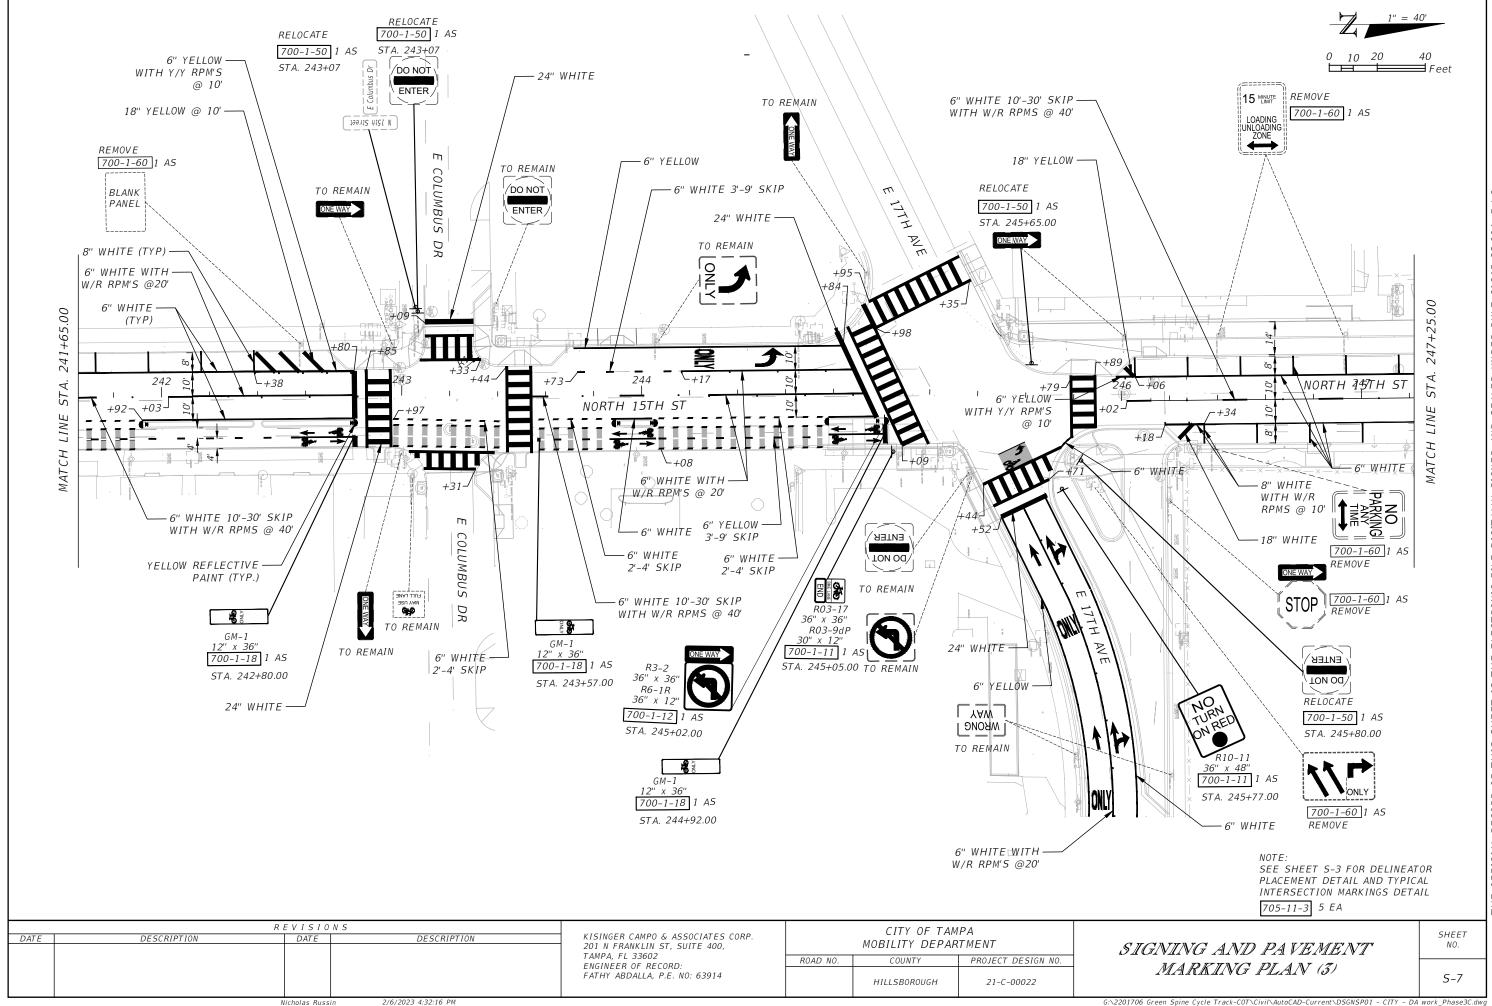

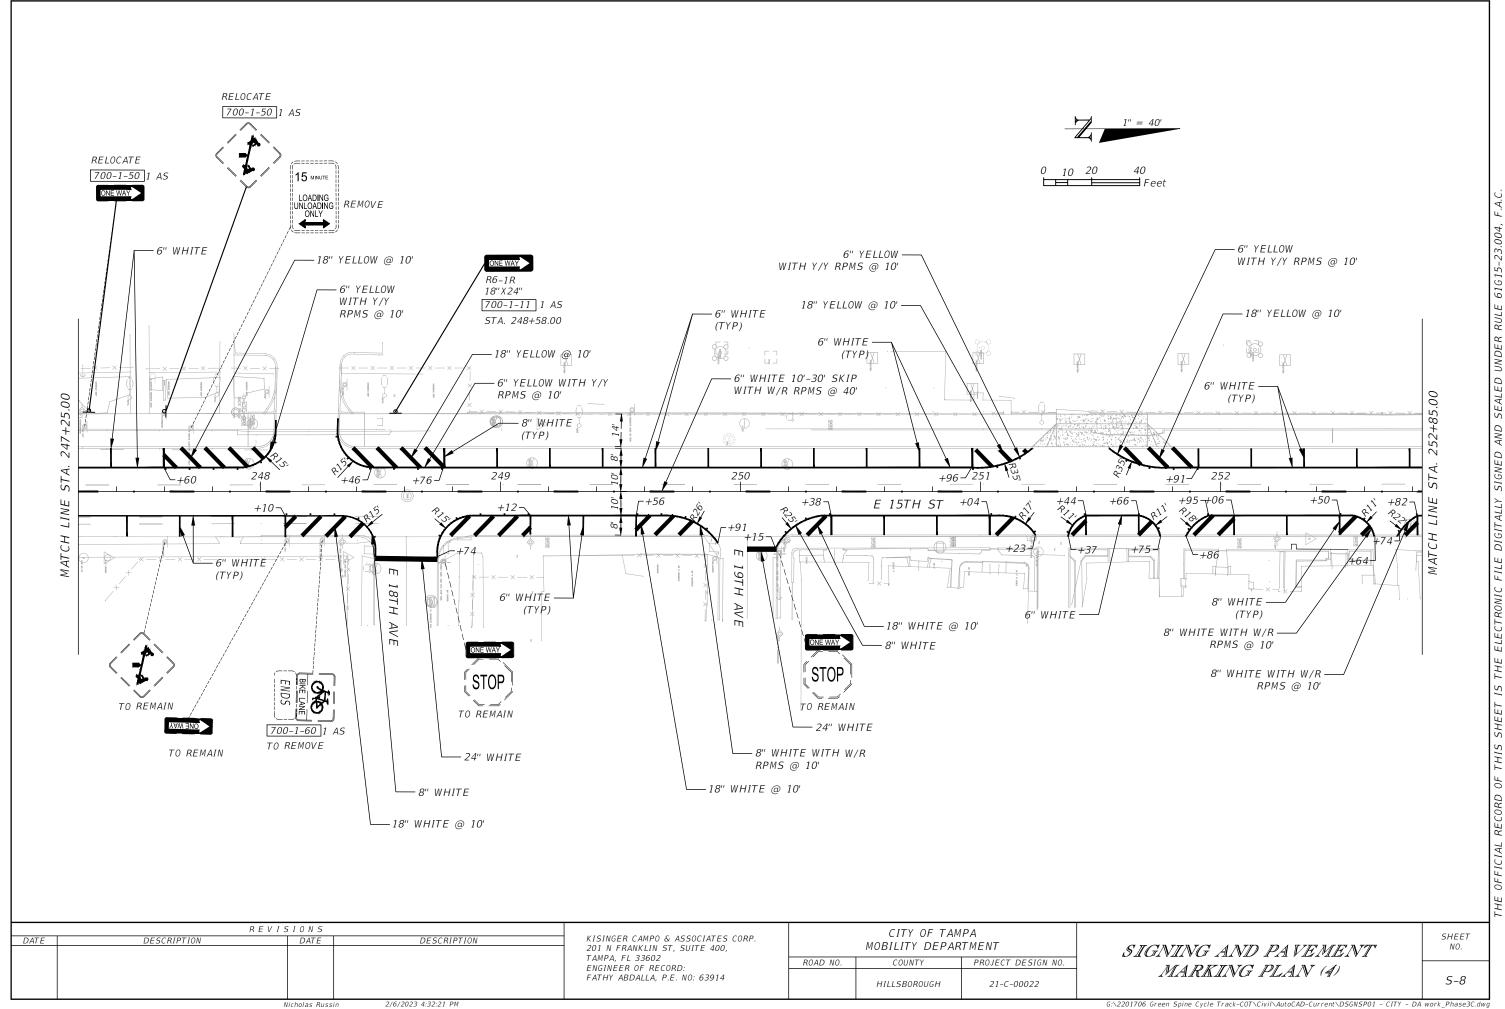

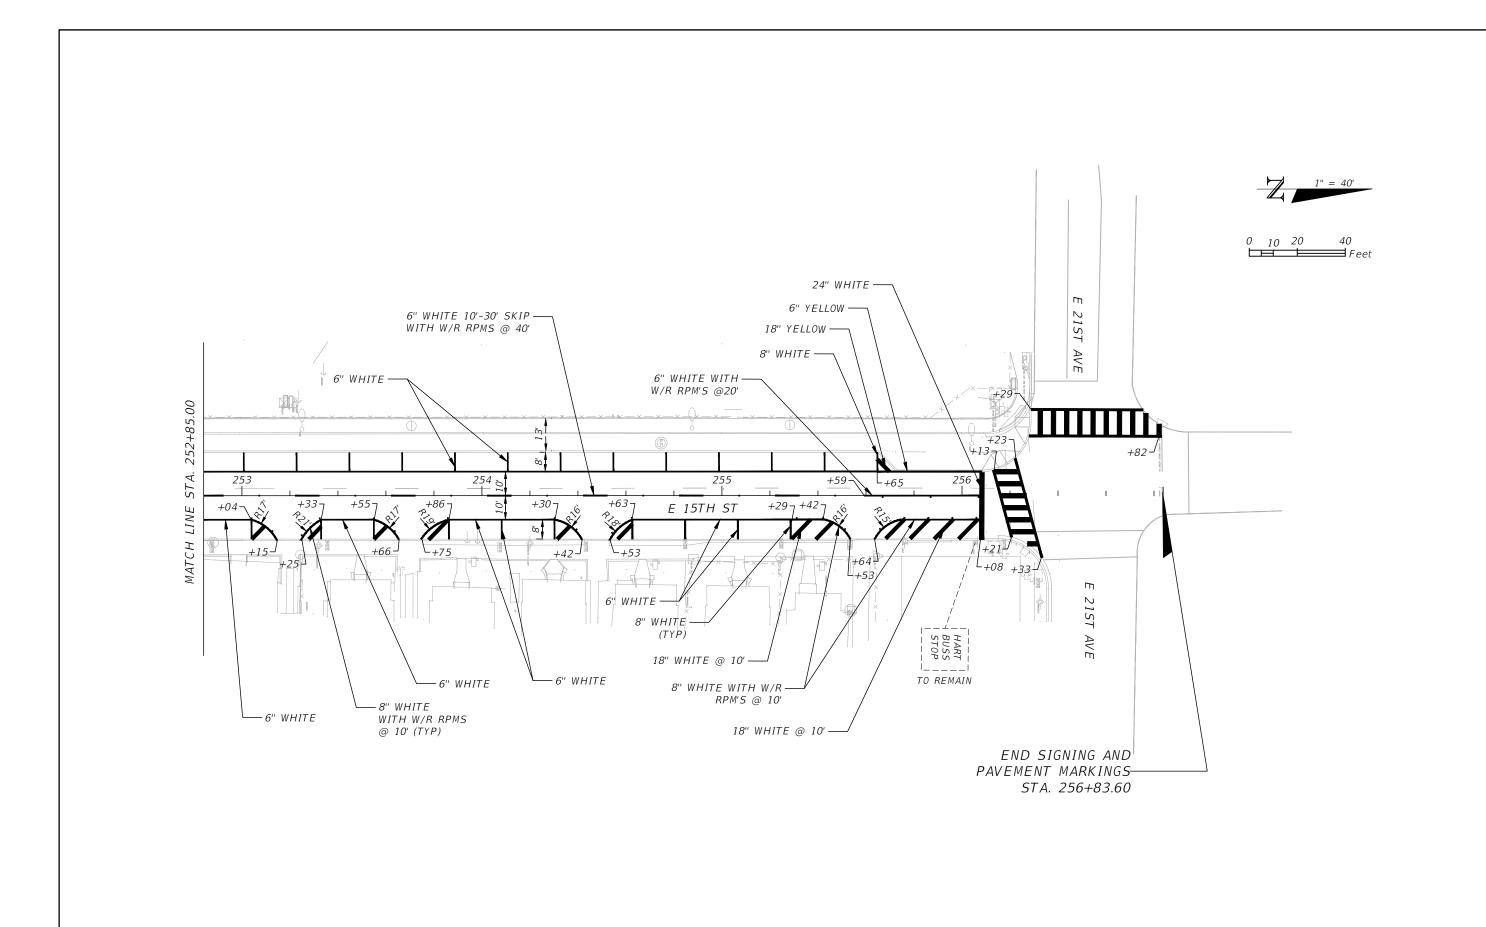

	REVISIONS							
DATE	DESCRIPTION	DATE	DESCRIPTION					
	Nicholae Buscin 2/6/2023 4/32/27 PM							

CITY OF TAMPA
MOBILITY DEPARTMENT

ROAD NO. COUNTY PROJECT DESIGN NO.

HILLSBOROUGH 21-C-00022

SIGNING AND PAVEMENT MARKING PLAN (5) SHEET NO.

5-9

CITY OF TAMPA MOBILITY DEPARTMENT

CONTRACT PLANS

LOCATION OF PROJECT

INDEX OF SIGNALIZATION PLANS

SHEET NO. SHEET DESCRIPTION

T – 1 KEY SHEET

T-2 TABULATION OF QUANTITIES


T-3 GENERAL NOTES

T-4 THRU T-5 SIGNALIZATION PLANS (FEDERAL FUNDS)


FINANCIAL PROJECT ID 439476-4-58-01

2. E/W GREEN SPINE CYCLE TRACK -PH. 3C FROM 13TH AVE. TO 21ST AVE.

SIGNALIZATION PLANS

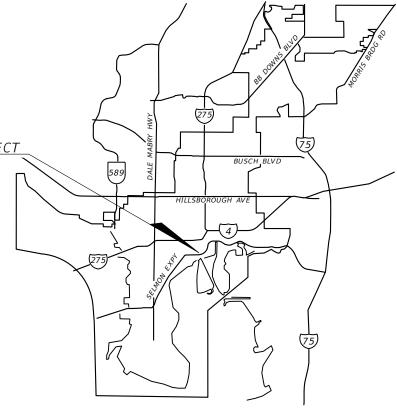

FINAL SUBMITTAL FEBRUARY 2023

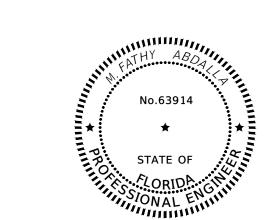

THIS ITEM HAS BEEN DIGITALLY SIGNED AND SEALED BY

ON THE DATE ADJACENT TO THE SEAL

PRINTED COPIES OF THIS DOCUMENT ARE NOT CONSIDERED SIGNED AND SEALED AND THE SIGNATURE MUST BE VERIFIED ON ANY ELECTRONIC COPIES.

KISINGER CAMPO & ASSOCIATES CORP. 201 N FRANKLIN ST, SUITE 400, TAMPA, FL 33602

FATHY ABDALLA, P.E. NO. 63914

CITY OF TAMPA PROJECT MANAGER:

NINA S. MABILLEAU E.I.

CONSTRUCTION	FISCAL	SHEET
CONTRACT NO.	YEAR	NO.
21-C-00022	23	T-1

			TABL	JLATION	OF QL	JANT IT I E	S										
								SHEET	NUMBERS								
PAY ITEM	DESCRIPTION	UNIT	Т	- 4	Т	- 5										GRA TO	
NO.			PLAN	FINAL	PLAN	FINAL	PLAN	FINAL	PLAN	FINAL	PLAN	FINAL	PLAN	FINAL		PLAN	FINAL
630-2-11	CONDUIT, FURNISH & INSTALL, OPEN TRENCH	LF	15		135											150	
630-2-12	CONDUIT, FURNISH & INSTALL, DIRECTIONAL BORE	LF	155		36											191	
632-7-2	SIGNAL CABLE- REPAIR/REPLACE/OTHER, FURNISH & INSTALL	LF	135		765											900	
635-2-11	PULL & SPLICE BOX, F&I, 13" x 24" COVER SIZE	EA	3		4											7	
646-1-11	ALUMINUM SIGNALS POLE, PEDESTAL	EA	2		2											4	
646 - 1 - 40	ALUMINUM SIGNALS POLE, RELOCATE	EA			4											4	
646 - 1 - 60	ALUMINUM SIGNALS POLE, REMOVE	EA			1											1	
650 - 1 - 14	VEHICULAR TRAFFIC SIGNAL, FURNISH & INSTALL ALUMINUM, 3 SECTION, 1 WAY	AS	4													4	
653 - 1 - 1	PEDESTRIAN SIGNAL, FURNISH & INSTALL LED COUNTDOWN, 1 WAY	AS			2											2	
670-5-400	TRAFFIC CONTROLLER ASSEMBLY, MODIFY	AS	1		1											2	

	REVIS	10NS	
DATE	DESCRIPTION	DATE	DESCRIPTION

CITY OF TAMPA
MOBILITY DEPARTMENT

ROAD NO. COUNTY PROJECT DESIGN NO.

HILLSBOROUGH 21-C-00022

TABULATION OF QUANTITIES

SHEET NO.

T-2

GENERAL NOTES:

- 1. ALL RELOCATED PED POLES SHALL BE GROUNDED WITHIN THE FOUNDATION OF THE POLES OR WITHIN THE PULL BOX IF WITHIN 10 FEET FROM THE POLE LOCATION.
- 2. CONTRACTOR IS RESPONSIBLE TO REPLACE ANY DAMAGE EQUIPMENT DUE TO RELOCATION WITH NO ADDITIONAL COMPENSATION.
- 3. ALL BICYCLE POLES MUST HAVE A SUPPORT COLLAR WITH ROLL PINS.

	R	EVISIONS		
DATE	DESCRIPTION	DATE	DESCRIPTION	KISINGER C
				201 N FRAN TAMPA, FL 3
				ENGINEER O FATHY ABDA

KISINGER CAMPO & ASSOCIATES CORP. 201 N FRANKLIN ST, SUITE 400, TAMPA, FL 33602 ENGINEER OF RECORD: FATHY ABDALLA, P.E. NO: 63914 CITY OF TAMPA
MOBILITY DEPARTMENT

ROAD NO. COUNTY PROJECT DESIGN NO.


HILLSBOROUGH 21-C-00022

GENERAL NOTES

SHEET NO.


T-3

Nicholas Russin 2/6/2023 4:35:41 PM

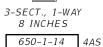



3-SECT., 1-WAY EXISTING

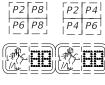

PED. SIGNAL
COUNT-DOWN
1-SECT., 2-WAY
EXISTING




PED. SIGNAL
COUNT-DOWN
1-SECT., 1-WAY
EXISTING




NOTES AND CONTROLLER OPERATIONS:

- 1. MAJOR STREET IS N. 15TH STREET AND MINOR STREET IS E. COLUMBUS DRIVE.
- 2. POSTED SPEED ON BOTH ROADWAYS IS 30 MPH.
- 3. ALL PED SIGNALS SHALL CONTINUE TO RUN ON RECALL.
- 4. FLASHING OPERATION SHALL BE: YELLOW FOR MOVEMENTS 2, 6 & B6W RED FOR MOVEMENTS 4 & 8
- 5. SIGNAL HEAD B6W FOR WESTBOUND BICYCLISTS SHALL BE MOUNTED ON STANDARD ALUMINUM PEDESTRIAN PEDESTAL.

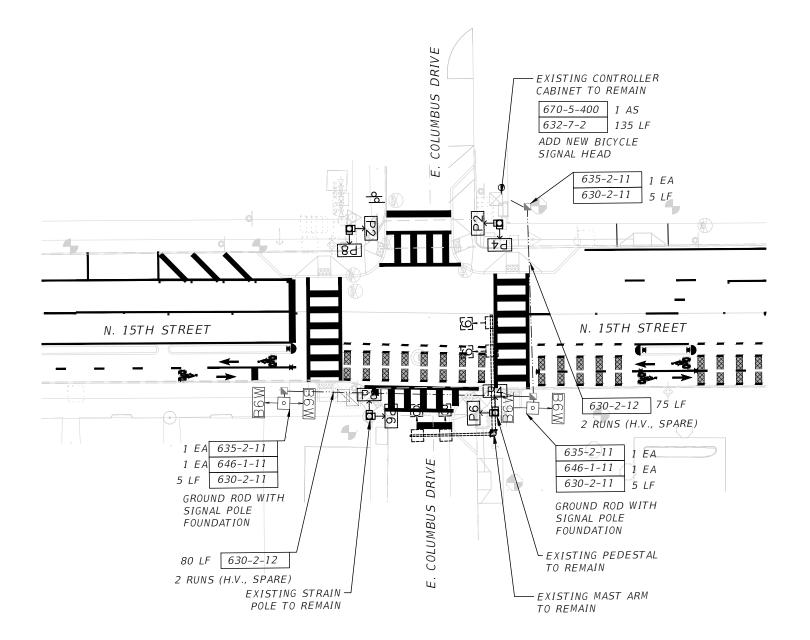

DATE	R E V I DESCRIPTION	S I O N S DATE	DESCRIPTION	KISINGER CAMPO & ASSOCIATES CORP. 201 N FRANKLIN ST, SUITE 400,		CITY OF TAM MOBILITY DEPAR		Signalization plan (1)	SHEET NO.
				TAMPA, FL 33602 ENGINEER OF RECORD:	ROAD NO.	COUNTY	PROJECT DESIGN NO.	7	
				FATHY ABDALLA, P.E. NO: 63914		HILLSB0R0UGH	21-C-00022	E. Columbus Dr. & N. 15th St	T-4

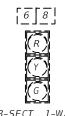







PED. SIGNAL COUNT-DOWN 1-SECT., 1-WAY EXISTING




PED. SIGNAL
COUNT-DOWN
1-SECT., 1-WAY

653-1-1 2 AS

NOTES AND CONTROLLER OPERATIONS:

- 1. MAJOR STREET IS N. 15TH STREET AND MINOR STREET IS E. 17TH AVENUE.
- 2. POSTED SPEED ON ALL ROADWAYS IS 30 MPH.
- 3. ALL PED SIGNALS SHALL CONTINUE TO RUN ON RECALL.
- 4. FLASHING OPERATION SHALL BE: YELLOW FOR MOVEMENTS 2, 6 RED FOR MOVEMENTS 4 & 8

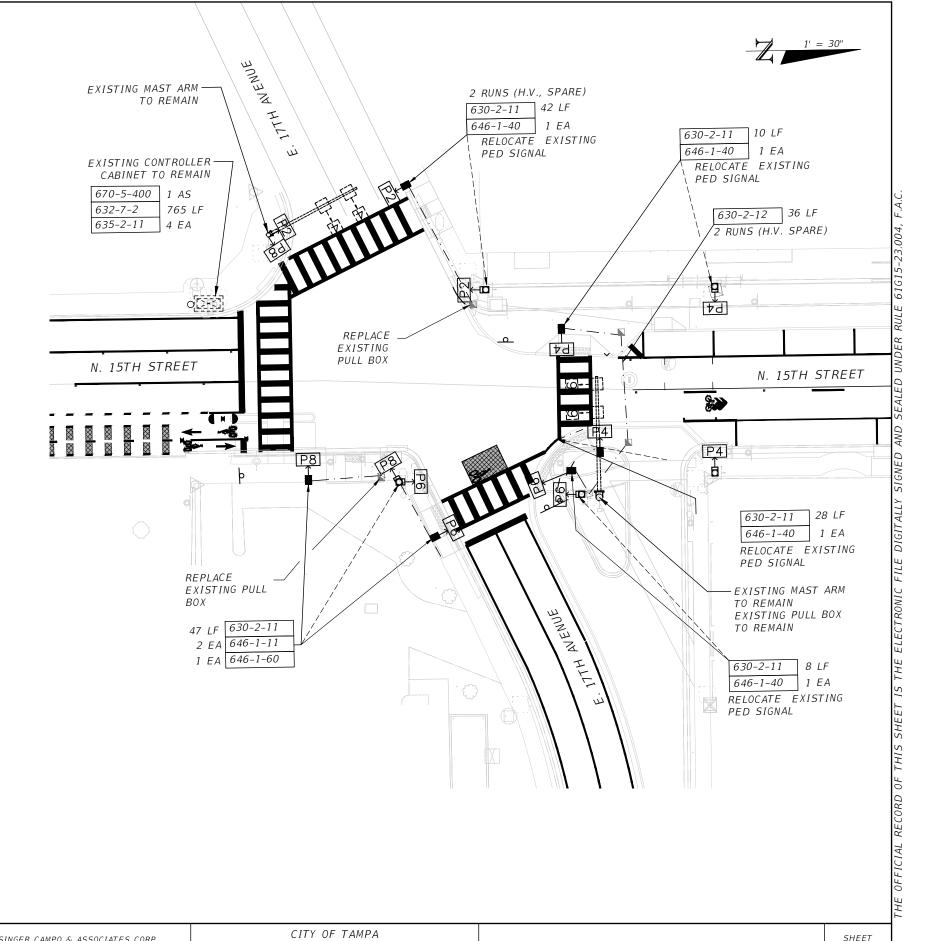

	REVISIONS								
DATE	DESCRIPTION	DATE	DESCRIPTION						
1									

KISINGER CAMPO & ASSOCIATES CORP. 201 N FRANKLIN ST, SUITE 400, TAMPA, FL 33602 ENGINEER OF RECORD: FATHY ABDALLA, P.E. NO: 63914

MOBILITY DEPARTMENT							
ROAD NO.	COUNTY	PROJECT DESIGN NO.					
	HILLSBOROUGH	21-C-00022					

Signalization plan (2) E. 17th Avenue & N. 15th St